# BH 151 7842 N. Bel Haven Lane

1 story slab
1 small tankless heater
3 Hose bibs - no valves required
2 - tile shower drain
Irrigation system
Ice maker
Humidifier valve
Laundry Tub
Slide bar handheld sprayer in master bath

Gas Furnace, Tankless Heater, Fireplace and Outside Grill



## BH 151

MASTER PLAN: Promenade | ELEVATION: Elev B - Hip Roof | COMMUNITY: Bel Haven | LOT NUMBER: 151 | ADDRESS: 7842 N. Bel Haven Lane, West Chester, Ohio 45069

PLANS POWERED BY HIGHARC

PROJECT SUMMARY		GENERAL NOTES
BUILDING AREA		ONLY LOCATION SPECIFIC OPTIONS ARE SHOWN ON THESE DRAWINGS. PLEASE REFER TO OPTION SUMMARY AND/OR PURCHASE ORDERS FOR A COMPLETE LISTING OF OPTIONS.
CONDITIONED AREA		
FIRST FLOOR SF	2162 SF	DEGION ODITEDIA
TOTAL CONDITIONED AREA :	2162 SF	DESIGN CRITERIA:
		NUMBER OF STORIES: 1
		BUILDING WIDTH: 42'-4"
TOTAL GARAGE AREA :	551 SF	BUILDING DEPTH: 83'-4"
FRONT PORCH AND PORTICO AREA :	183 SF	BUILDING HEIGHT: 21'-10 1/2"
REAR PORCH AREA :	299 SF	
PATIO AREA:	191 SF	
		GOVERNMENTAL CODES AND STANDARDS
		HOME TO BE BUILT TO CONFORM TO ALL APPLICABLE LOCAL CODES, PRACTICES AND STANDARDS.
		BUILDING CODE ANALYSIS / DESIGN CRITERIA
		HOME TO BE BUILOT TO 2019 RESIDENTIAL CODE OF OHIO STANDARDS

GRAPHIC SYMBOLS & LEGEND			
FIRST FLOOR EL. 0'-0"	ELEVATION MARKER		
SLOPE 4:12	ROOF SLOPE		
(i)	SD		
	SD / CO		

COVER	A-000
SCHEDULES	A-010
GENERAL NOTES	A-020
FOUNDATION PLAN	A-050
FIRST FLOOR PLAN	A-101
ROOF PLAN	A-120
FRONT / BACK ELEVATION	A-200
LEFT / RIGHT ELEVATION	A-201
DETAILS	A-401
DETAILS	A-402
DETAILS	A-403
DETAILS	A-404
DETAILS	A-405
PERSPECTIVE VIEWS	A-900
FIRST FLOOR ELECTRICAL PLAN	E-101
SHEAR WALL DETAILS	S-100
SHEAR WALL PLAN	S-101

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Epcon Foundation DG

Bel Haven LLC West Chester, OH.

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ISSUE	DESCRIPTION	DATE
01	BUILDER SET	12/16/2024

PROJECT
PLAN: BH Promenade D3
ELEV: Elev B - Hip Roof
LOT: 151


DRAWING TITLE

COVER

A-000

SHEET NUMBER

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NOTES: THICKENED SLAB SHALL BE REINFORCED WITH CONTINUOUS (2) #4 REBAR

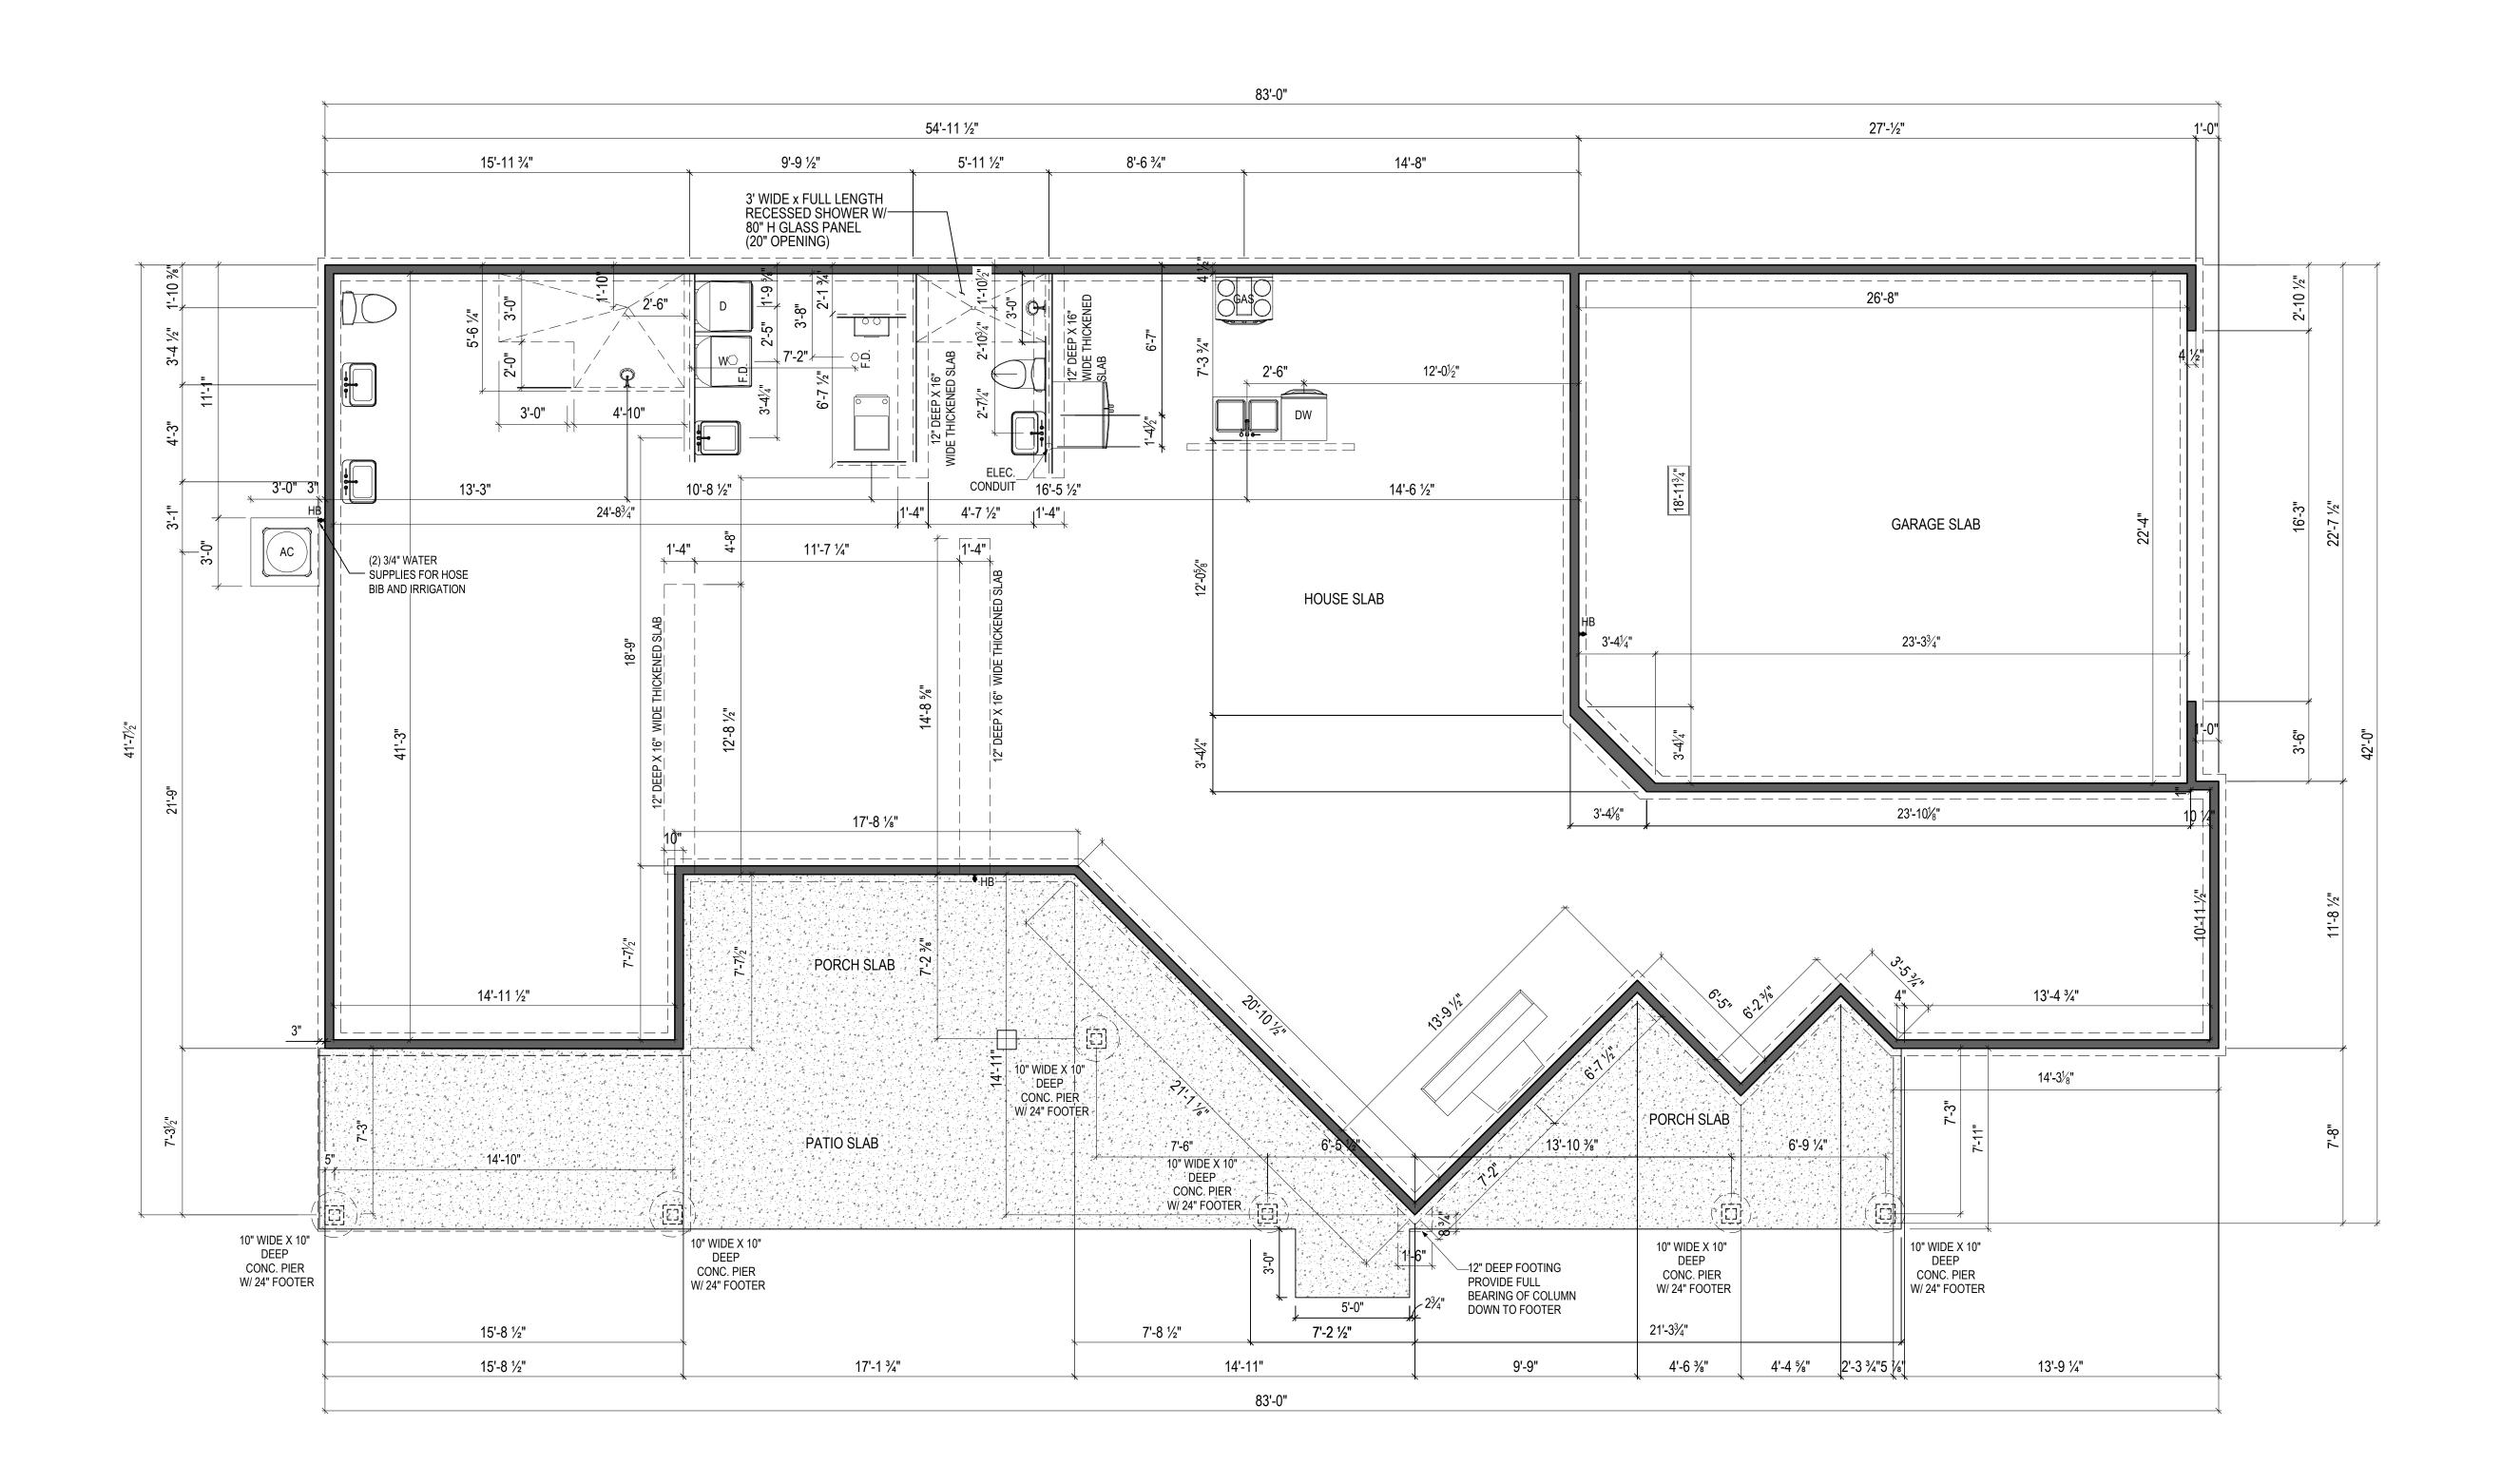

FOUNDATION PLAN

1/8" = 1'-0" @ 11" x 17"



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ISSUE	DESCRIPTION	DATE
01	BUILDER SET	12/16/2024

PROJECT

PLAN: BH Promenade D3
ELEV: Elev B - Hip Roof
LOT: 151

DRAWING TITLE

FOUNDATION PLAN

SHEET NUMBER

A-050

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- NOTES:
  1.) ARCHED OPENINGS: SPRING POINT @ 7'8"
  A.A.F. TOP OF ARCH 8'-6" ABOVE SPRING
- POINT.

  2.) WINDOWS R.O. HEAD HEIGHT TO BE 8'-0" A.F.F. U.N.O.


  3.) DISTANCE BETWEEN GROUPED WINDOWS



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PLAN: BH Promenade D3 ELEV: Elev B - Hip Roof LOT: 151


DRAWING TITLE

FIRST FLOOR PLAN

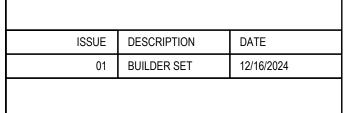SHEET NUMBER


A-101


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FLOOR PLAN

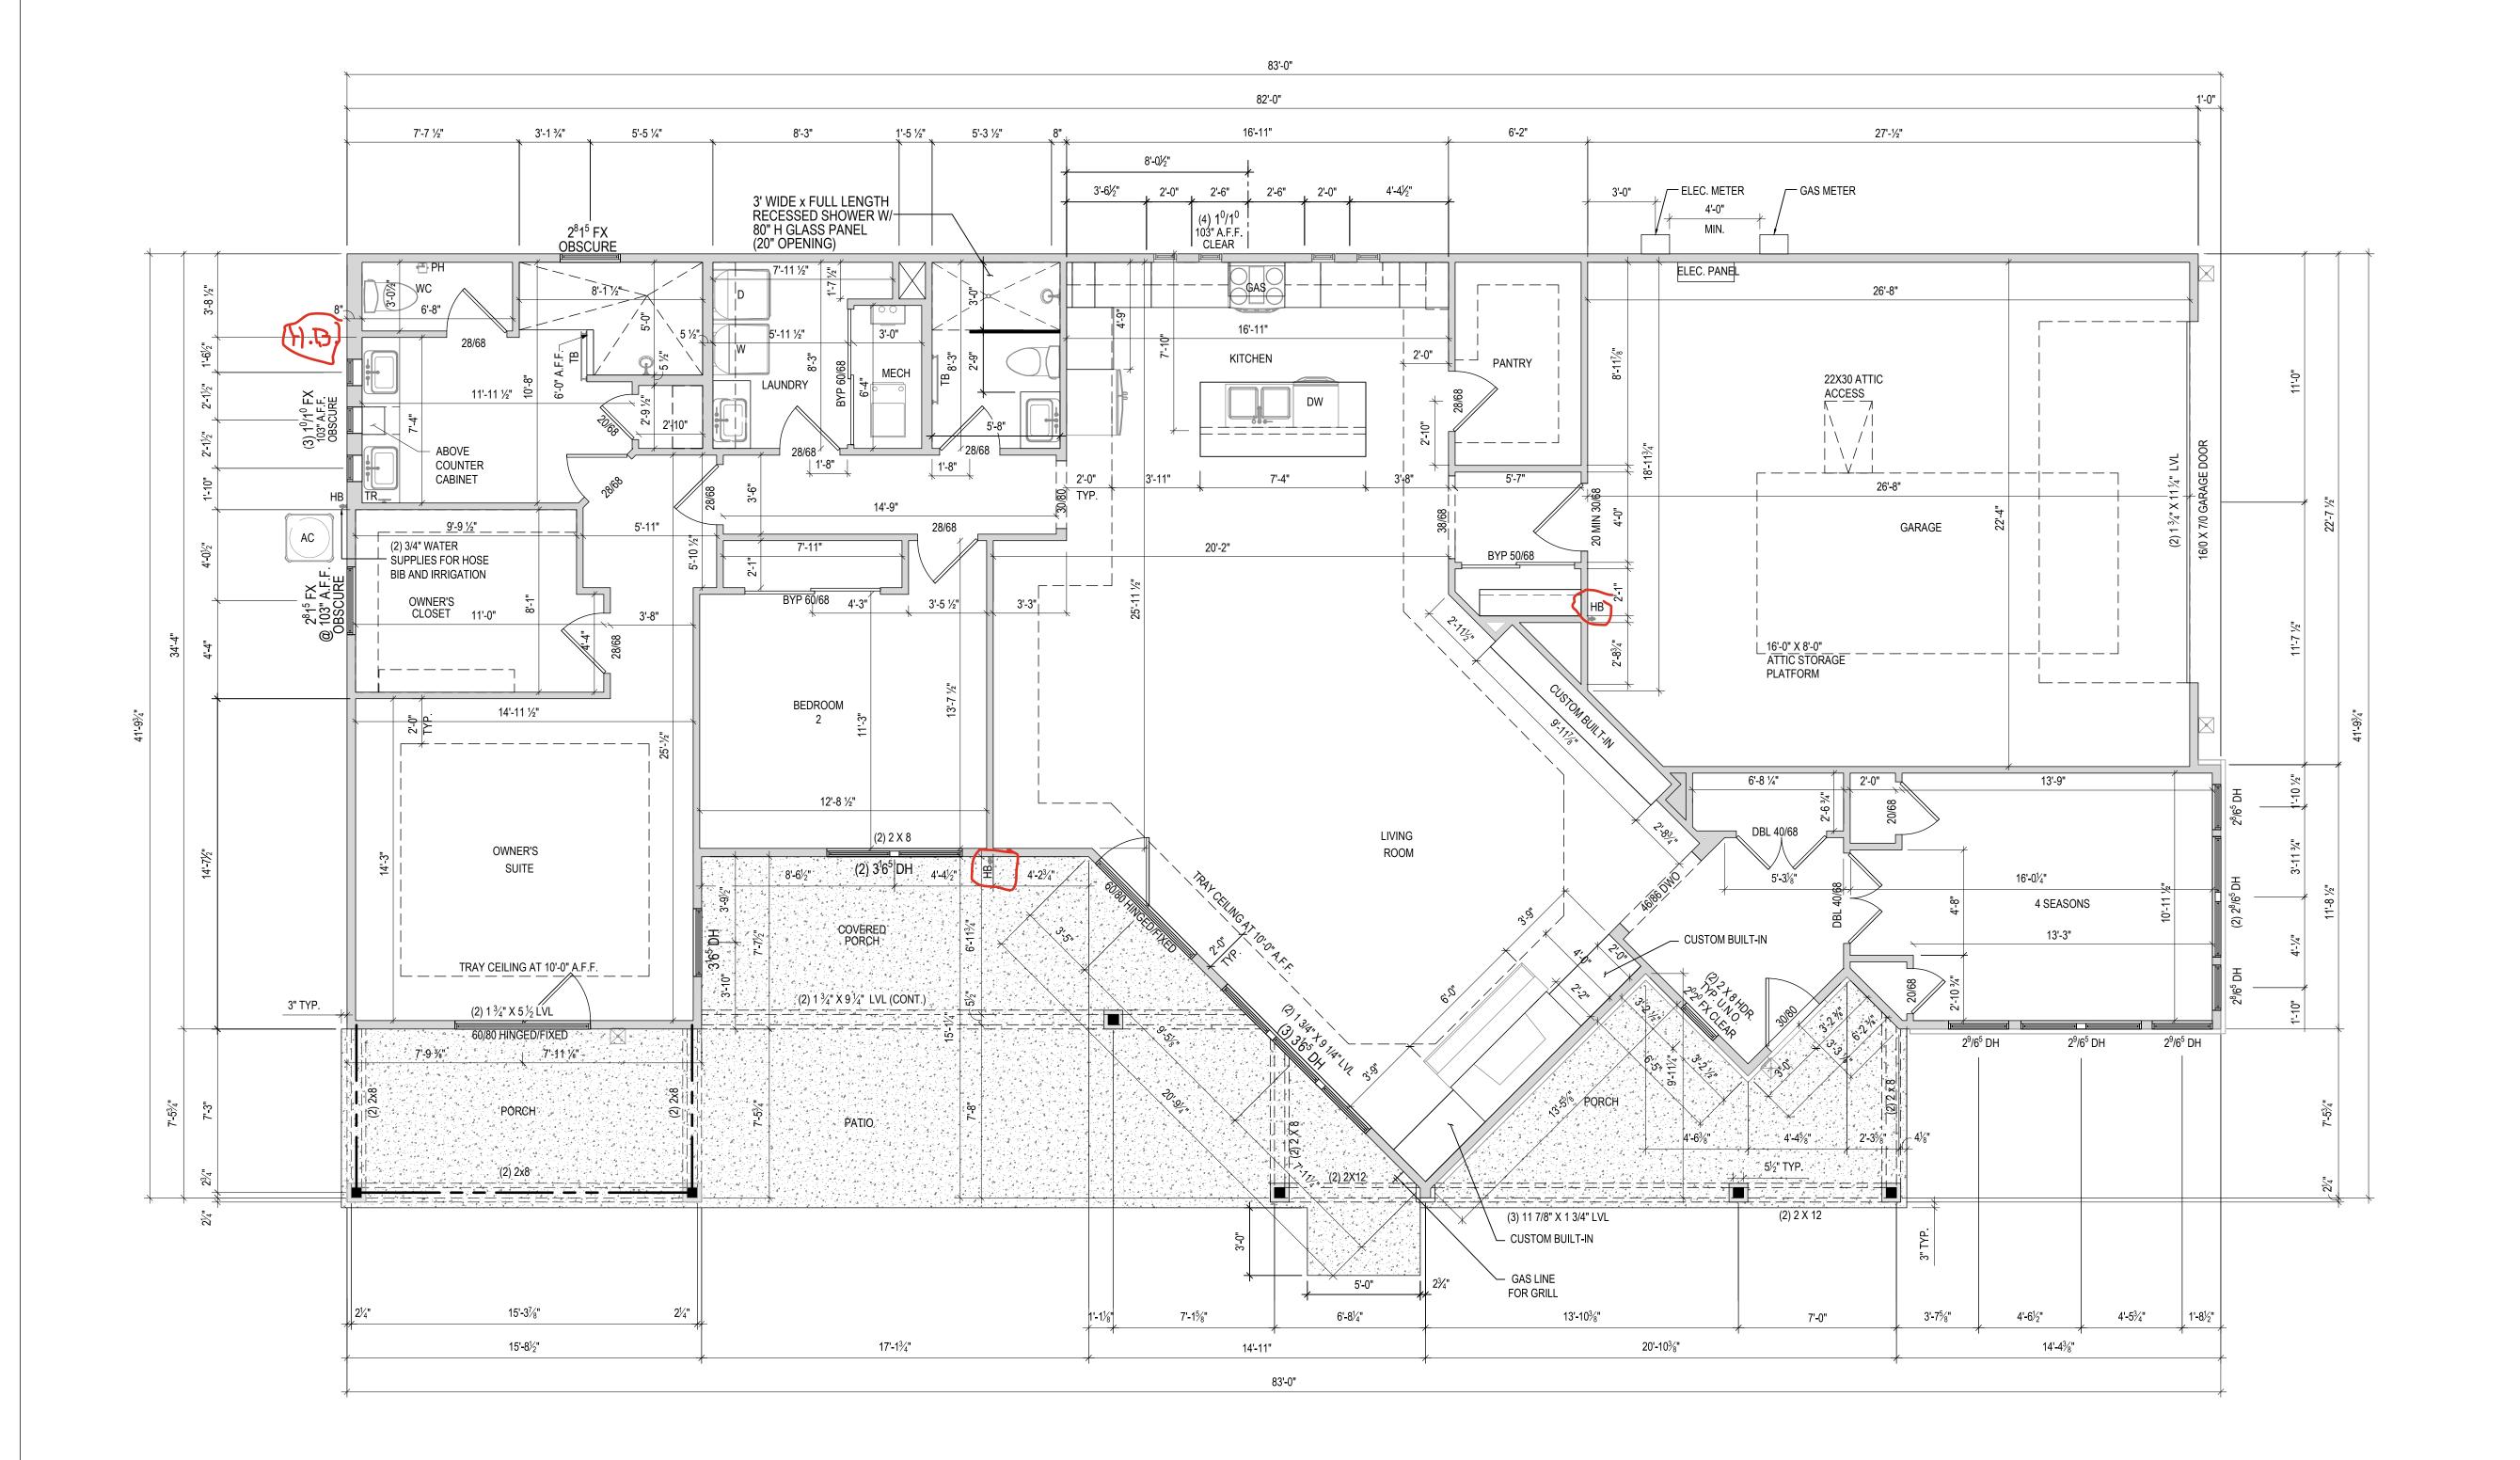1/8" = 1'-0" @ 11" x 17"




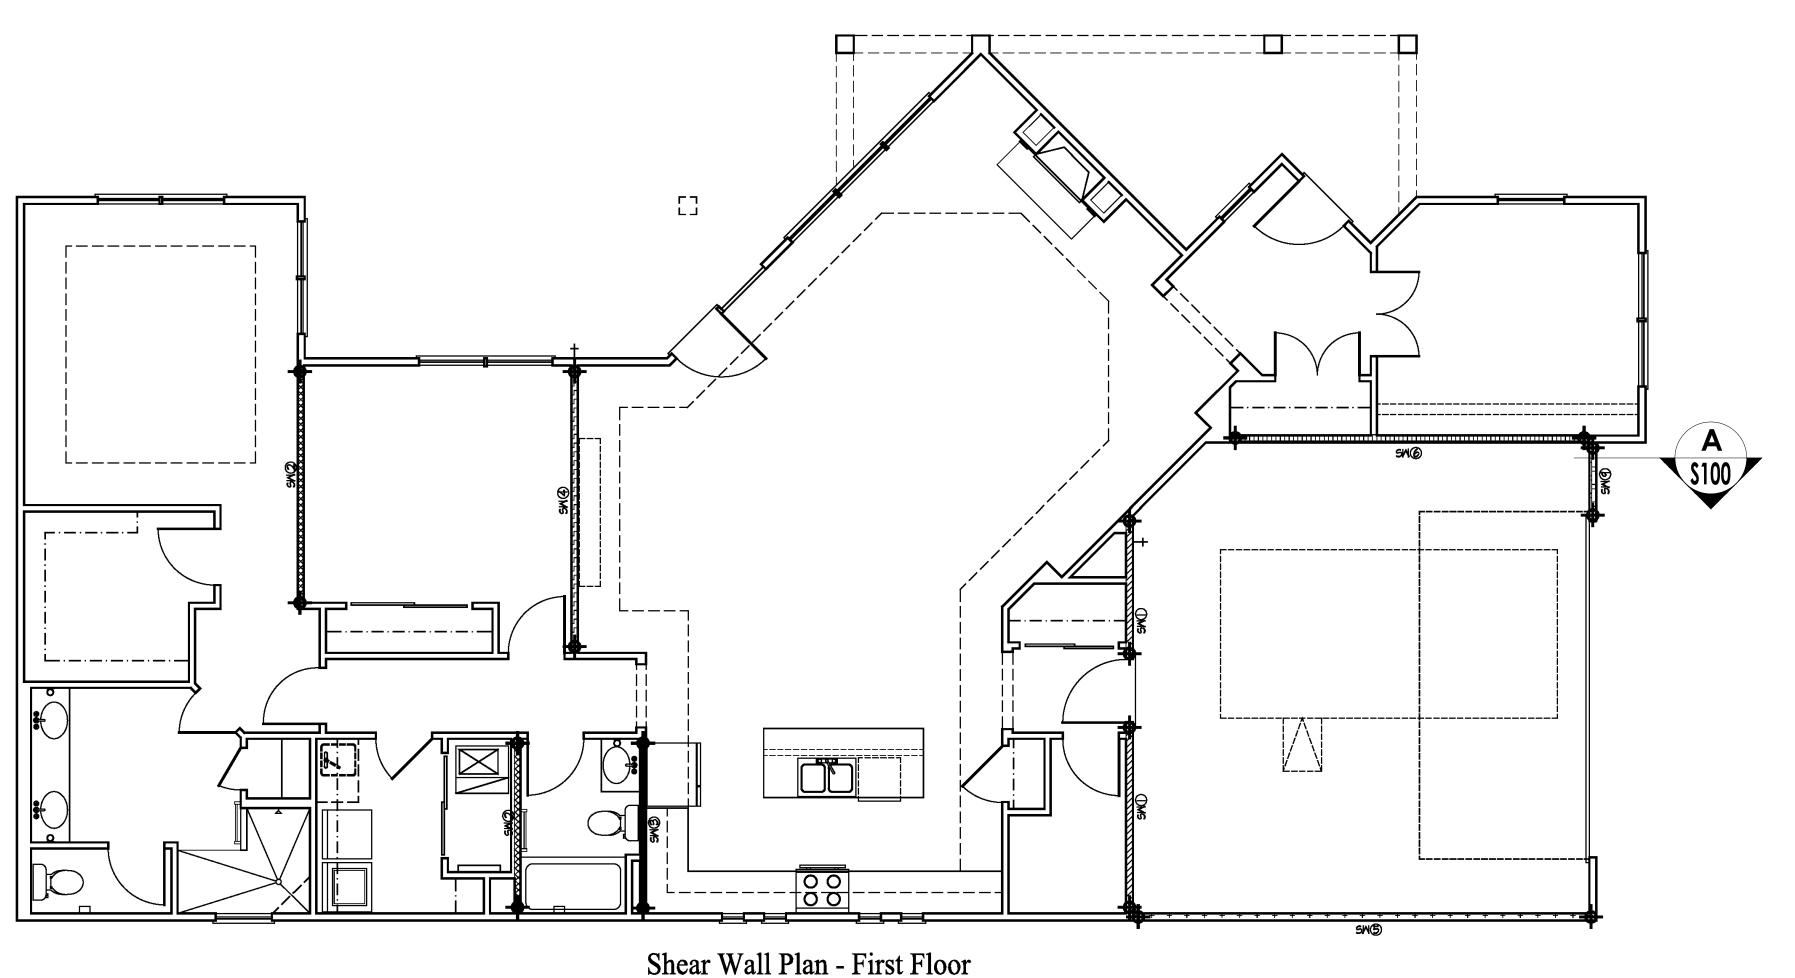

## A TYPICAL WALL SECTION S100 3/4" = 1'-0"
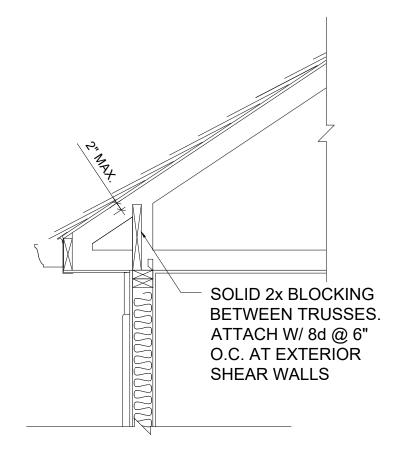
#### Note


- l) To comply with RCO section 602.10.4 this structure has an engineered solution for braced walls to be constructed per sheets 5-100 ans 5-101. Braced wall panels are referred to as Shear Walls on this plan.
- 2) To comply with RCO section 602.10.8.2 any trusses meeting all four of the conditions listed below shall receive blocking between trusses as outlined in this code section
  - a) A heal height greater than 9 1/4 as measured from the wall top plate or beam to top side of the trues
  - b) Occurring above a braced wall panel (shear wall) as outlined on sheet this sheet.
- d) Where trusses are running perpendicular to the braced wall.

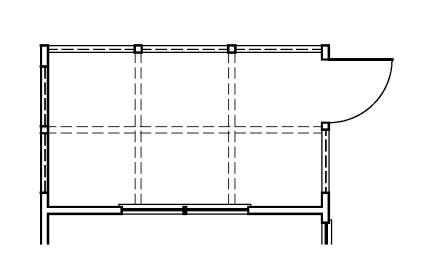

## Shear Wall Plan - Screened Porch Option

Scale: 1/4" = 1'-0"


SEE FIRST FLOOR PLAN ON THIS SHEET FOR SHEAR WALL DESIGN. NO ADDITIONAL SHEAR WALLS NEEDED FOR THIS OPTION OTHER THAN WHAT IS SHOWN.

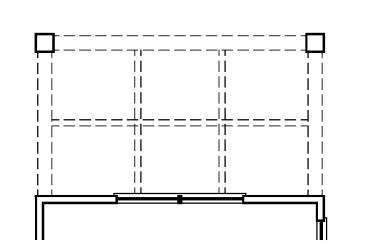

Shear Wall Plan - Covered Porch Option

Scale: 1/4" = 1'-0"

SEE FIRST FLOOR PLAN ON THIS SHEET FOR SHEAR WALL DESIGN, NO ADDITIONAL SHEAR WALLS NEEDED FOR THIS OPTION OTHER THAN WHAT IS SHOWN.

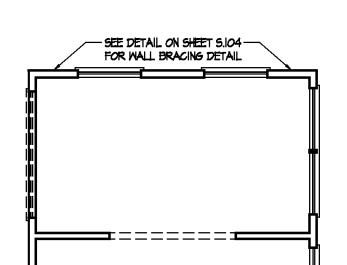

### Shear Wall Plan - Sitting Room Option

Scale: 1/4" = 1'-0"

Scale: 1/4" = 1'-0"

SEE FIRST FLOOR PLAN ON THIS SHEET FOR SHEAR MALL DESIGN. NO ADDITIONAL SHEAR MALLS NEEDED FOR THIS OPTION OTHER THAN WHAT IS SHOWN. SHEAR WALL LEGEND

THIS SHEET FOR DETAILS.

5H 4

5W 6

SM 10

SM II


REFER TO SHEAR WALL SCHEDULE ON

HOLDOWN LOCATION -(1) EACH END OF ALL SHEAR WALLS.

ALL NON-RATED EXTERIOR WALLS TO BE

SHEATHED WITH 7/16" OSB. USE 6 DIA. NAILS AT 6" O.C. AT EDGES AND 12" O.C.

AT INTERMEDIATE SUPPORTS.

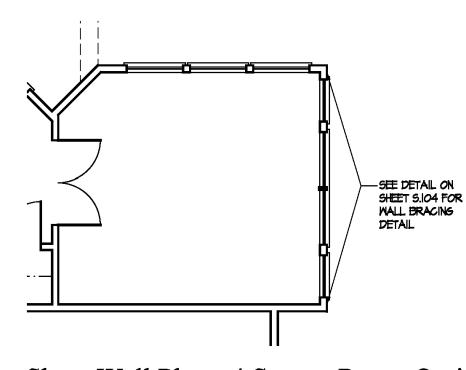

## Shear Wall Plan - 4 Season Room Option

Scale: 1/4" = 1'-0"

SEE FIRST FLOOR PLAN ON THIS SHEET FOR SHEAR WALL DESIGN, NO ADDITIONAL SHEAR WALLS NEEDED FOR THIS OPTION OTHER THAN WHAT IS SHOWN.

SHEAR WALL SCHEDULE									
MARK	WALL CONSTRUCTION			EDGE	E NAILING	FIELD	NAILING		
MAKK	END STUDS	STUD SIZE	SIMPSON HOLDOWN	SOLE PL & BOLT SPACING	SHEATHING	SIZE	SPACING	SIZE	SPACING
1	(2) 2 x 4	2 x 4	HTT4	2 x 4 \( \frac{1}{2} \) DIA. \( \Q 48 \) O.C. (SEE NOTE 6 BELO\( \frac{1}{2} \)	1/2" GYPSUM SHEATHING (E.S.)	6d	4" O.C.	6d	4" O.C.
2	(2) 2 x 4	2 x 4	HTT4	2 x 4 \( \frac{1}{2} \) DIA. \( \Phi \) 48" O.C. \( \text{(SEE NOTE 6 BELOW)} \)	1/2" GYPSUM SHEATHING (E.S.)	6d	7" O.C.	6d	7" O.C.
3	(2) 2 x 4	2 × 4	LTT19	2 x 4 \( \frac{1}{2} \) DIA. \( \Phi \) 48 \( 0.C. \) (SEE NOTE 6 BELO\( \phi \))	1/2" GYPSUM SHEATHING (E.S.)	6d	7" O.C.	6d	7" O.C.
4	(2) 2 x 4	2 × 4	LTT20B	2 x 4 \( \frac{1}{2}\) DIA. \( \Phi\) 48\ 0.C. \( \text{(SEE NOTE 6 BELO\( \phi\))}	1/2" GYPSUM SHEATHING (E.S.)	6d	7" O.C.	6d	7" O.C.
5	(2) 2 x 4	2 x 4	NONE	2 x 4 \( \frac{1}{2} \) DIA. \( \mathbf{Q} \) 48 \( \text{O.C.} \) (SEE NOTE 6 BELO\( \mathbf{P} \))	1/2" GYPSUM SHEATHING (I.S.) 7/16 OSB (O.S.)	6d 8d	7" O.C. 6" O.C.	6d 8d	7" O.C. 12" O.C.
6	(2) 2 x 4	2 x 4	LTT19	2 x 4 \( \frac{1}{2} \) DIA. \( \Phi \) 48" O.C. (SEE NOTE 6 BELO\( \frac{1}{2} \))	1/2" GYPSUM SHEATHING (I.S.) 7/16 OSB (O.S.)	6d 8d	7" O.C. 6" O.C.	6d 8d	7" O.C. 12" O.C.
7	(2) 2 x 4	2 x 4	LTT20B	2 x 4 \( \frac{1}{2}\) DIA. \( \Phi\) 48\( \text{0.C.} \) (SEE NOTE 6 BELO\( \phi\))	1/2" GYPSUM SHEATHING (I.S.) 7/16 OSB (O.S.)	6d 8d	7" O.C. 6" O.C.	6d 8d	7" O.C. 12" O.C.
8	(2) 2 x 4	2 x 4	MSTC40	2 x 4 \( \frac{1}{2} \) DIA. LAGBOLTS (6" LONG) \( \text{0} \) 48" O.C.	1/2" GYPSUM SHEATHING (I.S.) 7/16 OSB (O.S.)	6d	7" O.C.	6d	7" O.C.
9	(2) 2 x 4	2 x 4	HTT4	2 x 4 \( \frac{1}{2} \) DIA. \( \mathbf{Q} \) 48 \( \text{O.C.} \) (SEE NOTE 6 BELO\( \mathbf{P} \))	1/2" GYPSUM SHEATHING (I.S.) 7/16 OSB (O.S.)	6d 8d	7" O.C. 6" O.C.	6d 8d	7" O.C. 12" O.C.
10	(2) 2 x 4	2 x 4	HTT5	2 x 4 \( \frac{1}{2} \) DIA. \( \Phi \) 48" O.C. (SEE NOTE 6 BELO\( \frac{1}{2} \))	1/2" GYPSUM SHEATHING (I.S.) 7/16 OSB (O.S.)	6d 8d	7" O.C. 6" O.C.	6d 8d	7" O.C. 12" O.C.
11)	(2) 2 x 4	2 x 4	DTT2Z	2 x 4 \( \frac{1}{2} \) DIA. \( \Phi \) 48 \( \text{O.C.} \) (SEE NOTE 6 BELO\( \phi \))	1/2" GYPSUM SHEATHING (I.S.) 7/16 OSB (O.S.)	6d 8d	7" O.C. 6" O.C.	6d 8d	7" O.C. 12" O.C.

NOTES: 1. WHERE STUD MUST BE CUT DUE TO THE PLACEMENT OF ANCHORS BOLTS OR OTHER PRODUCTS, AN ADDITIONAL STUD SHALL BE INSERTED ALONG SIDE.

2. ALL EXTERIOR WALL SHEATHING SHALL BE A.P.A. RATED SHEATHING, EXPOSURE 1.
3. ALL PANEL EDGES SHALL BE SOLID BLOCKED WITH 2 x FRAMING MEMBER.

4. ALL SHEAR WALLS SHALL BE FULL LENGTH WALLS OR END AT BOTTOM CHORD OF TRUSS.

5. NOT USED.

6. ANCHOR BOLTS TO BE: 1/2" DIA. ANCHOR BOLTS OR SIMPSON TITEN HD SCREW ANCHORS WITH 3" x 3" x 1/4" THICK PLATE WASHERS.

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01	BUILDER SET	12/16/2024

PROJECT

LOT: 151

PLAN: BH Promenade D3
ELEV: Elev B - Hip Roof

DRAWING TITLE

SHEAR WALL PLAN

SHEET NUMBER

(0.S.) OUTSIDE OF UNIT

(E.S.) EACH DWELLING UNIT SIDE

(I.S.) INSIDE OF UNIT

S-101

NOT FOR CONSTRUCTION

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