


Foundation Plan

Scale: 1/4" = 1'-0"

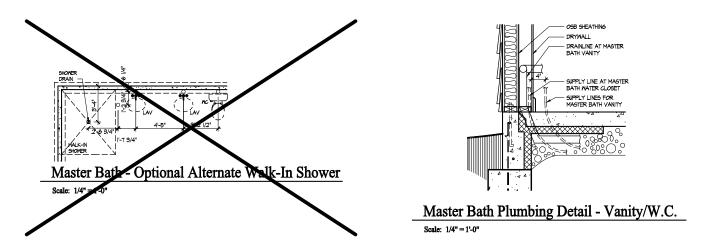

FOUNDATION CODED NOTES

(FOUNDATION PLAN ONLY)
(ALL NOTES NOT APPLICABLE TO ALL SHEETS)

I. POURED CONCRETE FOUNDATION STEM WALL (TYPICAL) - SEE

2. 12' WIDE CONCRETE FOOTING WITH STEEL BAR REINFORCING AS REGUIRED BY SOILS BISINEER: - MAINTAIN BOTTOM OF FOOTING A MINIMUM BO' BELOW FINISH GRADE AND TOP OF FOOTING SET I2" BELOW FINISHED FLOOR: - TYPICAL.

3. PROVIDE MIN. 2 ANCHOR BOLTS EACH SIDE OF GARAGE DOORS.

4. SAN CUT CONTROL JOINT IN CONCRETE SLAB, 1/8" WIDE \times 1/4 DEEP - TYPICAL.

5. 4" GLASS FIBER REINFORCED CONCRETE FLOOR SLAB OVER 4 MIL. POLYETHYLENE VAPOR BARRIER AND 4" GRAVEL BASE - TYPICAL.

6. 4" GLASS FIBER REINFORCED CONCRETE FLOOR SLAB OVER 4" GRAVEL BASE - TYPICAL IN GARAGES.

7. PROVIDE MEATHERLIP & GARAGE DOOR OPENING - SEE DETAIL D, SHEET A.201.

8. PIPE LOCATION CENTERED ON WALL ABOVE.

9. NO STEM WALL AT GARAGE DOOR OPENINGS.

IO. WASHER ALWAYS LOCATED LEFT OF DRYER.

II. ELECTRICAL CONDUIT UNDER SLAB FOR ELECTRICAL OUTLET AT KITCHEN ISLAND.

13. 8" DEEP X 12" WIDE THICKENED SLAB WITH (2) NO. 4 REBAR CONTINUOUS, TYPICAL UNDER ALL BEARING WALLS.

DASHED LINES INDICATE LOCATION OF PLUMBING FIXTURES ABOVE - SHOWN FOR REFERENCE ONLY.

15. $(O^*$ WIDE \times $(O^*$ DEEP CONCRETE PIER WITH 24" DIA, FOOTING. MAINTAIN BOTTOM OF FOOTING A MINIMUM BO" BELOW FINISH GRADE AND TOP OF PIER SET 6" BELOW FINISHED FLOOR.

16. DOTTED LINE INDICATES WALL LINE OF BASE UNIT.

17. 2'-6" x 2'-6" x 8" DEEP CONCRETE FOOTING WITH (3) NO. 4 REBAR EACH WAY (OR SIZE AS SHOWN).

18. 24" MIDE CONCRETE FOOTING WITH STEEL BAR REINFORCING AS REQUIRED BY SOILS BUGINEER - MAINTAIN BOTTOM OF FOOTING A MINIMAM BO' BELOW FINISH GRADE AND TOP OF FOOTING SET 12" BELOW INNISHED FLOOR.

19. 8" DEEP X 16" WIDE THICKENED SLAB WITH (2) NO. 4 REBAR CONTINUOUS, TYPICAL UNDER ALL BEARING WALLS.

20. 8" DEEP CONCRETE FOOTING WITH (3) NO. 4 REBAR EACH WAY -SEE PLANS FOR SIZE.

21. 16' MIDE CONCRETE FOOTING MITH STEEL BAR REINFORCING AS REQUIRED BY SOILS ENGINEER: - MAINTAIN BOTTOM OF FOOTING A MINIMA 90' BELOW FINISH RAZIOE AND TOP OF FOOTING SET I2' BELOW FINISHED FLOOR - TYPICAL.

22. 24" DIA. FOOTING - MAINTAIN BOTTOM OF FOOTING A MINIMUM 32" BELOW FINISH GRADE.

23. 12° DEEP \times 16° WIDE THICKENED SLAB WITH (2) No. 4 REBAR CONTINUOUS, TYPICAL UNDER ALL INTERIOR SHEAR WALLS.

24. PLUMBER TO PROVIDE 4" PVC SLEEVE FOR WATER AND 4" SANITARY LINE FOR INSTALLATION BY FOOTER CONTRACTOR.

GENERAL FOUNDATION NOTES

I. SOIL BEARING CAPACITY ASSUMED TO BE 2500 PSF AND SHALL BE VERIFIED BY SOILS ENGINEER PRIOR TO PLACEMENT OF BUILDING FORDATION. CORLL ARCHITECT WHEN INADEQUATE SOIL CAPACITIES ARE FOUND.

2. ALL DIMENSIONS ARE TO FACE OF FOUNDATION / BASEMENT WALL UNLESS NOTED OTHERWISE.

3. HOLD DOWN TOP OF FOUNDATION WALL 8" AT ALL ENTRY DOORS TO ALLOW FOR EXTENSION OF FLOOR SLAB UNDER THE DOOR THRESHOLDS.

4. PLIMBING CONTRACTOR TO USE ROUND BUCKETS FOR FORMED SLAB PENETRATIONS.

5. CONCRETE CONTRACTOR TO INSTALL 1/2" EXP. JT. AROUND THE PERIMETER OF GARAGES.

6. CONCRETE CONTRACTOR COORDINATE WITH PLUMBING FOR LOCATION OF BLOCKOUTS FOR UNDERSLAB LINES.

7. CONCRETE CONTRACTOR - SEE FIRST FLOOR PLAN FOR SIDEMALKS AND PATIOS.

 $\delta.$ CONCRETE CONTRACTOR TO VERIFY SLAB PENETRATION AT TUB/SHOWER OPTIONS.



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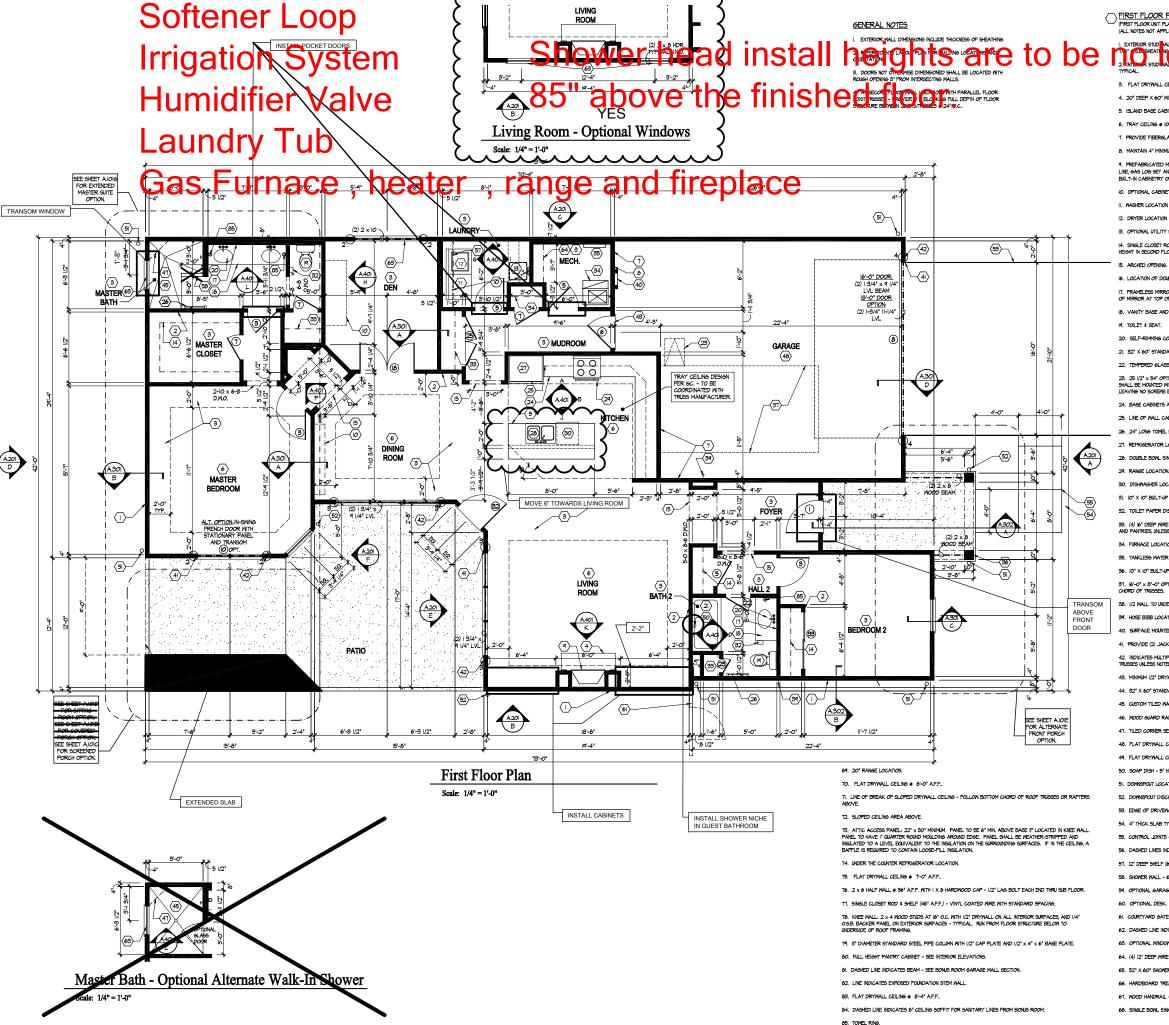
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Disk No. Revision Date

Architect Pro	oject Number 0-044
Date Originated Bid Permit	tes & Revisions 20 FEB 2020
Construction Revisions	\triangle
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Foundation Plan

Architectural Style

European Country Sheet Number A.100 D2+M 2010



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FIRST FLOOR PLAN CODED NOTES
(FIRST FLOOR UNIT PLANS ONLY)
(ALL NOTES NOT APPLICABLE TO ALL SHEETS)

- 3. FLAT DRYWALL CEILING & 4'-0" A.F.F. TYPICAL UNLESS NOTED OTHERWIS
- 4. 20" DEEP X 60" WIDE GRANITE HEARTH EXTENSION CENTERED ON FIREBOX
- 5. ISLAND BASE CABINETS & COUNTERTOP FINISH ALL EDGES OF CABINETS & COUNTERTO

- 8 MAINTAIN 4" MINIMIM ELEVATION CHANGE PETWEEN GARAGE ELOOR & FINISHED FIRST ELOOR
- LINE, GAS LOG SET AND SCREEN ROUGH OPENING 3T' WIDE X 34 3/4" HIGH X 18" DEEP (26" DEEP WITH

- 12. DRYER LOGATION DRYER VENT IN WALL
- 13. OPTIONAL UTILITY SINK AND FAUCET INSTALL ROUGH-IN PLUMING ONLY.
- 4. SINGLE CLOSET ROD & SHELF (61 1/2" A.F.F.) VINYL COATED WIRE WITH STANDARD SPACING, VERIFY
- 16. LOCATION OF DOUBLE 2 X 4 STUD WALL
- IT. FRAMELESS MIRROR LOCATION 42" HIGH \times 2" SHORTER THAN VANITY TOP (I" EACH SIDE) SET BOTTON OF MIRROR AT TOP OF BACKSPLASH.
- IB. VANITY BASE AND COUNTERTOP 3I 1/2" A.F.F.
- IA. TOILET & SEAT.
- 21. 32" X 60" STANDARD TUB/SHOWER & FAUCET WITH CERAMIC TILE SURROUND
- 22. TEMPERED GLASS SHOWER ENCLOSURE AND DOOR
- 23. $25\,l/2' \times 54'$ OPTIONAL FULL DOWN STAIR LOCATED BETWEEN TRUSSES ABOVE. DRYWALL ON STAIR SHALL BE MONITED WITH SOREMS INTO THE TOP 4 BOTTOM DOOR CROSS SUPPORTS WITH THE CENTER GUED LEAVING NO SCHEPS EXPOSED.
- 24. BASE CABINETS AND COUNTERTOR
- 25. LINE OF WALL CABINETS ABOVE.
- 26. 24" LONG TOWEL BAR 54" A.F.F. (58" A.F.F. ABOVE TOILET,

- 31. IO' X IO' BUILT-UP COLUMN TYPICAL. SEE DETAIL D, SHEET A304 FOR MORE INFORMATION
- (4) 16" DEEP WIRE SHELVES (24", 42", 55", 66" A.F.F.) STANDARD SPACING, TYPICAL AT LINEN CLOSETS 2 PANTRIES UNLESS NOTED OTHERWISE
- 34. FURNACE LOCATION
- 36. 10° X 10° BUILT-UP COLUMN / PILASTER TYPICAL. SEE DETAIL F, SHEET A304 FOR MORE INFO
- 31. $16^{\circ}O' \times 0^{\circ}O'$ OPTIONAL ATTIC STORAGE ABOVE PROVIDE 3/4' APA RATED SUB-FLOORING ON BOTTON CHORD OF TRUSSES.
- 38. I/2 WALL TO UNDERSIDE OF BAR COUNTERTO

- 41. PROVIDE (2) JACKS UNDER ALL HEADERS IN OPENINGS OVER 60' WIDE TYPICAL
- 42. INDICATES MULTIPLE STUD COLUMN IN WALL TYPICAL AT BEARING OF ALL WOOD BEAMS, GIRDE TRUSSES UNLESS NOTED OTHERWISE. SEE PLAN FOR NUMBER OF STUDS REQUIRED.

- 45. CUSTOM TILED WALK-IN SHOWER BASE SEE PLAN FOR SIZE
- 46. WOOD GUARD RAIL (OPTIONAL) SEE DETAIL K ON SHEET A 304
- 47. TILED CORNER SEAT OPTION 30" WIDE X I&" A.F.F. HIGH.
- 48. FLAT DRYWALL CEILING ON UNDERSIDE OF BOTTOM CHORD OF ROOF TRUSSES OR FLOOR JOISTS.

- 52. DOWNSPOUT DISCHARGED INTO BLACK PIPE AND ROUTED UNDER WALKS OR PATIC

- 55. CONTROL JOINTS TYPICAL.
- 56. DASHED LINES INDICATE BOXED BEAM ABOVE
- 57. 12" DEEP SHELF (60" A.F.F.) VINYL COATED WIRE STANDARD SPACING
- 60. OPTIONAL DESK

- 64 (4) 12" DEEP WIRE SHE VES (24" 42" 55" 68" A.E.E.) STANDARD SPACING
- 65. 32" X 60" SHOWER BASE WITH BUILT-IN SEAT.
- 68 SINGLE BOWL SINK AND FAIRET

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& Bel Haven, LLC Foundation Development Road Ohio 45069 LLC & Bel Har Bel Haven Beckett Road Group, I

Revision	Date
	4/28/10
	Revision

Architect Project Number 2019-044

Community Dates & Revisions 20 FEB 2020

First Floor Plan

Architectural Style **European Country**

Sheet Number A.101