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4-6



#### FLOOR PLAN NOTES

- ALL HEADERS ARE (2) 2x6 w/ 2x4 WALLS OR (8) 2x6 w/ 2x6 WALLS, INLESS OTHERWISE NOTED.

  2x6 WALLS, INLESS OTHERWISE NOTED.

  2x1 LI HEADERS TO HAVE (1) 2x4 OR 2x6 JACK EACH END, INLESS OTHERWISE NOTED.

  3x1 LL EXTERIOR WALLS TO BE 4\* AND ALL INTERIOR WALLS TO BE 31 (2\*), INLESS OTHERWISE NOTED.

  4x1 LEXTERIOR WALL FANCE PROPPED CEILINGS, ALL DECOPPED CEILINGS ARE 12\* INLESS OTHERWISE NOTED.

  5x2 TEVEROLD WALL FANCE DETAIL SHEET FOR SPECIAL MAPPLICABLE.

  3x2 LOCATIONS AND HEADER SIZES, IF


  ALL MINDONS HAVE T~O 1/2\* HEADER HEIGHT WILESS OTHERWISE NOTED.

#### GYPSUM NOTES

AT GARAGE:

GYPSUM BOARD AT COMMON WALLS, CEILINGS, BEAM WRAPS AND SUPPORTS AS REQUIRED BY LOCAL CODE.


1/2" 6YPSIM BOARD AT UNDERSIDE OF STAIRS AND WALLS IN CLOSET

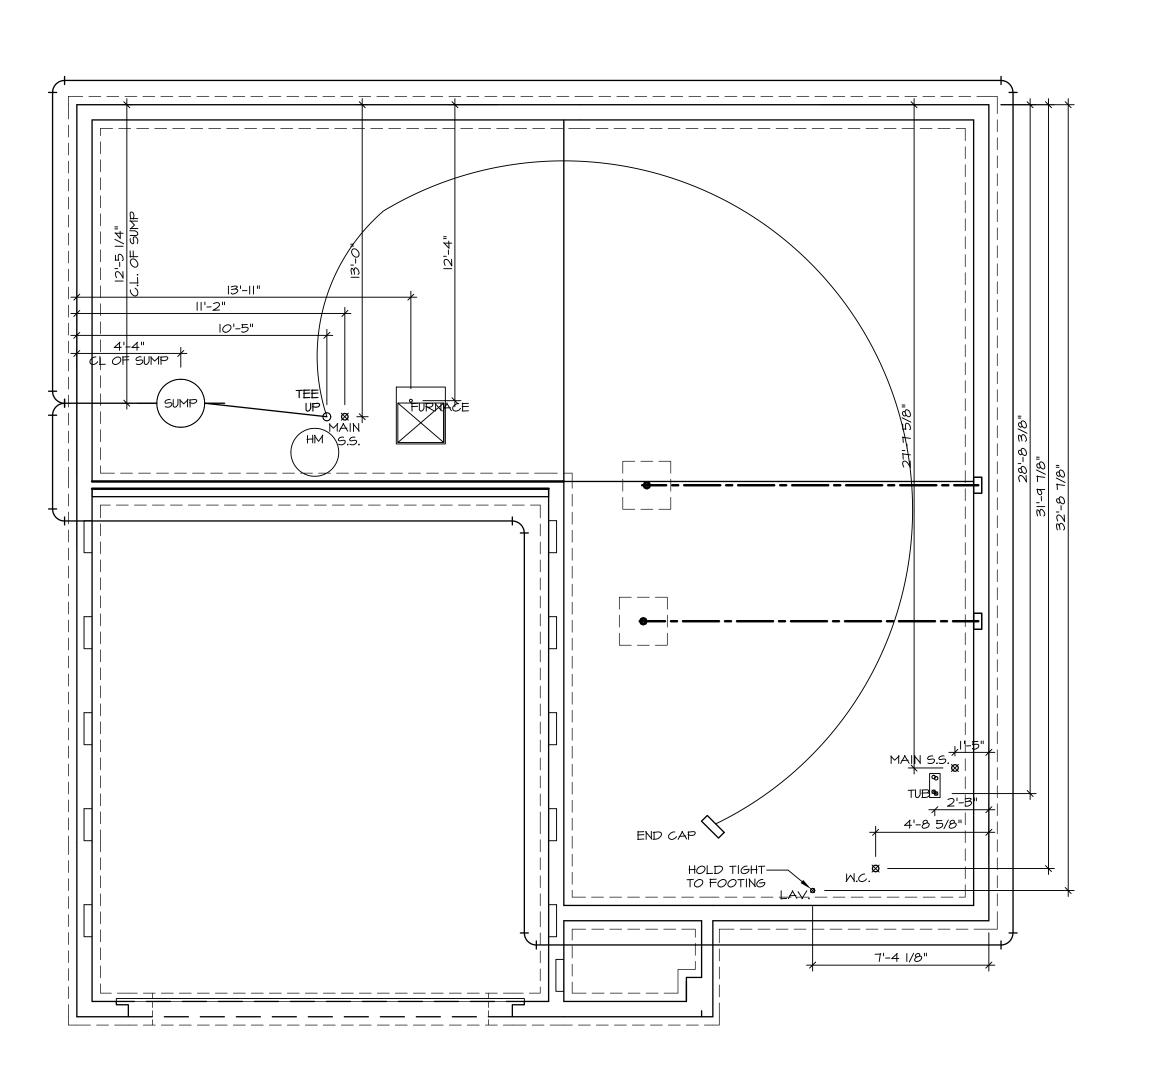



MING TITLE
UMBING PLAN
ON DESCRIPTION

PLUMBING OPTION DESCRI

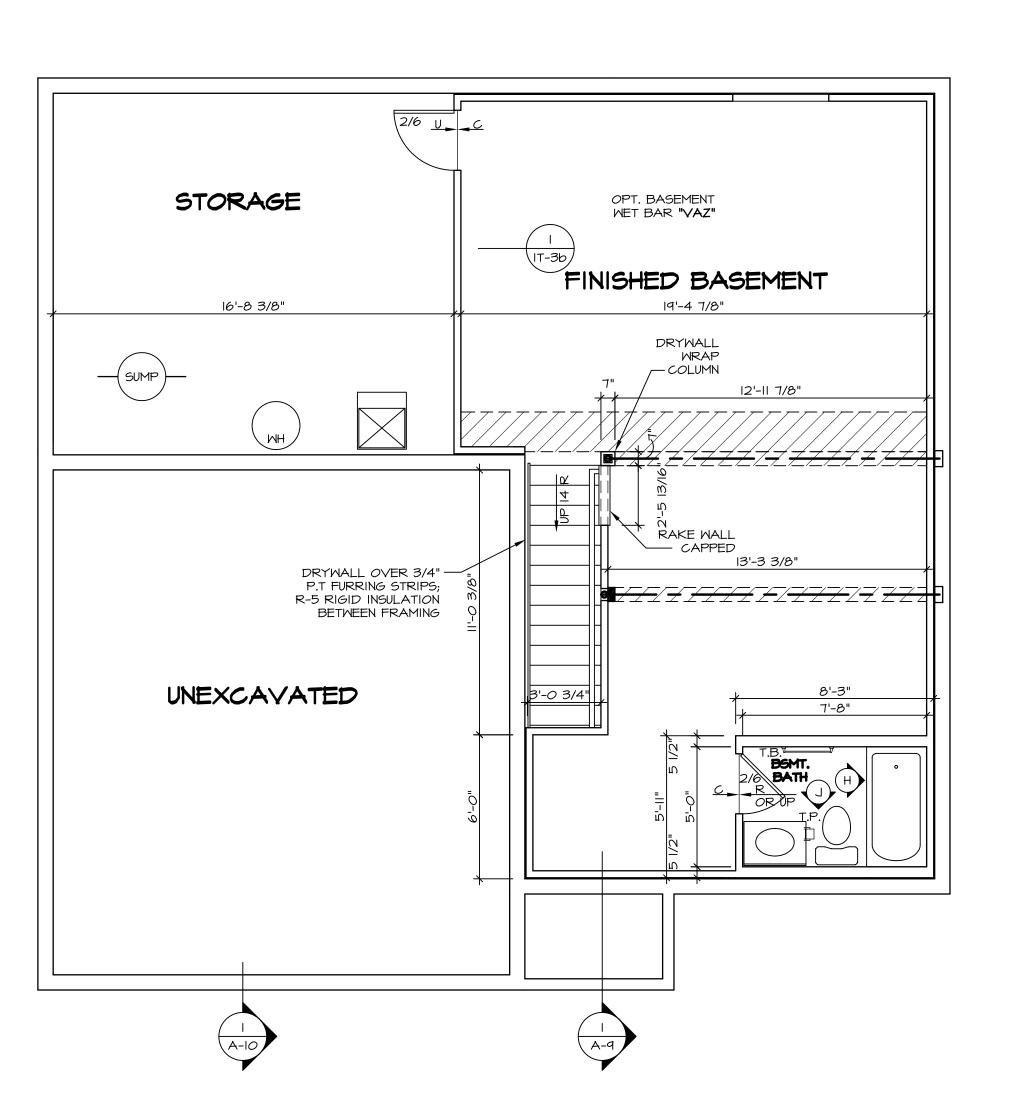

BASEMENT FLOOR PLAN

A-6 SCALE: 1/4" = 1'-0"

## FLOOR PLAN NOTES

- ALL HEADERS ARE (2) 2x6 w/ 2x4 WALLS OR (3) 2x6 w/ 2x6 WALLS, UNLESS OTHERWISE NOTED.
   ALL HEADERS TO HAVE (I) 2x4 OR 2x6 JACK EACH END,
- ALL HEADERS TO HAVE (I) 2x4 OR 2x6 JACK EACH END, UNLESS OTHERWISE NOTED.
   ALL EXTERIOR WALLS TO BE 4" AND ALL INTERIOR
- WALLS TO BE 3 I/2", UNLESS OTHERWISE NOTED

  4. HATCHED AREAS INDICATE DROPPED CEILINGS. ALL
  DROPPED CEILINGS ARE I2" UNLESS OTHERWISE NOTED.

  5. SEE "BRACED WALL PANEL DETAIL SHEET" FOR SPECIAL
  WALL FRAMING LOCATIONS AND HEADER SIZES, IF
- APPLICABLE.

  6. SEE STANDARD DETAIL CATEGORY "IT" SHEET(S) FOR INTERIOR TRIM DETAILS.

  7. SEE ARCHITECTURAL DETAIL SHEET "AD" FOR HOUSE
- SEE ARCHITECTURAL DETAIL SHEET "AD" FOR HOUSE SPECIFIC INTERIOR TRIM OPTION TABLE.
   ALL WINDOWS HAVE 7'-0 1/2" HEADER HEIGHT UNLESS OTHERWISE NOTED.

## GYPSUM NOTES

AT GARAGE:

GYPSUM BOARD AT COMMON WALLS, CEILINGS, BEAM WRAPS AND SUPPORTS PER STANDARD DETAIL **FA-I(b)** FIRE ASSEMBLIES OR AS REQUIRED BY LOCAL CODE.

AT STAIRS:

1/2" GYPSUM BOARD AT UNDERSIDE OF STAIRS AND WALLS IN CLOSET

LEGEND BEARIN

BEARING WALL

NON BEARING WALL

INDICATES BEARING FROM POINT-LOAD ABOVE

J\_ JACKS

B\_ BEAM/HEADER

B\_ BEAM/HEADER
F\_ PAD FOOTING

STEEL COLUMN

X PORTAL FRAME

X JOIST/TRUSS

L\_\_-\_ LYL

X ENGINEERING PAGE NUMBER

SEE FC DETAILS FOR FRAMING CONNECTORS

REMARKS	NYENT								
REV. NO. DATE	I O7/28/16 TM - DRAWING ALIGNMENT								
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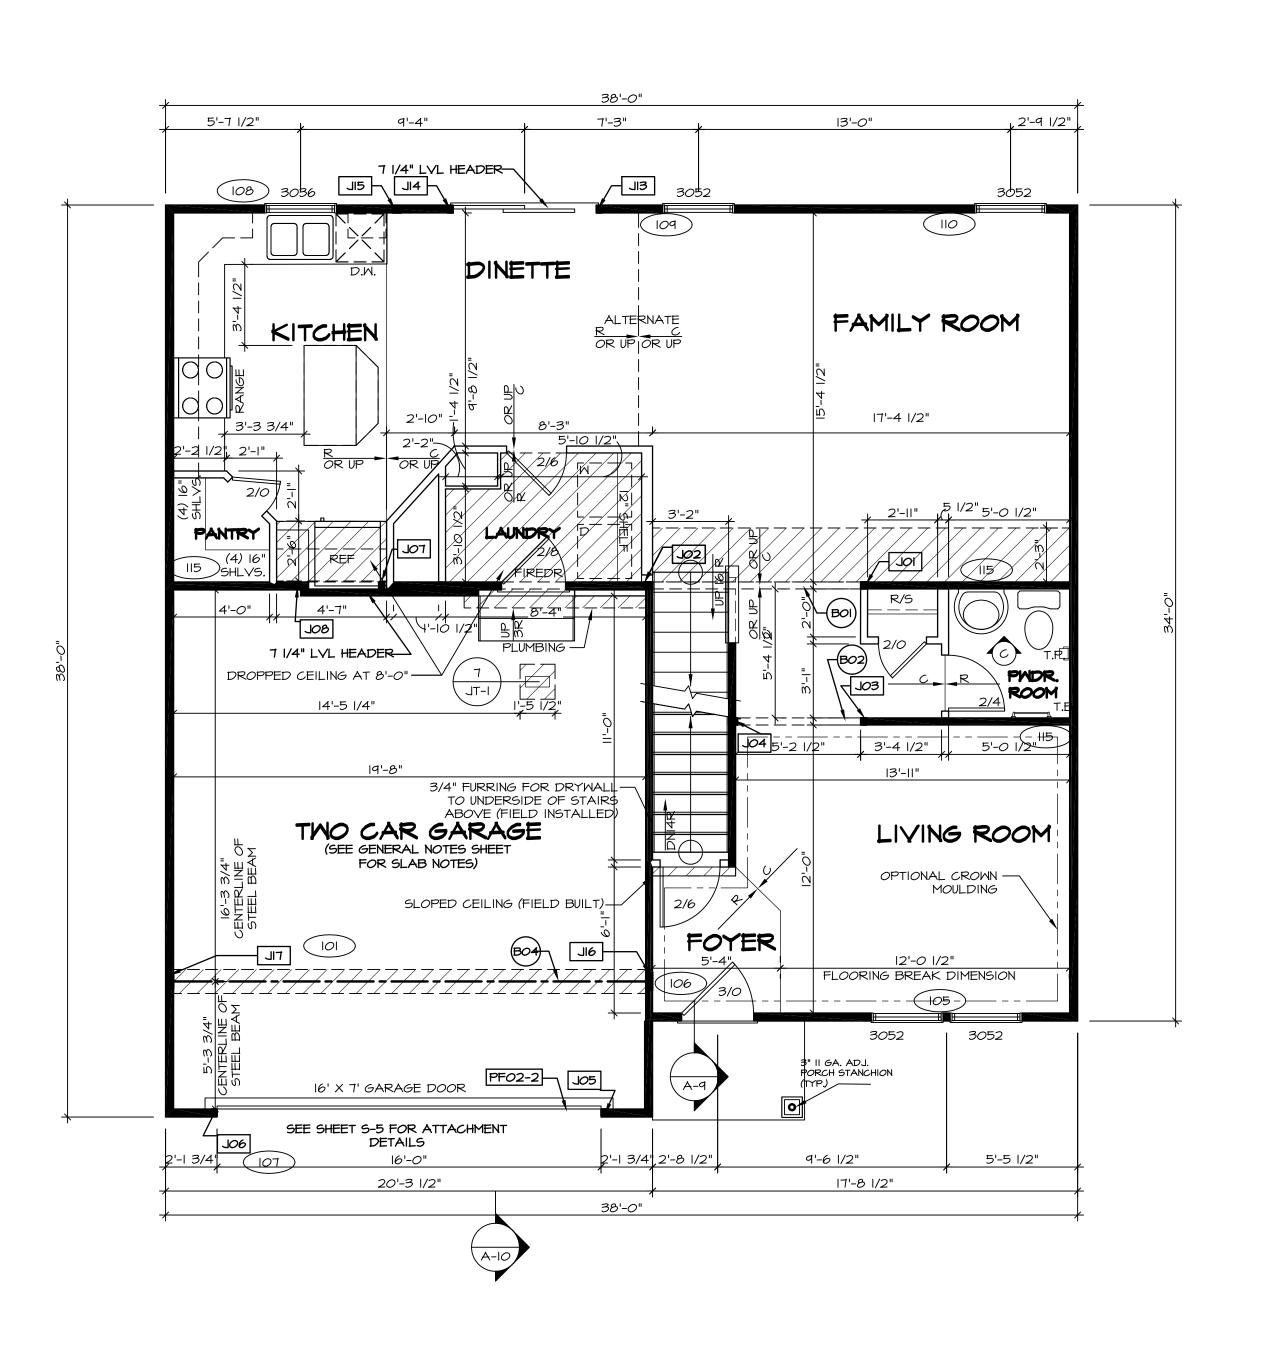
	FIRST FLOOR JACK SCHEDULE						
IDENTIFIER	DESCRIPTION	OPTIONS	ENG. NUM.	FIELD INSTALLED			
JOI	JACK - (2) 2X4 SPF STUD GRADE		Ш				
J02	JACK - (3) 2X4 SPF STUD GRADE		Ш				
J03	JACK - (2) 2X4 SPF STUD GRADE		II3				
J04	JACK - (3) 2X4 SPF STUD GRADE		II3				
J05	JACK - (2) 2X4 SPF STUD GRADE		107				
J06	JACK - (2) 2X4 SPF STUD GRADE		107				
J07	JACK - (2) 2X4 SPF STUD GRADE		163				
30L	JACK - (2) 2X4 SPF STUD GRADE		163				
SIL	JACK - (2) 2X4 SPF STUD GRADE		109				
JI4	JACK - (2) 2X4 SPF STUD GRADE		108				
JI5	JACK - (3) 2X4 SPF STUD GRADE		104				
JI6	JACK - (6) 2X4 SP#I	-	101				
TIL	JACK - (5) 2X4 SP#I		101				

### LVL PLY TO PLY FASTENING SCHEDULE:

- I.A (2) PLY UP TO AND INCLUDING II 7/8" TALL: FASTEN PLIES W/ (2) ROWS I6D NAILS AT I2" O.C.
- 2.A (2) PLY 14" TO AND 18" TALL (INCLUSIVE): FASTEN PLIES W/ (3) ROWS 16D NAILS AT 12" O.C. 3.A - (2) PLY 20" TALL AND OVER: FASTEN PLIES W/ (4) ROWS 16D NAILS AT 12" O.C.
- 4.A (3) PLY UP TO AND INCLUDING II 7/8" TALL: FASTEN PLIES W/ (2) ROWS 16D NAILS AT 12" O.C. FROM EACH SIDE
- 5.A (3) PLY 14" TO AND 18" TALL (INCLUSIVE): FASTEN PLIES W/ (3) ROWS 16D NAILS AT 12" O.C. FROM EACH SIDE
- 6.A (3) PLY 20" TALL AND OVER: FASTEN PLIES W/ (4) ROWS 16D NAILS AT 12" O.C. FROM EACH SIDE FIRST EL COR DEAM/HEADER COHEDHIE

	FIRST FLOOR BEA	M/HEA	DER SCHE	DULE	
IDENTIFIER	DESCRIPTION	LENGTH	OPTIONS	ENG. NUM.	REMARKS
BOI	INT HEADER - 2XI2 - 2 PLY	9'-2 1/2"		III	
B02	INT HEADER - 2X8 - 2 PLY	5'-9"		113	
B04	BEAM STEEL - WI2X26	20'-2"	SRI, SXS,6CB	0	
PF02-2	LVL - II-04	19'-11 1/2"	6CB	107	PORTAL FRAME, 2 PLY, I.A

STEEL COLUMN SCHEDULE					
IDENTIFIER	STYLE	HEIGHT	OPTIONS	ENG. NUM.	REMARKS



GYPSUM NOTES

GYPSUM BOARD AT COMMON WALLS, CEILINGS, BEAM

WRAPS AND SUPPORTS PER STANDARD DETAIL FA-1(b) FIRE ASSEMBLIES OR AS REQUIRED BY LOCAL CODE.

1/2" GYPSUM BOARD AT UNDERSIDE OF STAIRS AND WALLS

AT GARAGE:

AT STAIRS:

IN CLOSET

FLOOR PLAN NOTES

OTHERWISE NOTED.

INTERIOR TRIM DETAILS.

OTHERWISE NOTED.

APPLICABLE.

2x6 WALLS, UNLESS OTHERWISE NOTED.

STUD EACH END, UNLESS OTHERWISE NOTED.

SPECIFIC INTERIOR TRIM OPTION TABLE.

ABOVE, UNLESS OTHERWISE NOTED.

ALL HEADERS ARE (2) 2x6 W/ 2x4 WALLS OR (3) 2x6 W/

ALL HEADERS TO HAVE (1) 2x4 OR 2x6 JACK AND KING

ALL EXTERIOR WALLS TO BE 4" W/ OSB OR 3 1/2"

W/ T-PLY, ALL INTERIOR WALLS TO BE 3 1/2", UNLESS

HATCHED AREAS INDICATE DROPPED CEILINGS. ALL

SEE STANDARD DETAIL CATEGORY "IT" SHEET(S) FOR

SEE ARCHITECTURAL DETAIL SHEET "AD" FOR HOUSE (

ALL WINDOWS HAVE 7'-0 1/2" HEADER HEIGHT UNLESS


ALL HEADERS IN NON-BEARING WALLS SHALL BE A SINGLE FLAT 2X4 OR 2X6 ATTACHED TO CRIPPLES

DROPPED CEILINGS ARE 12" UNLESS OTHERWISE NOTED.

SEE "BRACED WALL PANEL DETAIL SHEET" FOR SPECIAL WALL FRAMING LOCATIONS AND HEADER SIZES, IF


RYAN

RYAN

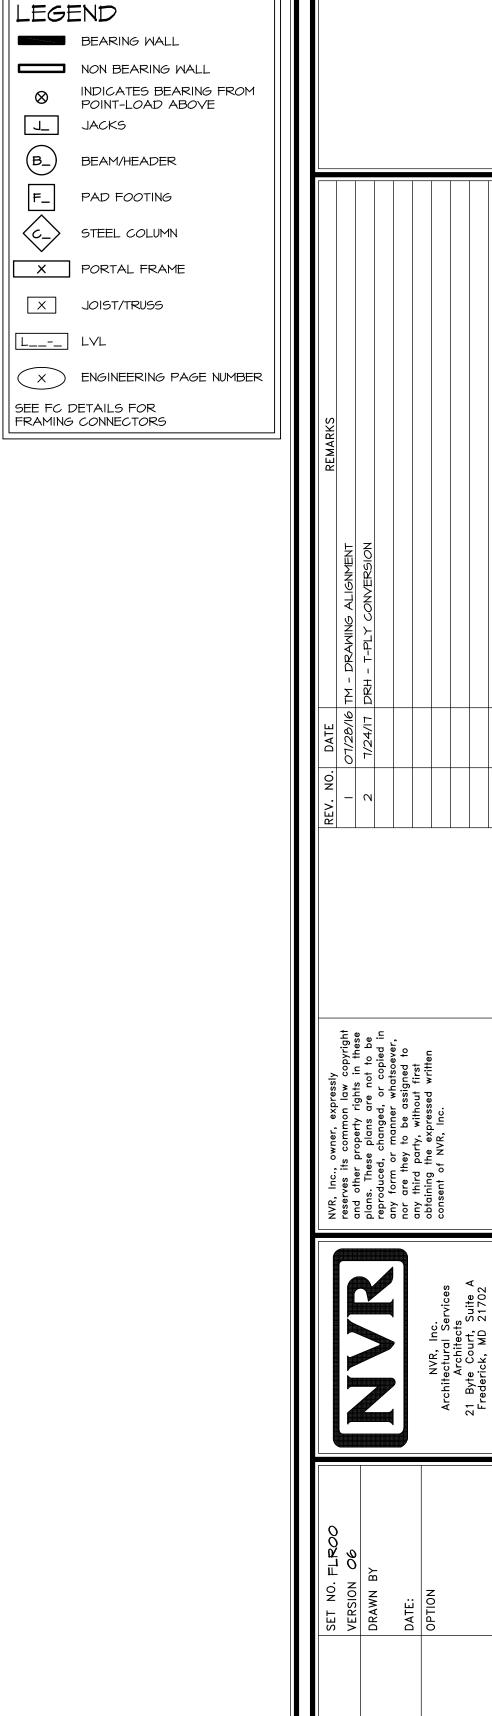



SECOND FLOOR JACK SCHEDULE | IDENTIFIER | DESCRIPTION | OPTIONS | ENG. NUM. | FIELD INSTALLED |

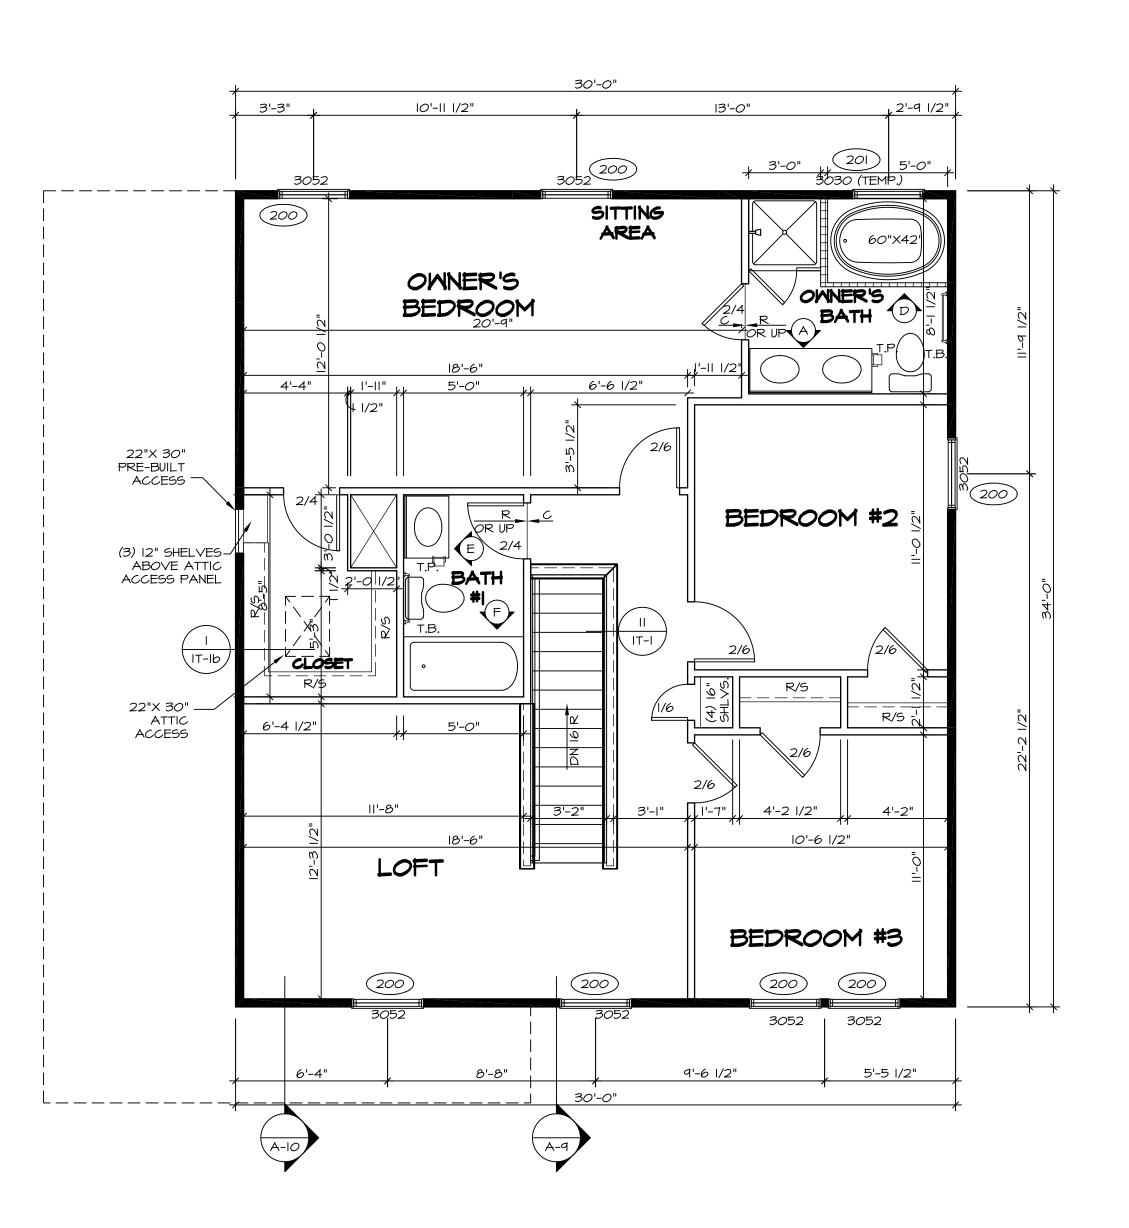

SECOND FLOOR PLAN

BEARING WALL  NON BEARING WALL  NON BEARING WALL  NON BEARING FROM POINT-LOAD ABOVE  JACKS  B_ BEAM/HEADER	
F_ PAD FOOTING  STEEL COLUMN  X PORTAL FRAME  X JOIST/TRUSS  L LVL  X ENGINEERING PAGE NUMBER  SEE FC DETAILS FOR FRAMING CONNECTORS	REMARKS
	REV. NO. DATE  1 O1/28/16 TM - DRAWING ALIGNMENT  2 1/24/17 DRH - T-PLY CONVERSION
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	NVR, Inc. Architectural Services Architects 21 Byte Court, Suite A Frederick, MD 21702 dwg 09/14/17 - 3:38 am
	SET NO. FLROO VERSION O6 DRAWN BY DATE: OPTION  Sheets\Lot Specific\37 A-8 PLN2_LS.c
	OPTION DESCRIPTION  SET NO. FLROO VERSION OF VERSION OF DRAWN BY DATE: OPTION DESCRIPTION  Solves\FLORENCE_FLROO_06\DCY-BN-0078\538429\Sheets\Lot Specific\37 A-8 PLN2_LS.dwg

RYAN

FLOOR PLAN NOTES

OTHERWISE NOTED.

ALL HEADERS ARE (2) 2x6 w/ 2x4 WALLS OR (3) 2x6 w/ 2x6 WALLS, UNLESS OTHERWISE NOTED.

2. ALL HEADERS TO HAVE (I) 2x4 OR 2x6 JACK AND KING STUD EACH END, UNLESS OTHERWISE NOTED.

OTHERWISE NOTED.

4. HATCHED AREAS INDICATE DROPPED CEILINGS. ALL DROPPED CEILINGS ARE 12" UNLESS OTHERWISE NOTED.

6. SEE STANDARD DETAIL CATEGORY "IT" SHEET(S) FOR INTERIOR TRIM DETAILS.


7. SEE ARCHITECTURAL DETAIL SHEET "AD" FOR HOUSE SPECIFIC INTERIOR TRIM OPTION TABLE.

8. ALL WINDOWS HAVE 7'-0 1/2" HEADER HEIGHT UNLESS


ALL HEADERS IN NON-BEARING WALLS SHALL BE A SINGLE FLAT 2X4 OR 2X6 ATTACHED TO CRIPPLES ABOVE, UNLESS OTHERWISE NOTED.

5. SEE "BRACED WALL PANEL DETAIL SHEET" FOR SPECIAL WALL FRAMING LOCATIONS AND HEADER SIZES, IF APPLICABLE.


3. ALL EXTERIOR WALLS TO BE 4" W/ OSB OR 3 1/2" W/ T-PLY, ALL INTERIOR WALLS TO BE 3 1/2", UNLESS

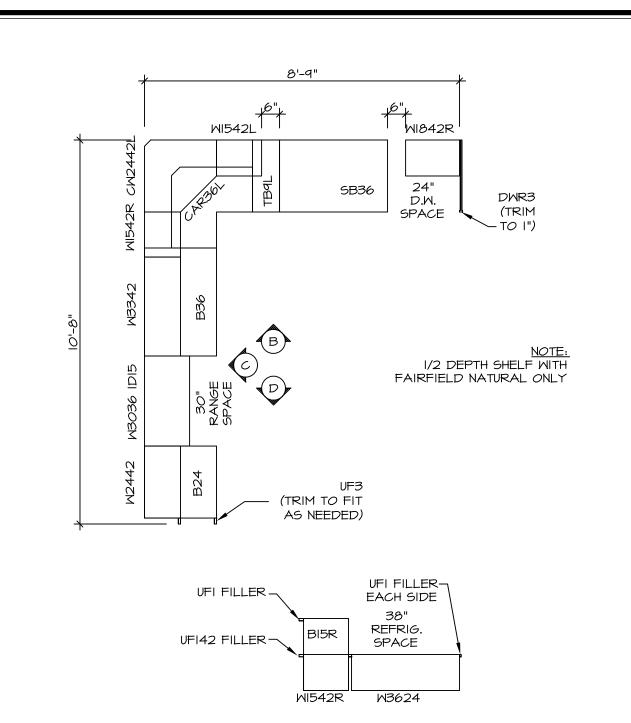



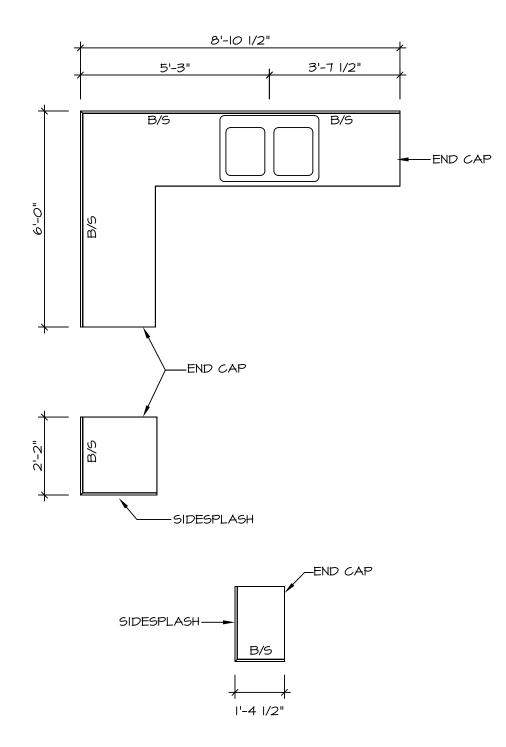




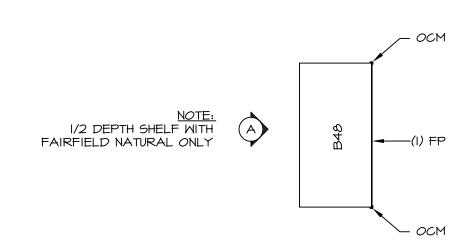

OPT. ISLAND PLAN
- KC-2900

SCALE: 3/8" = 1'-0"


A-12

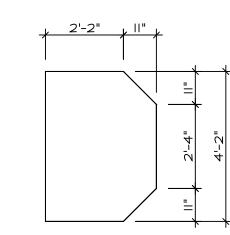

OPT. ISLAND COUNTERTOP
PLAN - KT-2900


SCALE: 3/8" = 1'-0"

A-12

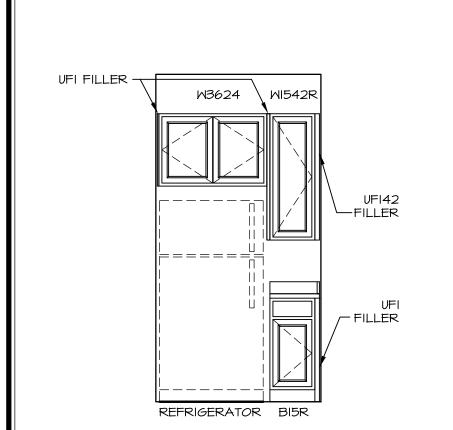


ELEVATION


SCALE: 3/8" = 1'-0"

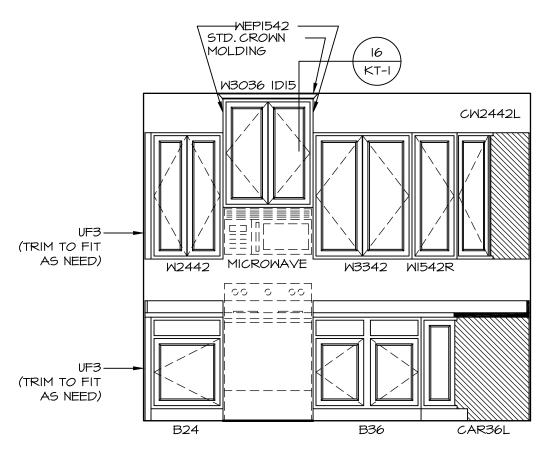




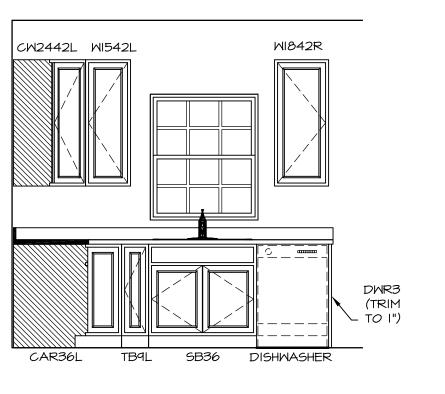




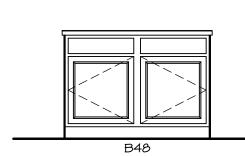





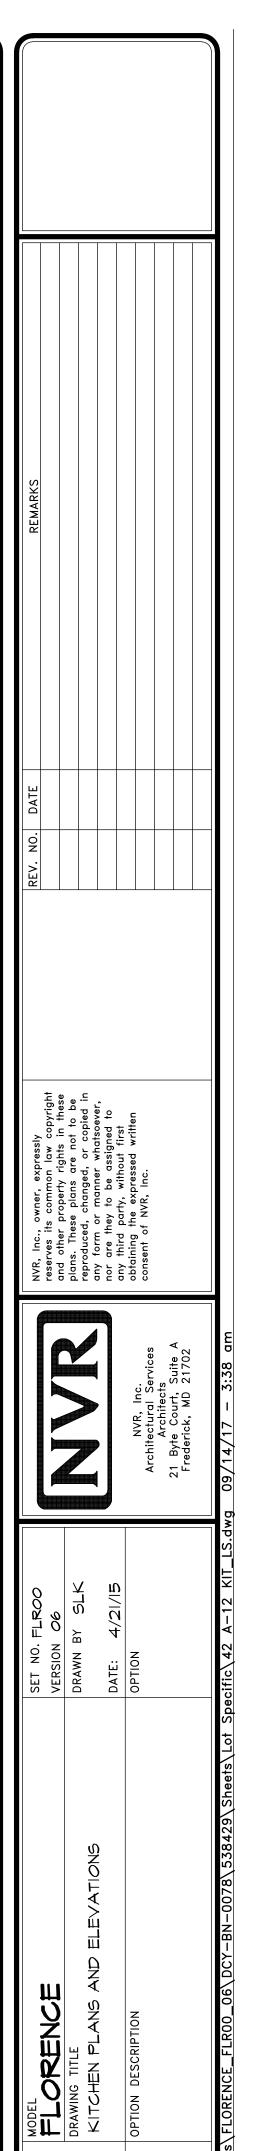

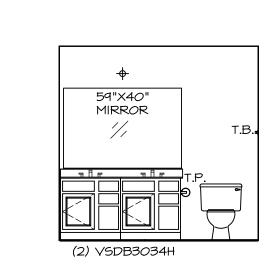




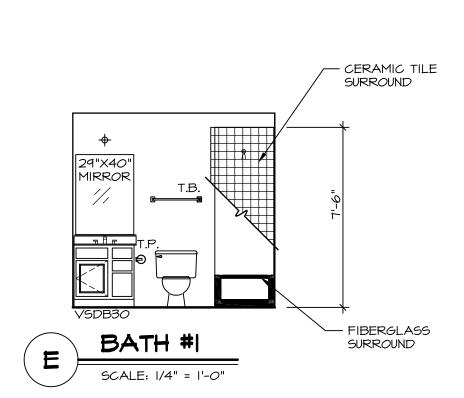


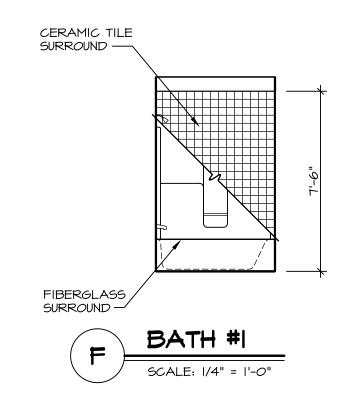


OVAL MIRROR

PEDESTAL SINK WITH OVAL MIRROR POWDER ROOM

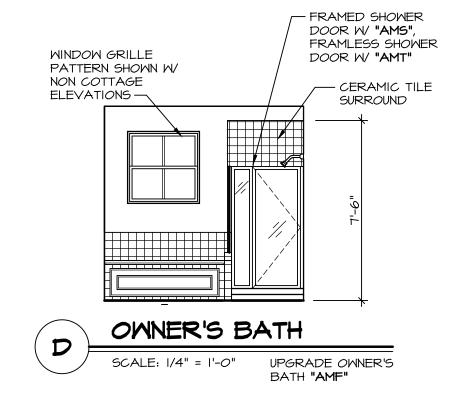

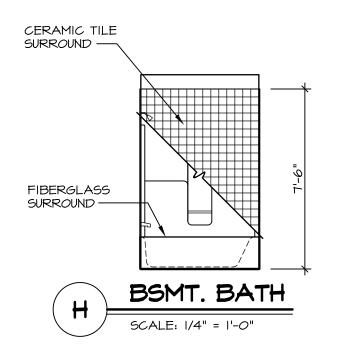

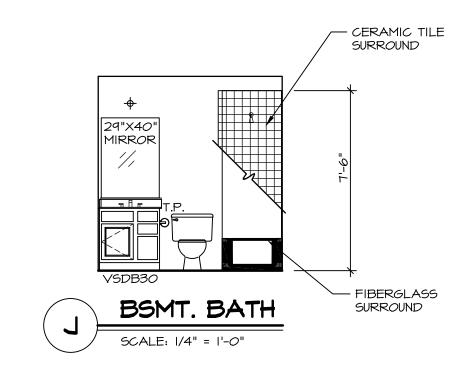

# NOTES:

- TEMPERED GLASS SHOWER
   ENCLOSURE WITH SWING DOOR OR
   OPTIONAL SLIDING DOOR BY DIVISION
   TUB ACCESS PANELS PROVIDED AS
   NEEDED, ALL MATERIALS BY DIVISION
   REFER TO SHEET (IT-2) FOR TUB AND
   SHOWER DETAILS.
   ALL VSDB24-42 DRAWERS TO BE SET ON
   RIGHT HAND.
   BATH FLEVATIONS ARE SHOWN PER PLAN
- 5. BATH ELEVATIONS ARE SHOWN PER PLAN.