PROJECT:

BUILDING 1 209, 211, 217, 219 JOYCE LANE WEST

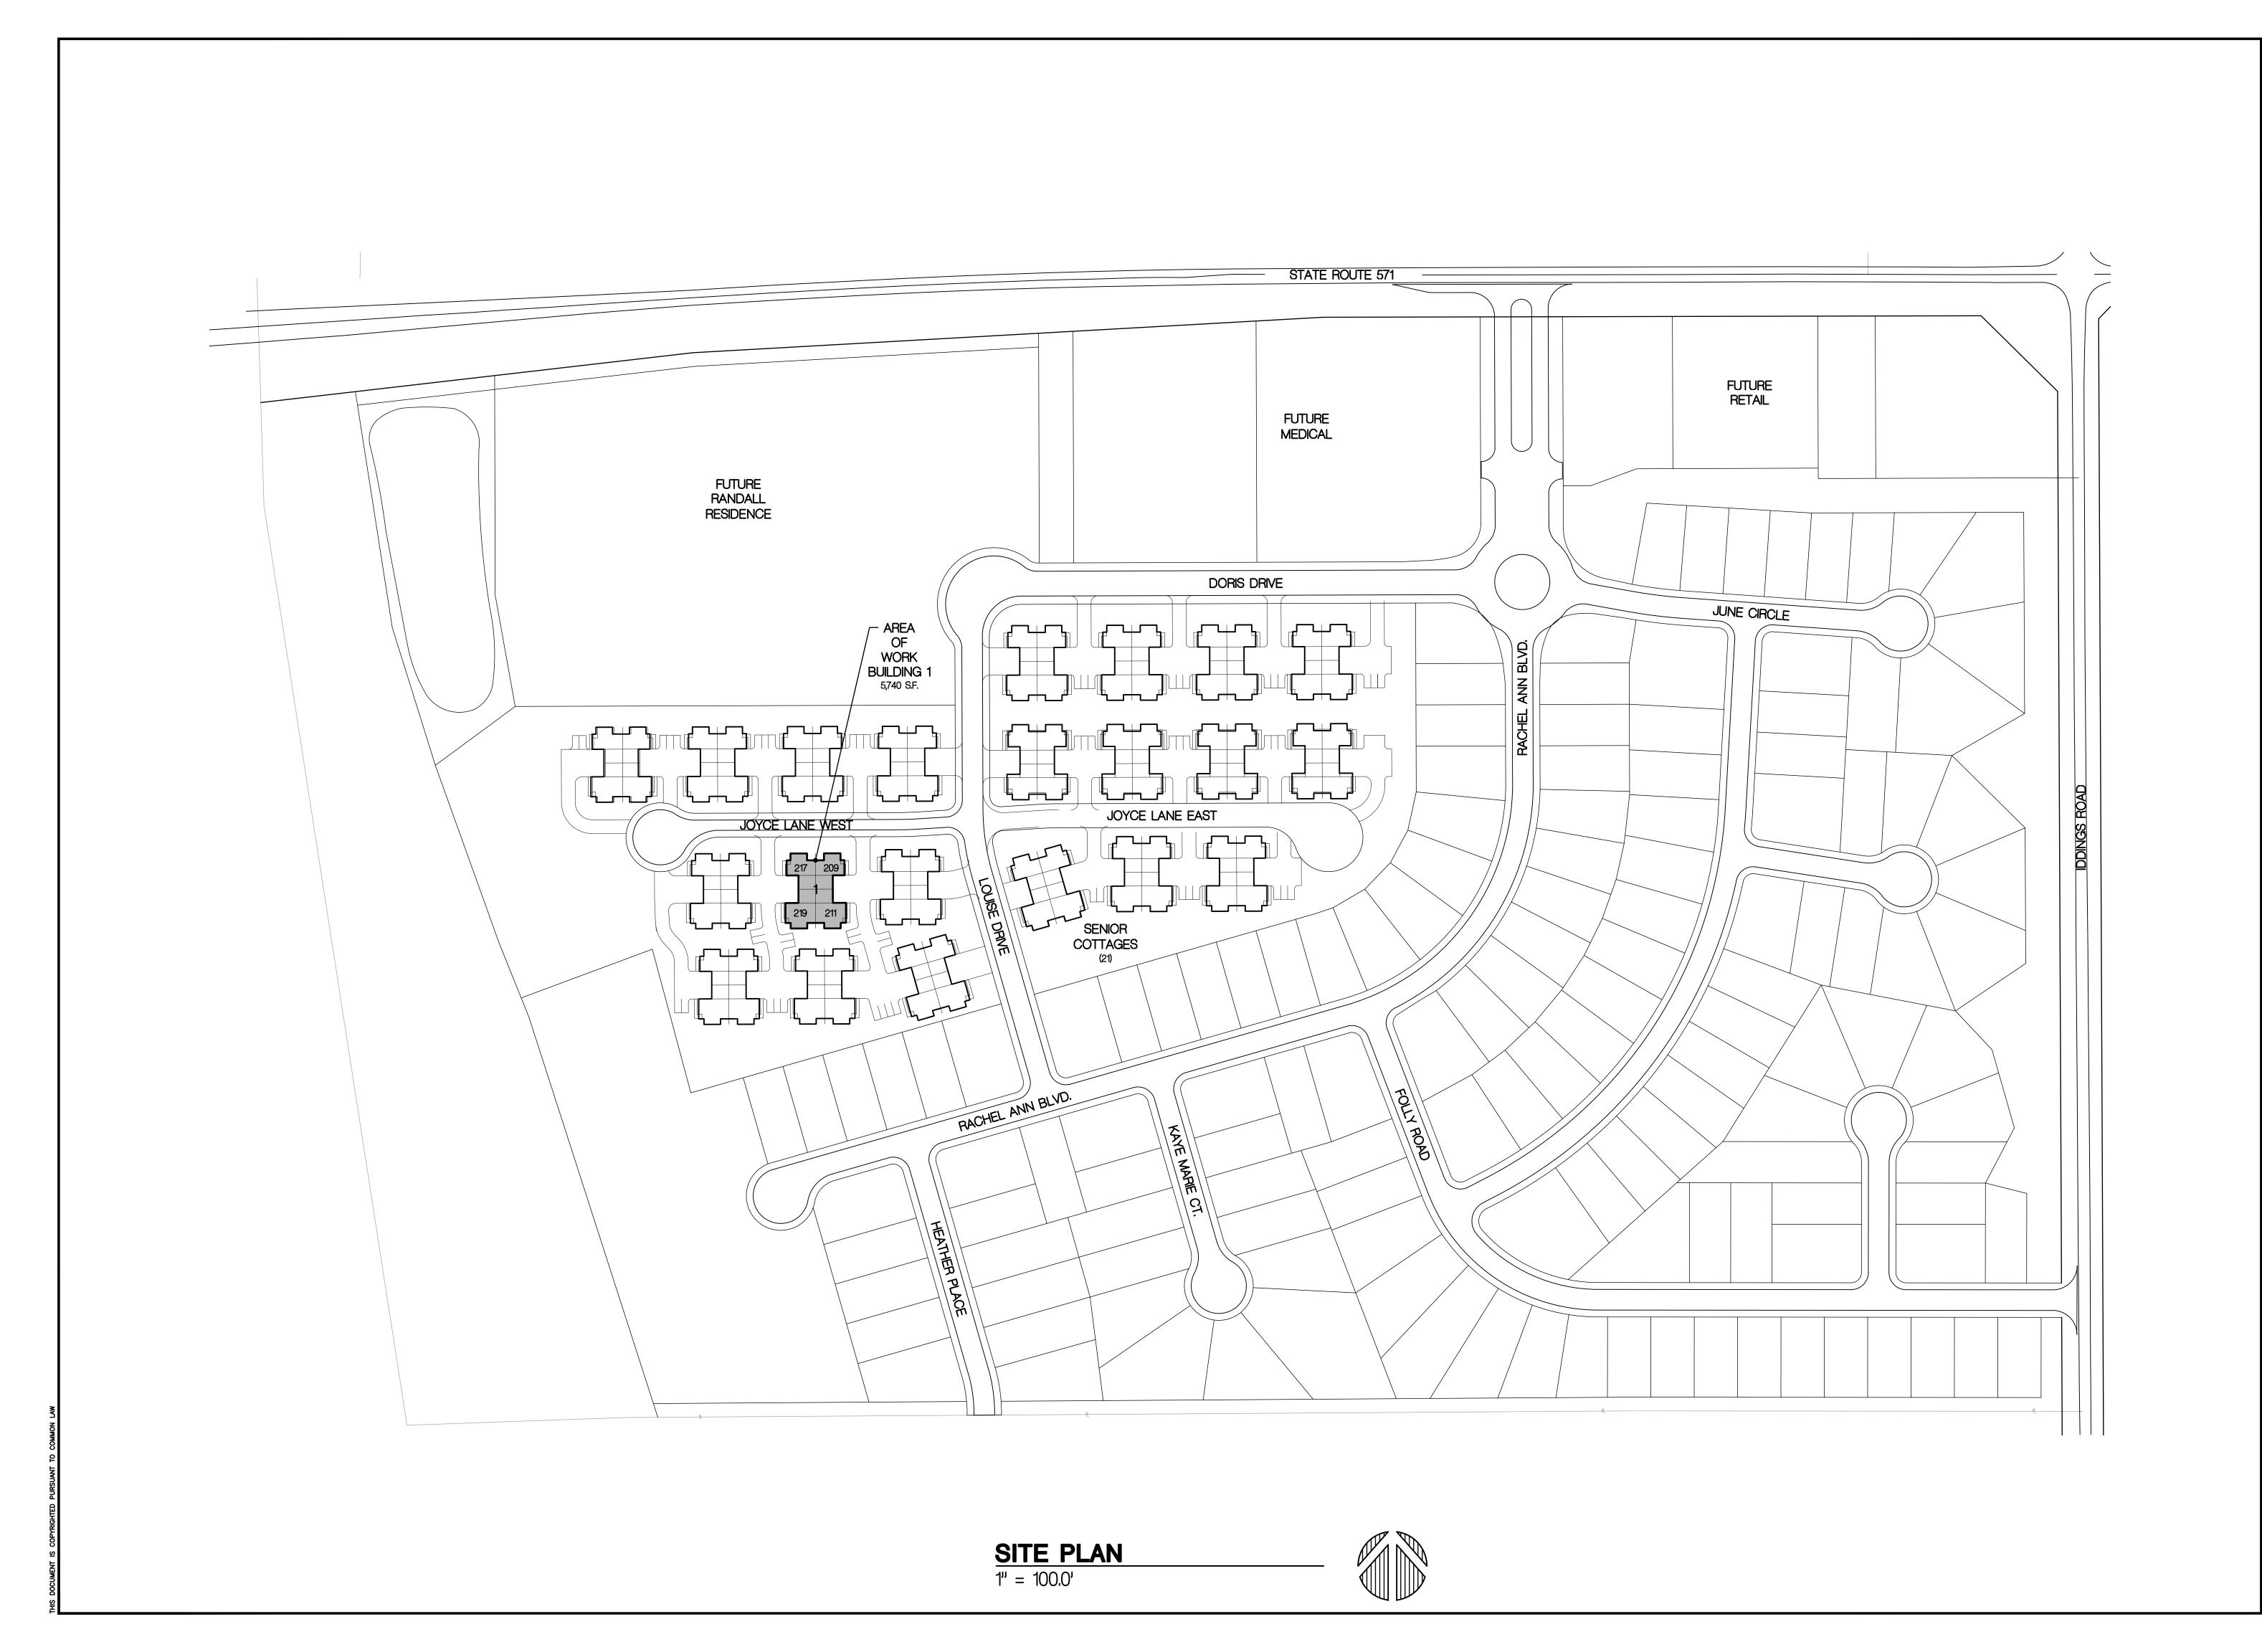
THE VILLAS RANDALL RESIDENCE WEST MILTON, OHIO 45383

OWNER:

TVWM LLC

310 WHITE OAK ROAD **LAWTON, MI 49065**

	DAMAING IN	DEV	DATE	DESCRIPTION		
L	RAWING IN	DEX	3-15-23	BUILDING PERMIT		
ARCHITECTURAL	5-31-23	PERMIT CORRECTIONS				
TS TITLE SHEET A1-1 SITE PLAN A2-1 BUILDING PLAN						
A2-2 UNIT PLAN - VILLA A3-1 ROOF PLAN	A A					
A4-1 EXTERIOR ELEVATION A5-1 WALL SECTIONS	NS					
A5-2 WALL SECTIONS A5-3 WALL SECTIONS A6-1 SCHEDULES, WINDO	DW & DOOR DETAILS					
STRUCTURAL	W & DOOR DETAILS					
S-1 FOUNDATION PLAN S-2 ROOF FRAMING PU	AN					
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P.M.E.						
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PLUMBING P-1 PLUMBING PLAN -	THE STATE OF					
P-2 PLUMBING DETAILS P-3 PLUMBING ISOMETRICS - VILLA A				* REGI		
HVAC						
H-1 HVAC PLAN - VILL	A A		(-RS 45439 45439		
ELECTRICAL E-1 ELECTRICAL PLAN - VILLA A				Z =		
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	CODE NOT	EC		ARC 3176 KET PHONE		
SEC DESCRIPTION	2017 OHIO BUILDING CO	UE.	4			
310.5 EXISTING USE &	OCCUPANCY CLASSIFICATION: RESID	ENTIAL GROUP R-3.				
310.5.5 MULTI-FAMILY A RESIDENTIAL COI						
310.5.5 CONDITION 6: FI SECTION 302.2						
T601 TYPE OF CONSTRUCTION: VB (NO FIRE—RESISTANCE RATING OF BUILDING ELEMENTS, EXCEPT PER RCO REQUIREMENTS BELOW).						
903.2.8.1 AUTOMATIC SPRINKLER SYSTEM NOT REQUIRED, NOT PROPOSED.						
SEC DESCRIPTION 2019 OHIO RESIDENTIAL CODE						
302.2 2-HOUR FIRE S BETWEEN EACH	EPARATION BETWEEN EACH 2-UNIT	GROUPING; 1-HOUR SEPARATION	25			
T302.1 EXTERIOR WALLS: NO FIRE-RESISTANCE RATING REQUIRED.						
T302.6 DWELLING/GARAGE SEPARATION: NOT LESS THAN 1/2" GYP. BOARD ON GARAGE SIDE.						
310.1 EMERGENCY ESC CLEAR OPENING 20 IN.	-	Stillwater Crossings				
311.2 EGRESS DOOR: HEIGHT OF 78	UNIT ENTRY DOOR HAS MIN. CLEAR N.	WIDTH OF 32 IN., MIN. CLEAR	3	ない。		
320.2 ACCESSIBILITY: / OF ICC/ANSI A1	ALL DWELLING UNITS ARE DESIGNED 17.1.	AS TYPE B UNITS PER CHAP. 10				
	DIDECTOR	ov.				
DIRECTORY						
CURIER	T	CUDICTORUED DANIDALI				
OWNER:	TVWM LLC 310 WHITE OAK ROAD LAWTON, MI 49065	CHRISTOPHER RANDALL (269) 624-4841 CELL (269) 377-8111				
		EMAIL ccrorandallresidence.com				
DESIGN/BUILD CONTRACTOR:	LIFESTYLE CONSTRUCTION, LLC P.O. BOX 936 SPRINGBORO, OHIO 45066	JAYSON MORRIS (513) 709-8814 EMAIL jmorris@gracedevelopments.com		56133		
	SPRINGBORO, ONIO 43000	Limit jiionisagraceaevelopinents.com	Bl	PROJECT TITLE JILDING 1		
ARCHITECT:	ROLL & ASSOCIATES, INC.	JOHN ROLL		ILLAS @		
TANKING AND ADDRESS OF THE PARTY OF THE PART	3176 KETTERING BOULEVARD DAYTON, OHIO 45439	(937) 299-4243 FAX (937) 299-3254	WES	OWG, TITLE		
		EMAIL jroll@rollassoc.com		TITLE		
CRAL CHONCED	OHOLOG ONE ENGINEERING	THE DISTRICT		SHEET		
CIMIL ENGINEER:	CHOICE ONE ENGINEERING 440 E. HOEWISHER ROAD SIDNEY, OHIO 45365	JEFF PUTHOFF PH. (937) 497-0200 CELL (937) 726-0478		DWG. NO.		
		EMAIL jsp@choiceoneengineering.com				
				TS		



DATE DESCRIPTION

3-15-23 BUILDING PERMIT

5-31-23 PERMIT CORRECTIONS

A SANTE OF ONL SANTED ARCHITECT 10658

ACLL & ASSOCIATES, INC.
ARCHITECTS & PLANNERS
176 KETTERING BOULEVARD DAYTON, OHIO 45439
HONE (937) 299-4243 FAX (937) 299-3254



Stillwater Crossings Your Hometown Lifestyle




PROJECT NO.
56133

PROJECT TITLE

BUILDING 1
VILLAS @
WEST MILTON

SITE PLAN

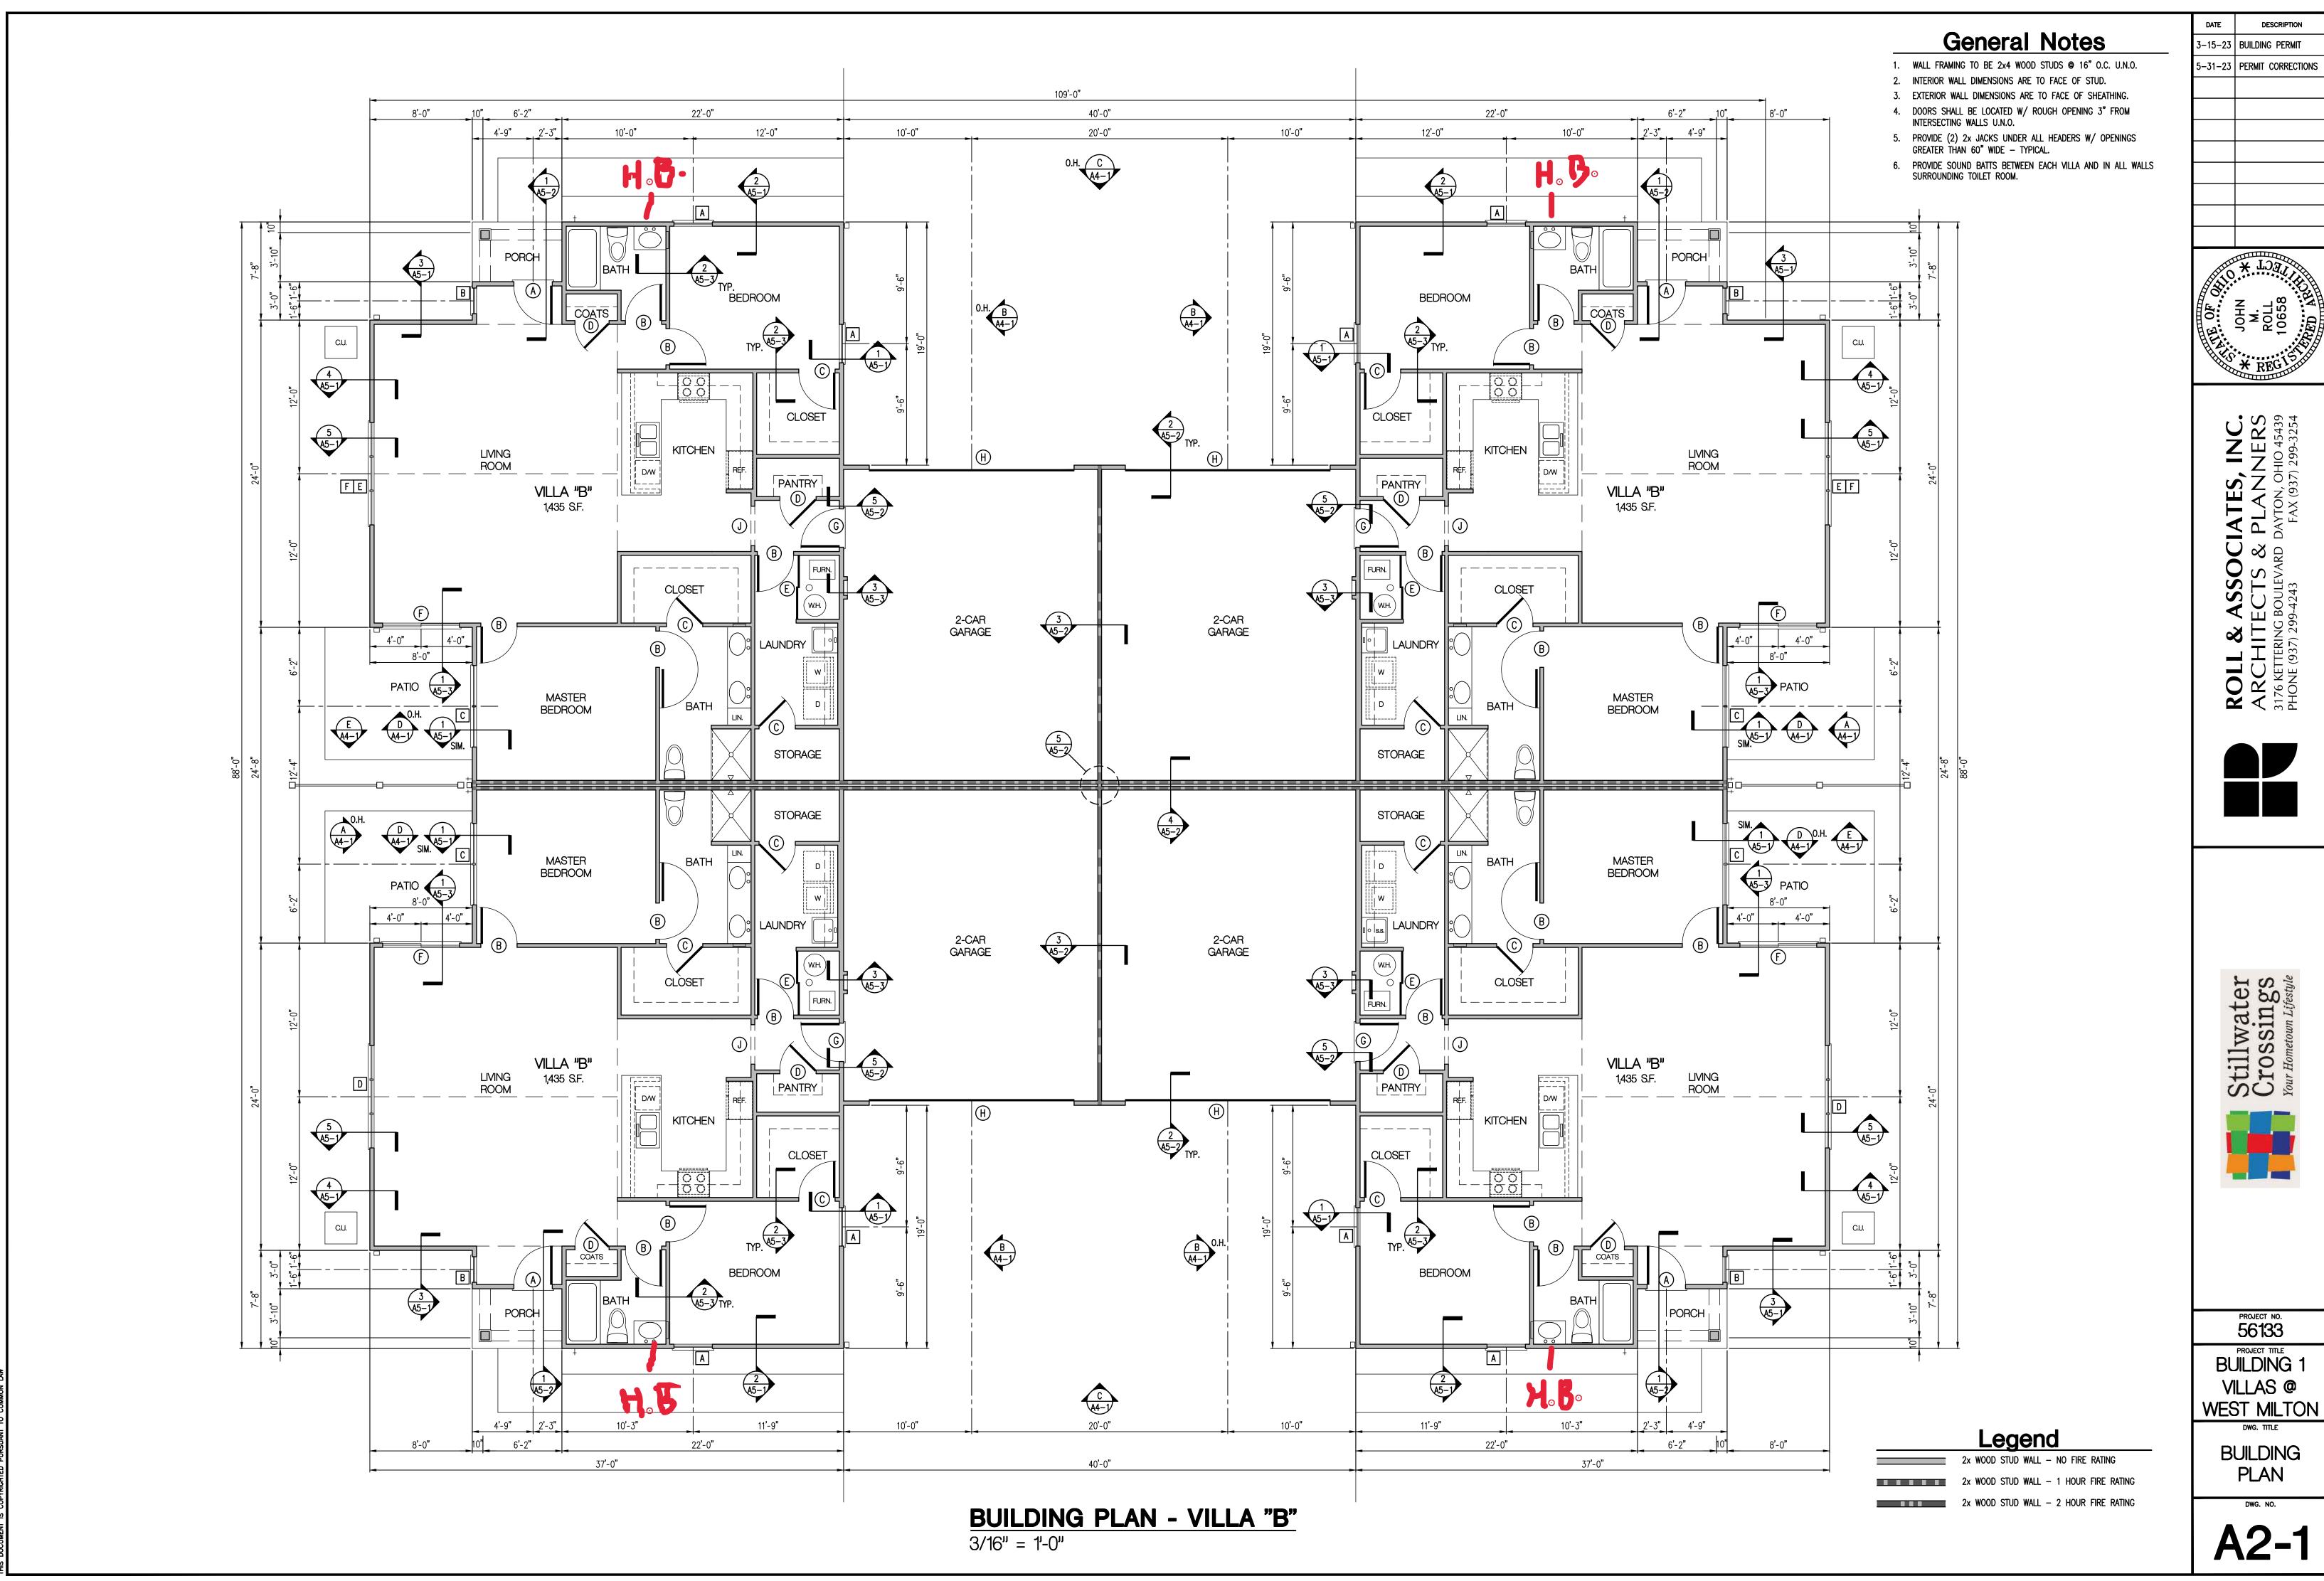A1-1




3-15-23 BUILDING PERMIT 5-31-23 PERMIT CORRECTIONS



PROJECT TITLE
BUILDING 1 VILLAS @

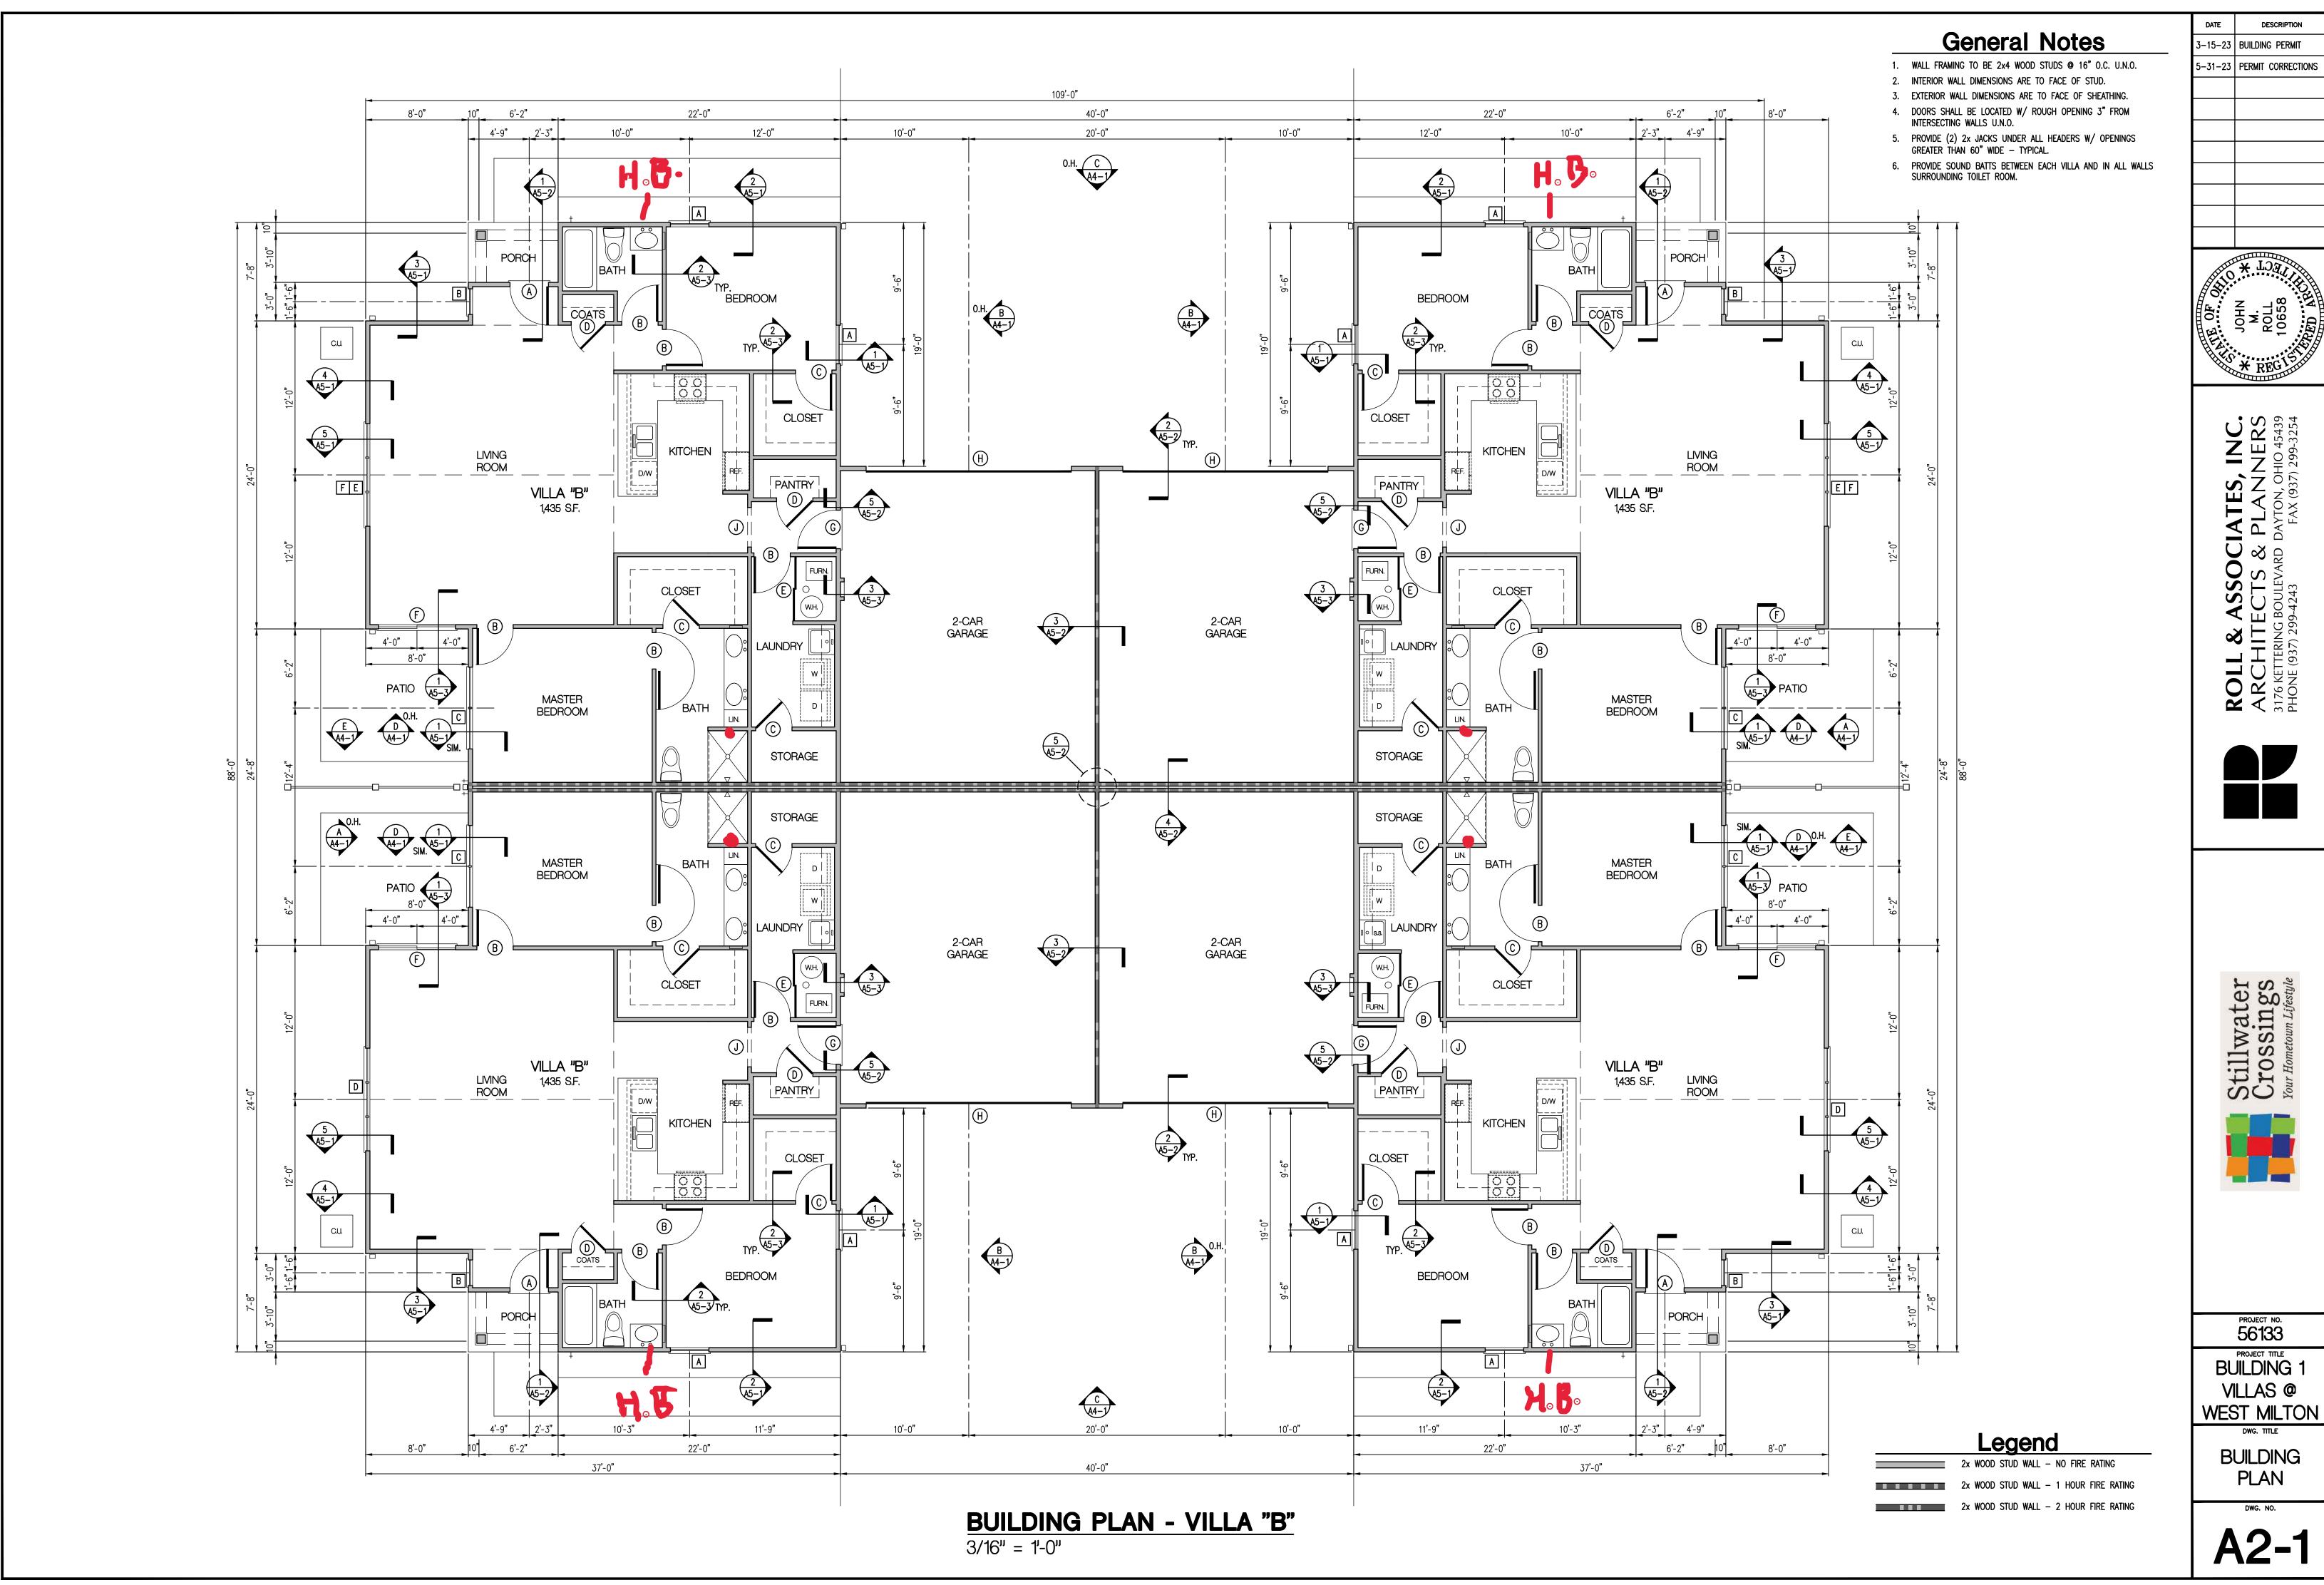BUILDING




3-15-23 BUILDING PERMIT 5-31-23 PERMIT CORRECTIONS



Stillwater Crossings

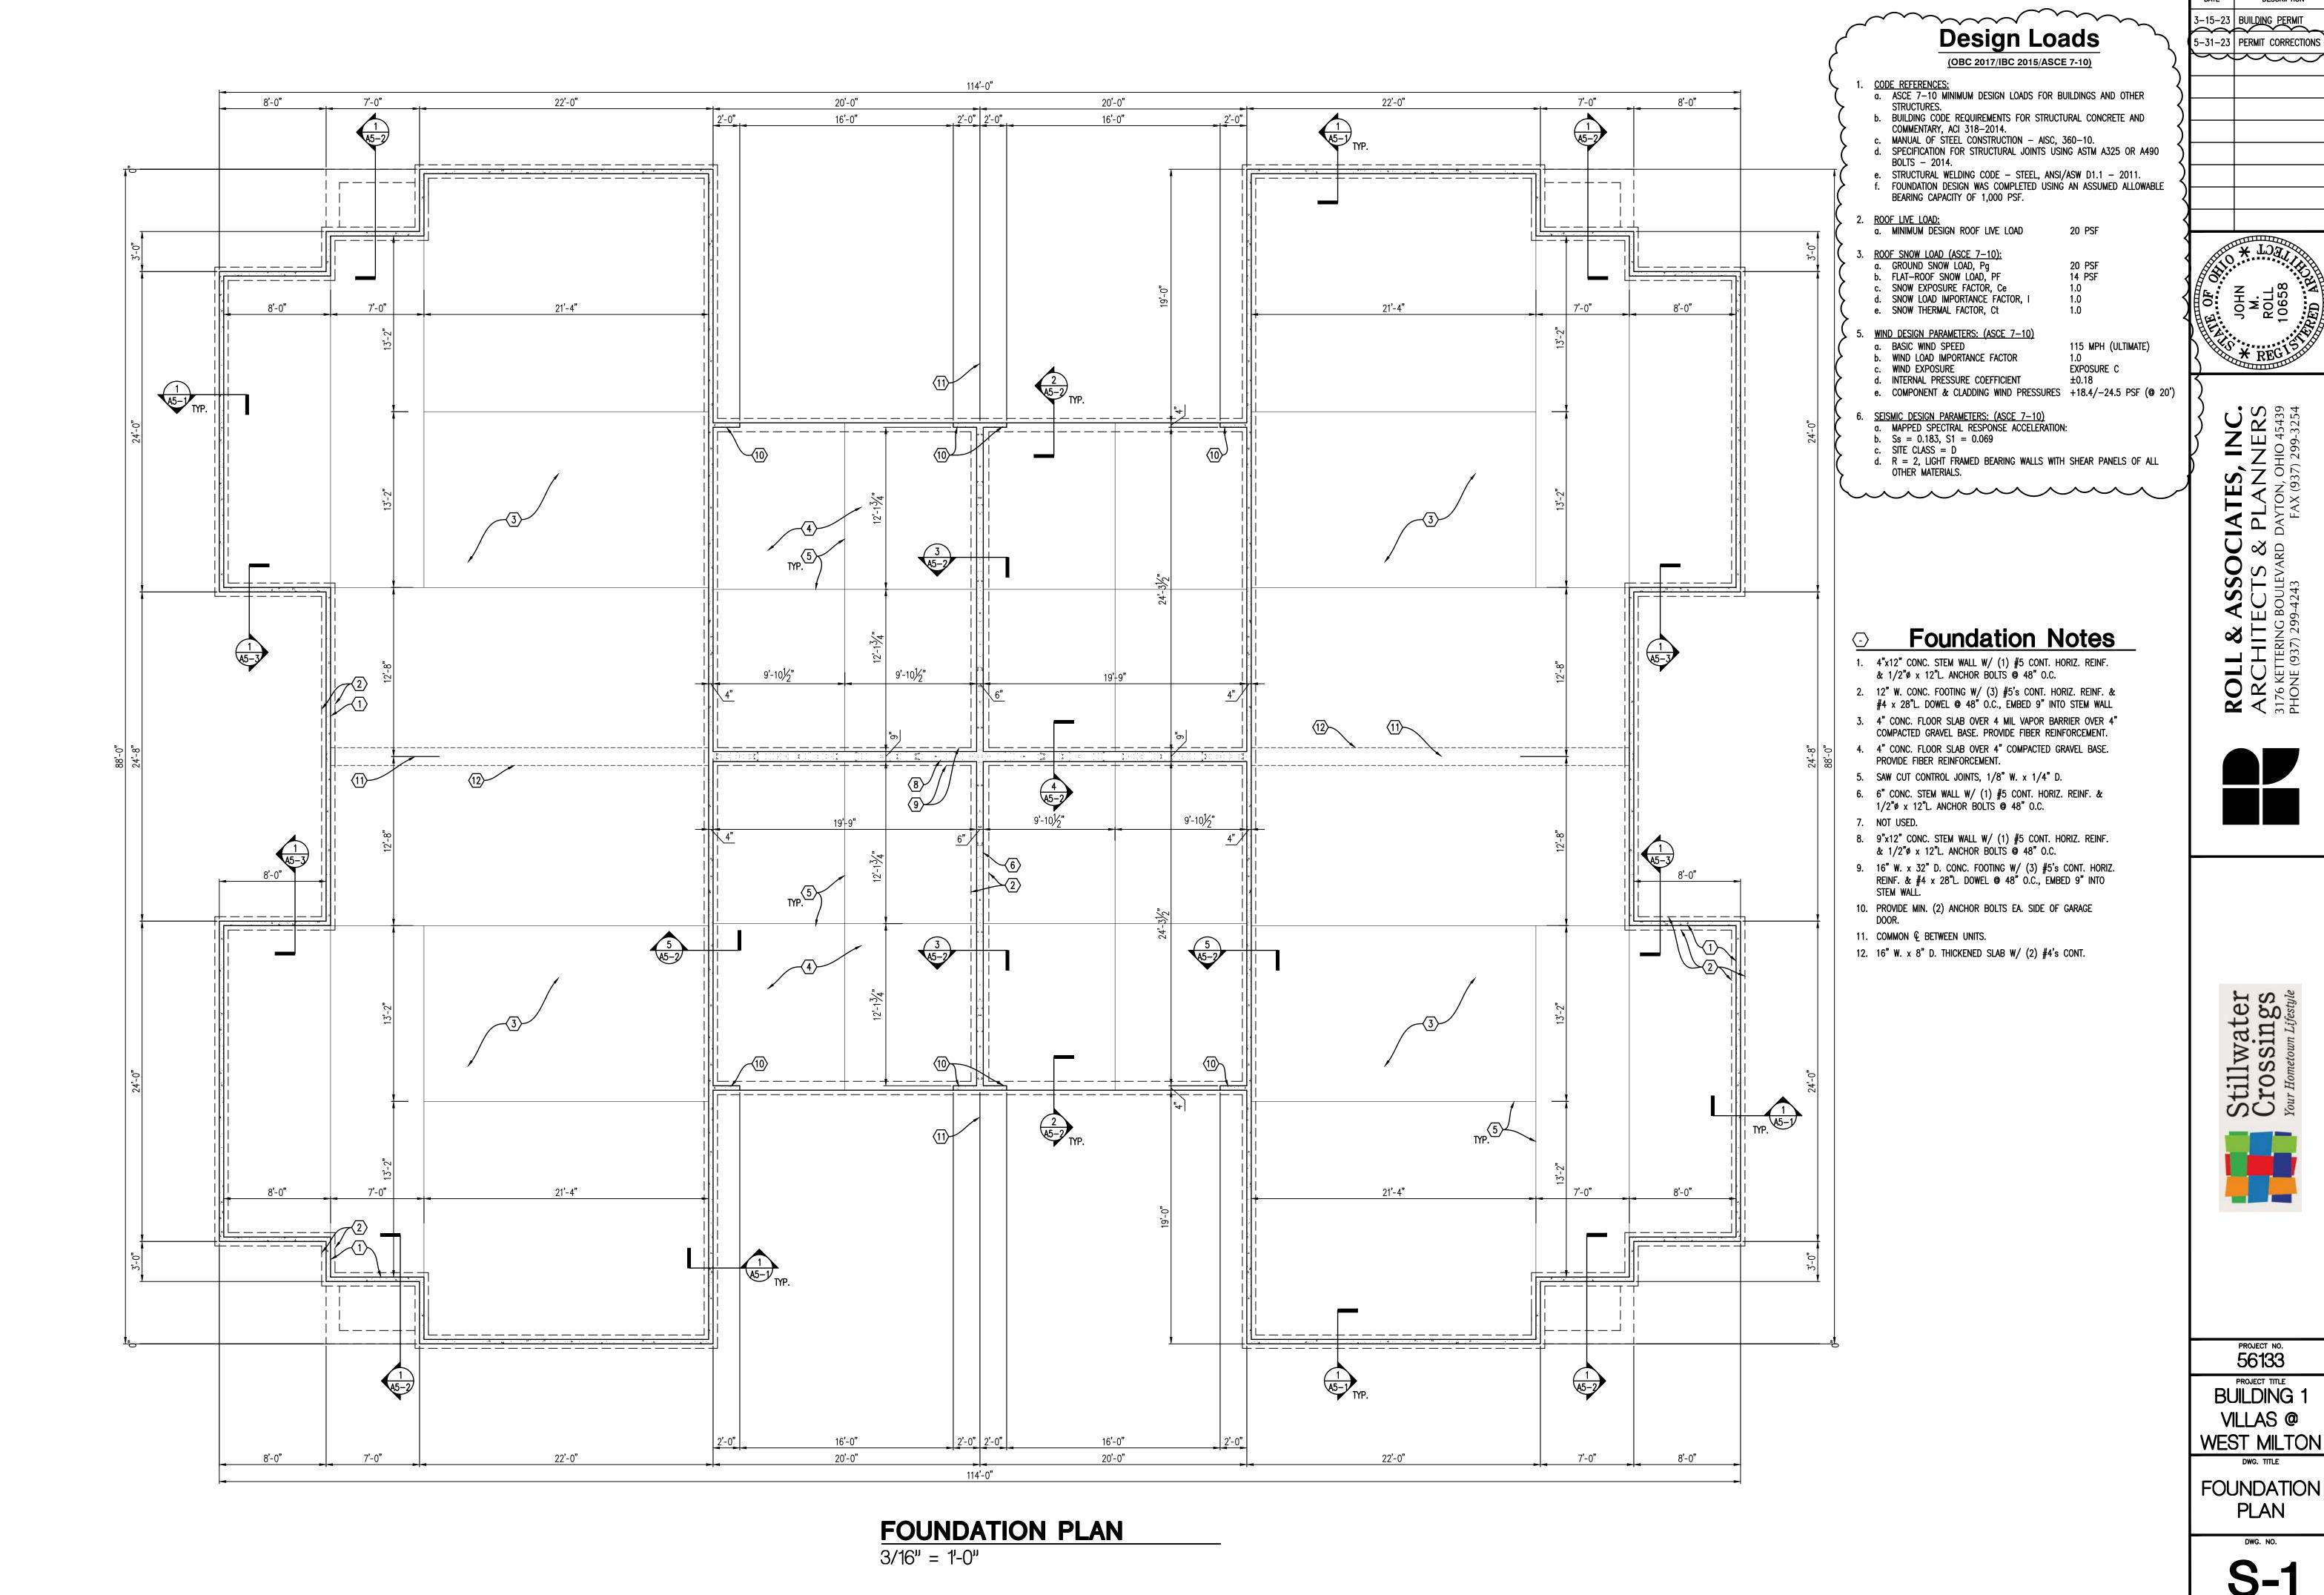PROJECT TITLE
BUILDING 1 VILLAS @

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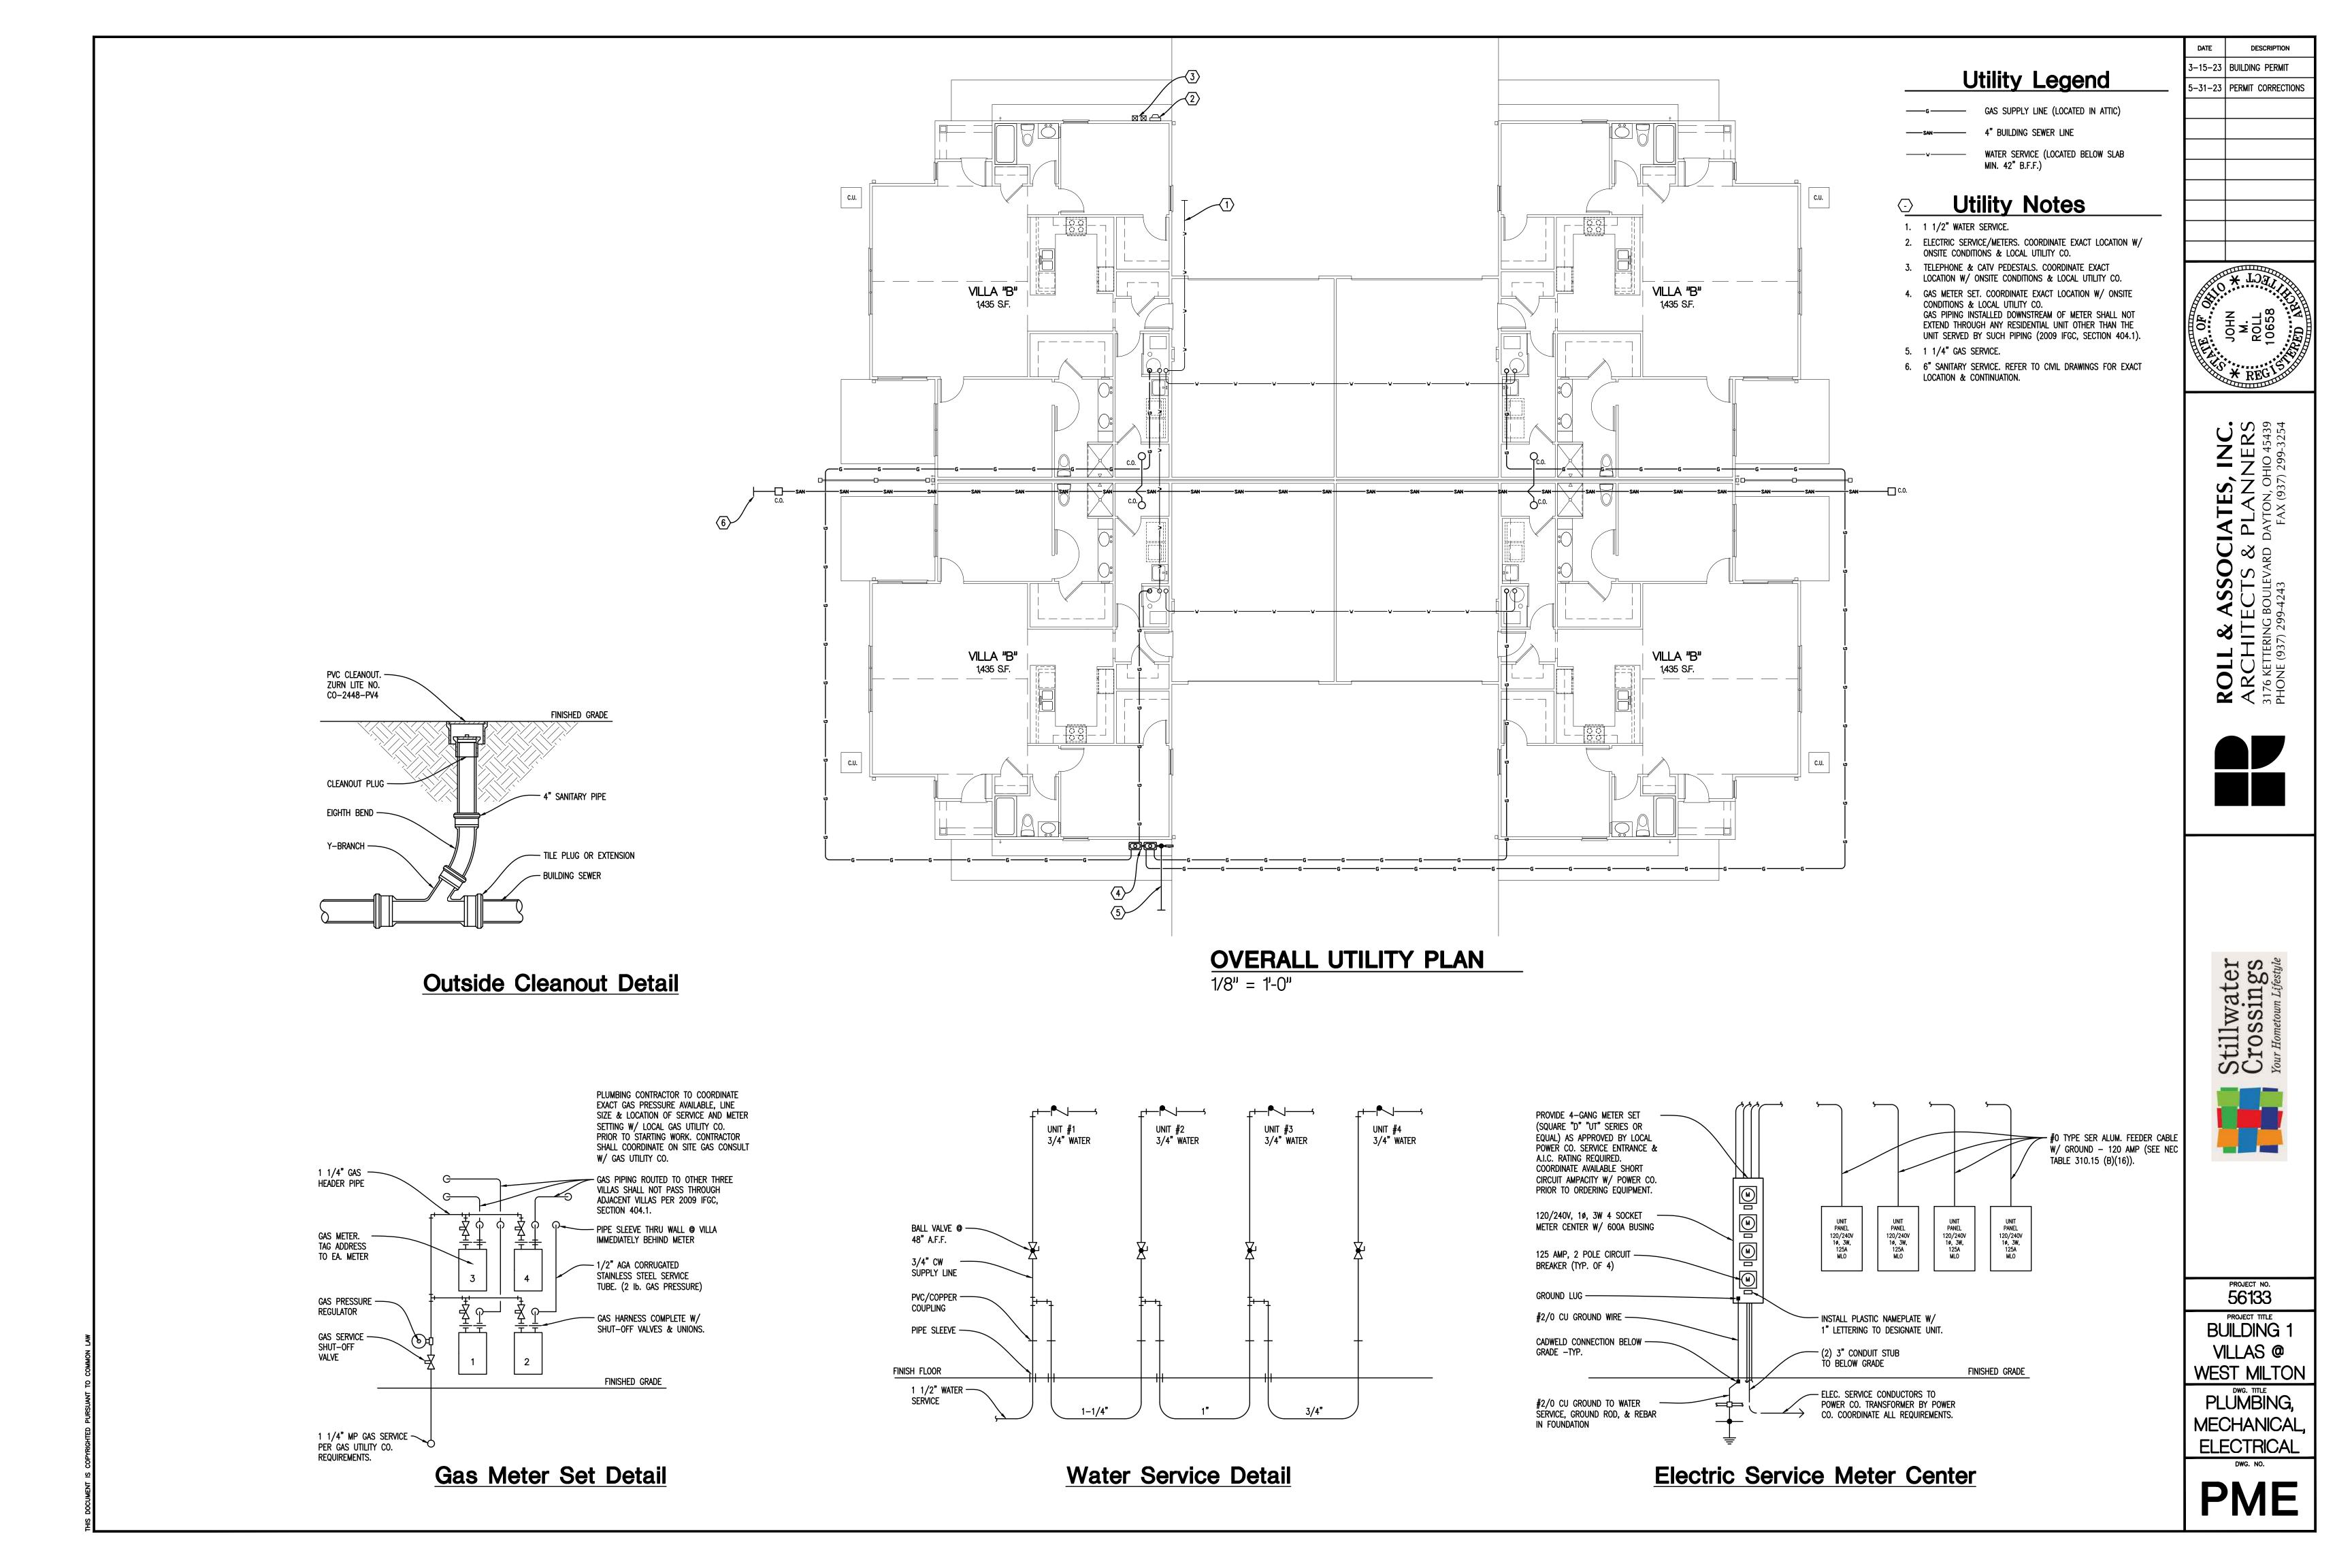
INCRS (1) 299-3254




PROJECT NO. **56133**

PROJECT TITLE
BUILDING 1 VILLAS @ WEST MILTON

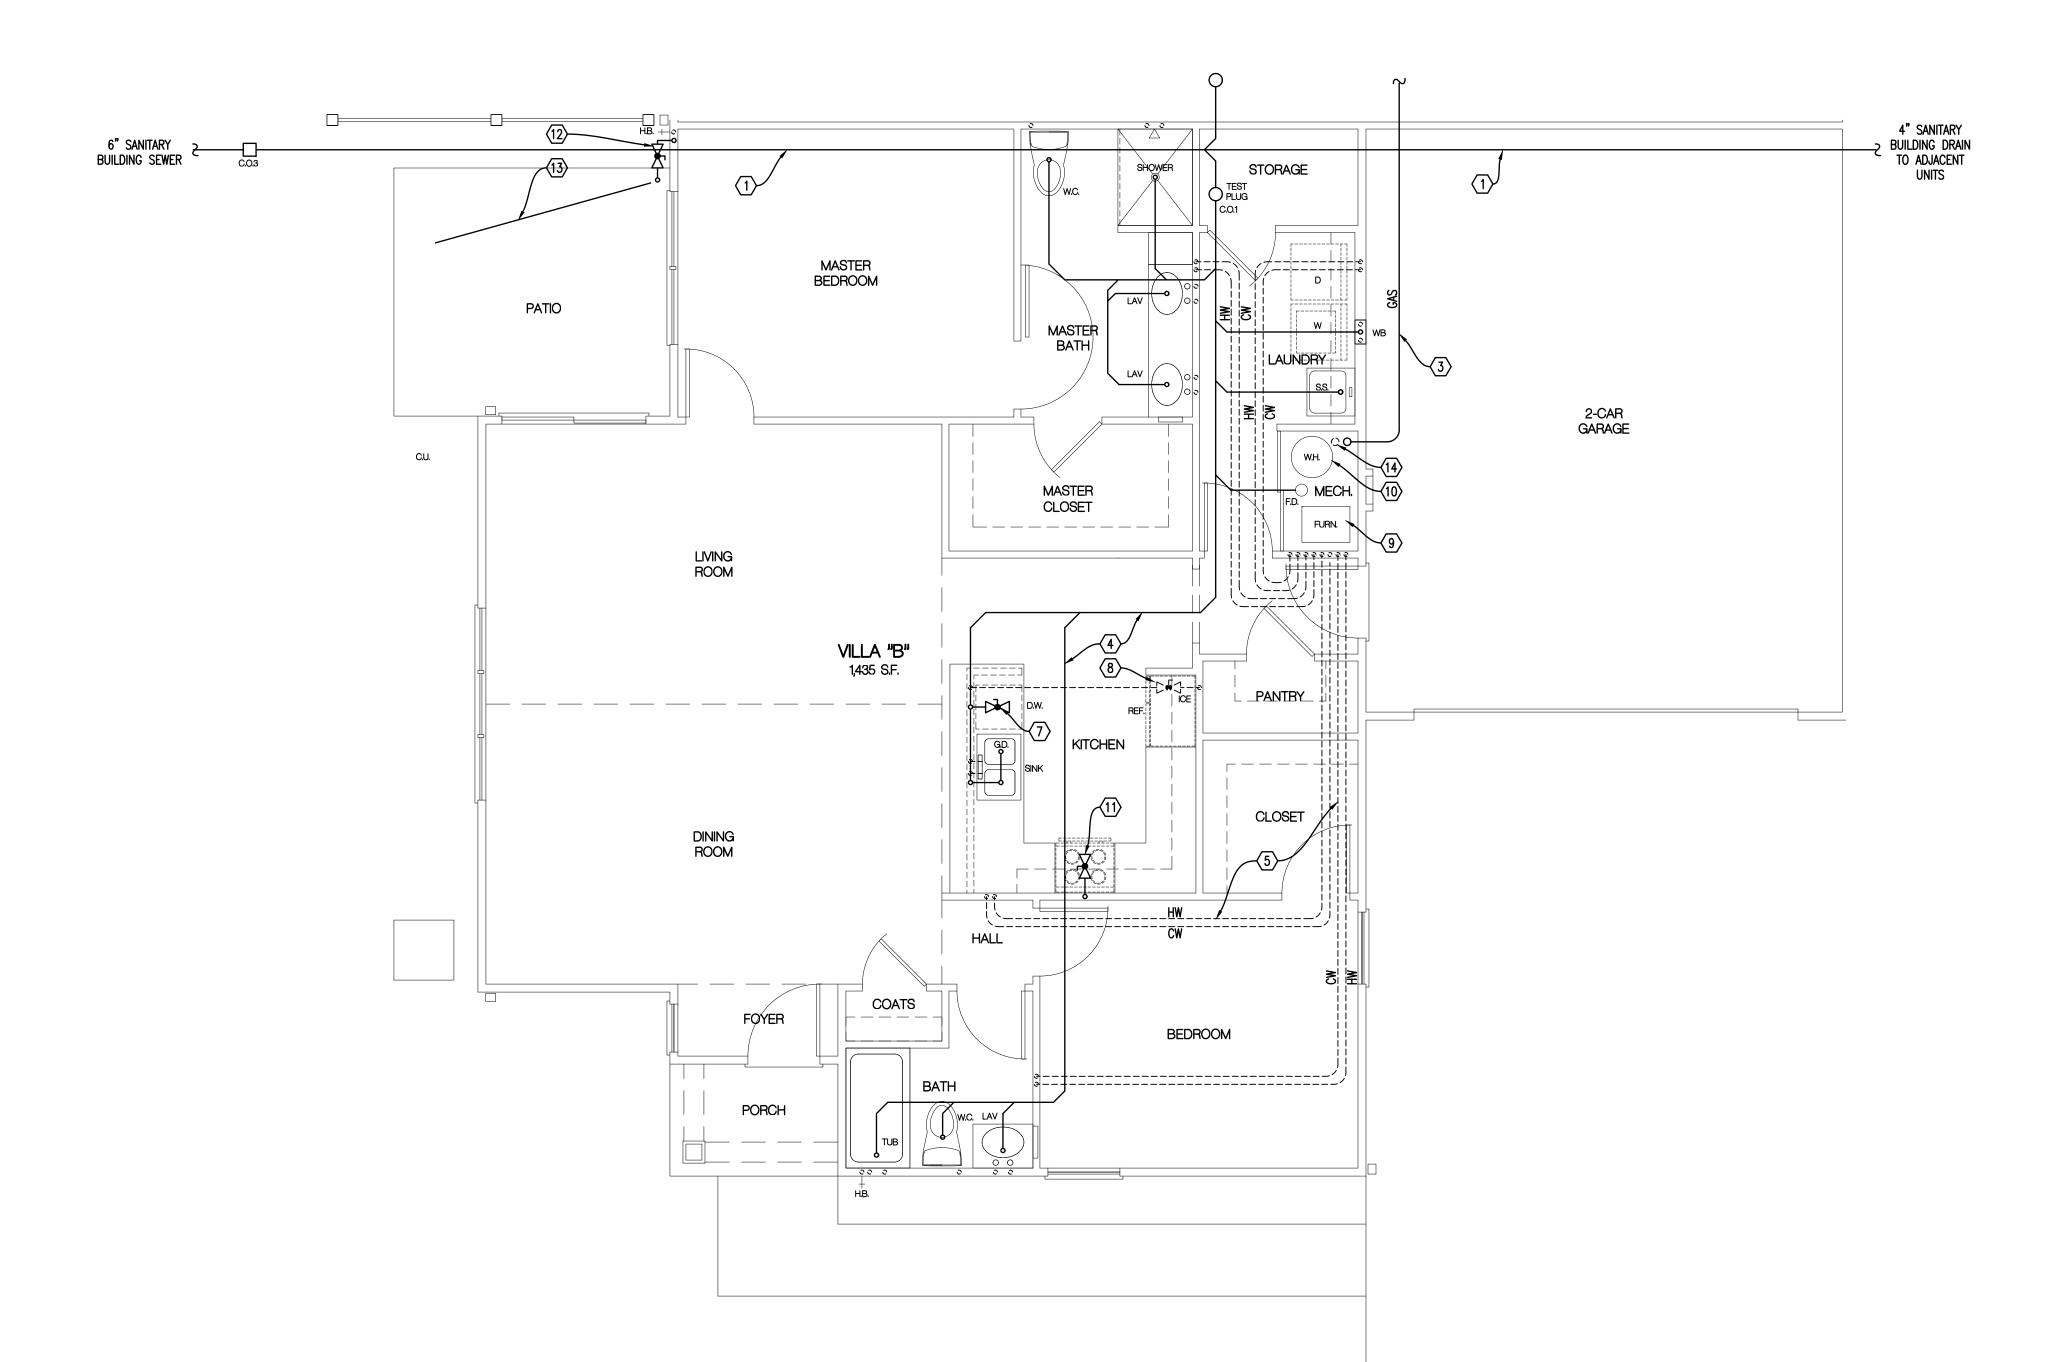FOUNDATION PLAN





PLUMBING PLAN - VILLA "B"

1/4" = 1'-0"

General Notes

- SANITARY BUILDING SERVICES SHALL BE SDR-35 AND AS APPROVED FOR USE BY LOCAL UTILITY.
- SANITARY DRAIN WASTE & VENT PIPING SHALL BE SCH 40 PVC SOLVENT WELD PIPE & FITTINGS. PIPING SHALL BE SLOPED AS FOLLOWS; 3" OR SMALLER 1/4" PER FOOT, 4" AND LARGER 1/8" PER FOOT.
- WATER SERVICE SUPPLY PIPING SHALL BE POLYETHYLENE TUBING OR TYPE "K" SOFT COPPER AND AS APPROVED FOR USE BY LOCAL UTILITY.
- PROVIDE 1 1/2" WATER SERVICE TO EACH BUILDING. PROVIDE 3/4" WATER SERVICE TO EACH UNIT. REFER TO OVERALL BUILDING PLANS & COORDINATE WITH LOCAL WATER UTILITY.
- BUILDING PLANS & COORDINATE WITH LOCAL WATER UTILITY.
 PROVIDE WATTS LF7R BACKFLOW DEVICE ON WATER SERVICE TO EACH INDIVIDUAL UNIT.
- PROVIDE MINIMUM 1/2" WATER SUPPLY PIPE TO EACH
 PLUMBING FIXTURE. PIPING TO BE INSTALLED BELOW FLOOR
 SLAB (NO FITTINGS PERMITTED BELOW SLAB). WATER SUPPLY
 PIPING SHALL BE AS FOLLOWS; TYPE "K" SOFT COPPER
 TUBING (BELOW SLAB), TYPE "L" HARD COPPER TUBING
 (ABOVE SLAB), CPVC COILED PLASTIC TUBING (BELOW SLAB),
 CPVC RIGID PLASTIC TUBING (ABOVE SLAB).
- GAS SERVICE SUPPLY PIPING SHALL BE AS REQUIRED BY LOCAL GAS UTILITY.
- PROVIDE GAS METER & RISER ASSEMBLY FOR EACH UNIT PER LOCAL GAS UTILITY REQUIREMENTS.
- PROVIDE MINIMUM 1/2" GAS SUPPLY PIPE TO EACH
 DESIGNATED PIECE OF EQUIPMENT. PIPING TO BE INSTALLED IN
 VENTILATED ATTIC. GAS SUPPLY PIPING SHALL BE AS FOLLOWS:
 SCH 40 BLACK STEEL PIPE, CSST TUBING.
- PROVIDE GAS SUPPLY PIPE TO THE FOLLOWING EQUIPMENT: FURNACE, RANGE, FIRE PIT.
- ALL PIPING SYSTEMS SHALL COMPLY WITH STATE AND LOCAL CODE REQUIREMENTS.
- ALL MATERIALS & INSTALLATION OF PLUMBING SYSTEMS SHALL COMPLY W/ STATE & LOCAL BUILDING CODE REQUIREMENTS.
- WATER HEATER SHALL BE 50 GAL. ELECTRIC W/ 4.5 KW
 INPUT. INSTALL CODE APPROVED, SELF CLOSING TEMPERATURE
 AND PRESSURE RELIEF VALVE AND DISCHARGE INDIRECTLY INTO
 HUB DRAIN. INSTALL HEAT TRAPS ON CW & HW SUPPLY
 PIPES. INSTALL THERMAL EXPANSION TANK ON CW SUPPLY
 PIPE TO WATER HEATER.
- WATER HEATER SHALL BE ADJUSTED TO DELIVER NO MORE THAN 120° F HW.
 SHOWER VALVES SHALL BE THERMOSTATIC/PRESSUIRE BALANCE
- TYPE MIXING VALVES W/ MAXIMUM WATER TEMPERATURE
 ADJUSTED TO DELIVER NO MORE THAN 110° F HW.

 EACH FIXTURE OR PIECE OF EQUIPMENT SHALL BE INSTALLED
- WITH INDIVIDUAL SHUT-OFF VALVES.

 SHOCK ARRESTORS SHALL BE INSTALLED ON WATER SUPPLY
- PIPING WHERE QUICK CLOSING VALVES ARE CONNECTED TO THE SYSTEM. (DISHWASHER & WASHING MACHINE)
- PROVIDE 1/2" CW SUPPLY PIPE WITH 1/4 TURN BALL VALVE PVC VALVE BOX FOR ICE MAKER.
- PROVIDE 1/2" HW SUPPLY PIPE WITH 1/4 TURN BALL VALVE FOR DISHWASHER. PROVIDE 5/8" DRAIN LINE FROM DISHWASHER TO GARBAGE DISPOSAL.
- INSTALL 1/3 HP GARBAGE DISPOSAL IN SINK COMPARTMENT CLOSEST TO DISHWASHER.
- PROVIDE 1/2" CW/HW SUPPLY PIPES WITH 1/4 TURN VALVES, 2" DRAIN LINE AND PVC BOX FOR WASHING MACHINE.
- NO WATER PIPING TO BE LOCATED IN EXTERIOR WALL. PIPE ROUGH—INS SHALL BE LOCATED IN BASE CABINET BELOW FIXTURE.
- INSTALL CLEANOUTS ON BUILDING SANITARY DRAINS AT MAXIMUM 100' O.C. AND CHANGES GREATER THAN 45'.
- INSTALL FLOOR DRAIN IN WATER HEATER CLOSET.
- PROVIDE TRAP PRIMER VALVE FOR ALL FLOOR DRAINS AND HUB DRAINS.
- REFER TO OVERALL BUILDING PLAN FOR GAS METER, ELECTRIC METER & CONDENSING UNIT LOCATIONS. MAINTAIN 3'-0" CLEARANCE BETWEEN METERS & CONDENSING UNITS.
- PENETRATIONS OF FLOOR-CEILING ASSEMBLIES AND WALL
 ASSEMBLIES REQUIRED TO HAVE A FIRERESISTANCE RATING
 MUST MAINTAIN THE INTEGRITY OF THE FIRERESISTANCE-RATED
 ASSEMBLY AND LIMIT THE SPREAD OF FIRE AND MOKE.
 FIRE/SMOKE STOPPING MATERIAL SHALL BE U.L. APPROVED
 AND SHALL BE RATED FOR THE TYPE OF FIRERESISTANT RATED
- ASSEMBLY AND THE MATERIAL TYPE OF THE PENETRANT.

 PVC DRAIN, WASTE, AND VENT PIPING AND COPPER WATER PIPING PASSING THROUGH A STRUCTURAL MEMBER WITHIN 1 1/2" FROPM THE NEAREST EDGE MUST BE PROTECTED BY A 1/16" STEEL PLATE TO PREVEDNT FASTENER PENETRATION.
- NO PIPING SHALL BE LOCATED DIRECTLY ABOVE ELECTRIC

 PARELS:

 Output

 Description:

 Output

 Description:


Plumbing Notes

- 4" SANITARY SEWER PIPE LOCATED BELOW FLOOR SLAB, SLOPE 1/8" PER FOOT.
- 1 1/2" WATER SUPPLY PIPING LOCATED BELOW FLOOR SLAB.
 INSTALL 48" BELOW GRADE (MIN.).
 1/2" (2) B.) CSST CAS SUPPLY LINE FROM METER SET TO
- 1/2" (2LB.) CSST GAS SUPPLY LINE FROM METER SET TO MANIFOLD. INSTALL IN VENTILATED ATTIC.
- 4. SANITARY BRANCH PIPING TO BE LOCATED BELOW FLOOR SLAB.
- 5. HOT & COLD WATER PIPING TO BE LOCATED BELOW FLOOR SLAB, NO FITTINGS BELOW SLAB.6. GAS PIPING INSTALLED DOWNSTREAM OF METER SHALL NOT
- EXTEND THROUGH ANY RESIDENTIAL UNIT OTHER THAN THE UNIT SERVED BY SUCH PIPING (2009 IFGC, SECTION 404.1).
- 7. DISHWASHER: 1/2" VALVED H.W. W/ FLEX HOSE TO D.W., 5/8" FLEX DRAIN LINE FROM D.W. TO G.D.
- 8. ICE MAKER VALVE BOX: 1/2" VALVED C.W. W/ 3/8" FLEX HOSE TO ICE MAKER.
- 9. FURNACE: 3/4" CSST WARD FLEX GAS SUPPLY PIPE TO FURNACE. INSTALL GAS VALVE AT CONNECTION TO EQUIPMENT.
 10. WATER HEATER: ELECTRIC.
- 11. RANGE: 1/2" CSST WARD FLEX GAS SUPPLY PIPE TO RANGE. INSTALL GAS VALVE AT CONNECTION TO EQUIPMENT.
- 12. FIRE PIT: 1/2" CSST WARD FLEX GAS SUPPLY PIPE TO FIRE PIT. INSTALL BRASS SHUT-OFF VALVE & KEY @ 18" A.F.F.
- 13. 1/2" TYPE "K" FLEX COPPER GAS SUPPLY PIPE. INSTALL IN PVC CONDUIT 12"—18" BELOW GRADE, COORDINATE WITH G.C.
- 14. 3/4" VALVED CW EACH UNIT.

DATE DESCRIPTION

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5-31-23 PERMIT CORRECTIONS

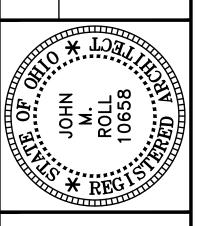

ROLL & ASSOCIATES, INC.
ARCHITECTS & PLANNERS
3176 KETTERING BOULEVARD DAYTON, OHIO 45439
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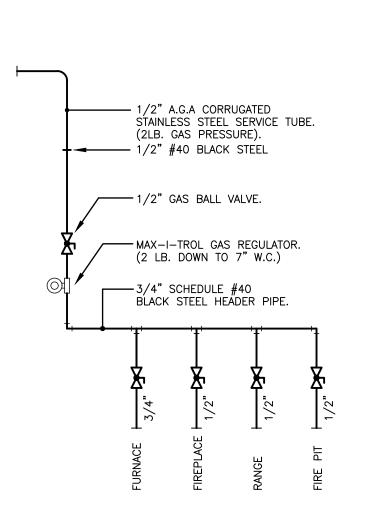
PROJECT NO. **56133**


PROJECT TITLE
BUILDING 1
VILLAS @
WEST MILTON
DWG. TITLE

PLUMBING PLAN - VILLA "B"

DWG. NO.

ITEM	DESCRIPTION	PIPING				ACCESSORIES
		WASTE	VENT	нот	COLD	
WC	WATER CLOSET	3"	1 1/2"		1/2"	SEAT: BEMIS #60
LAV	LAVATORY	1 1/2"	1 1/2"	1/2"	1/2"	
TUB	BATH TUB	1 1/2"	1 1/2"	1/2"	1/2"	LEFT OR RIGHT HAND OUTLET —SEE PLAN
SH	SHOWER	2"	1 1/2"	1/2"	1/2"	MOUNT HEAD @ 92" A.F.F.
SINK	SINK	1 1/2"	1 1/2"	1/2"	1/2"	
G.D.	GARBAGE DISPOSAL	1 1/2"				
ICE	ICE MAKER BOX				1/2"	
WB	WASHER BOX	2"	1 1/2"	1/2"	1/2"	
НВ	FROST FREE HOSE BIBB				3/4"	INSTALL IN EA. GARAGE @ 18" A.F.F.
F.D.	FLOOR DRAIN	3"				FURNISH W/ TRAP PRIMER
C.O.1	CLEAN OUT	4"				NICKALOY ACCESS COVER
C.0.2	CLEAN OUT	4"				STAINLESS STEEL ACCESS COVER
C.0.3	CLEAN OUT	4"				SEE BUILDING PLAN
S.S.	SERVICE SINK	1 1/2"	1 1/2"	1/2"	1/2"	



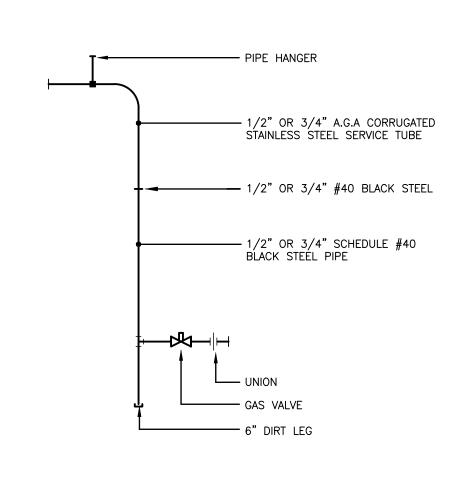

Gas Header Pipe Detail

Gas Pipe Connection Detail


3/4"─

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→ 3/4" CW SUPPLY

"PPP" INDUSTRIES TRAP PRIMER

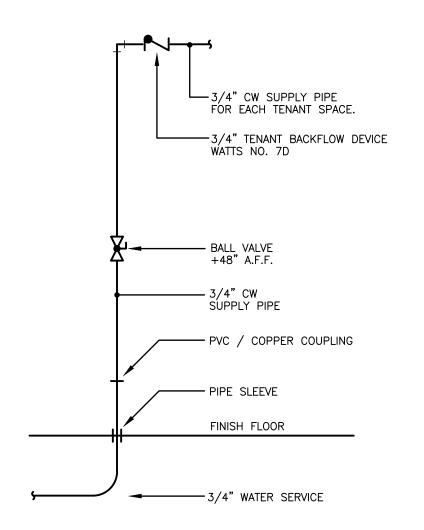−1/2" TO EACH FD-1.





Water Heater Detail

F

 $\langle A \rangle$

 $\langle H \rangle$

General Notes

- 1. REFER TO SCOPE OF WORK LETTER FOR PLUMBING SPECIFICATIONS AND RELATED WORK ITEMS.
- 2. PRESSURE TEST ALL PIPING SYSTEMS:
- A. SANITARY AND VENT PER OHIO PLUMBING CODE. B. BUILDING WATER: 125 PSI WATER FOR 24 HOURS, NO DROP. C. BUILDING GAS: 50 PSI NITROGEN FOR 24 HOURS, NO DROP.
- 3. SANITARY SERVICE PIPE SHALL BE AS REQUIRED BY LOCAL UTILITY.
- 4. WATER SERVICE PIPE SHALL BE AS REQUIRED BY LOCAL UTILITY. 5. GAS SERVICE PIPE SHALL BE AS REQUIRED BY LOCAL UTILITY.
- 6. SANITARY WASTE AND VENT PIPING SHALL BE SCH 40 (PVC) AND AS APPROVED FOR USE BY LOCAL CODE.
- 7. WATER DISTRIBUTION PIPING SHALL BE SCH 40 CPVC PIPING WITH SOLVENT WELD JOINTS. THREADED CONNECTION TO BE BRASS.
- 8. GAS DISTRIBUTION PIPING SHALL BE CODE APPROVED "CSST" PLASTIC COATED FLEXIBLE STAINLESS STEEL TUBING WITH THREADED
- 9. GAS PIPE ROUGH-INS OF EQUIPMENT SHALL BE SCH 40 BLACK STEEL PIPING WITH THREADED FITTINGS.
- 10. PROVIDE PIPE HANGERS FOR ALL PIPING SYSTEMS INSTALLED. SUPPORT AT INTERVALS NOT TO EXCEED 4'-0". SUPPORT ALL PIPING AT FITTINGS, VALVES, AND UNIONS. LOCATE ALL SUPPORTS TO ALLOW FOR PROPER PITCH AND EXPANSION OF PIPES.
- 11. PITCH 3" AND SMALLER SANITARY PIPE 1/4" PER FOOT. PITCH 4" AND LARGER SANITARY PIPE 1/8" PER FOOT. PITCH VENT PIPING FOR DRAINAGE.
- 12. PROVIDE BLOCKING FOR ALL PLUMBING ROUGH-IN.
- 13. ALL PIPING FOR PLUMBING FIXTURE ROUGH—INS TO BE LOCATED IN WALL (U.N.O.).
- 14. CHROME ESCUTCHEON PLATE SHALL BE PROVIDED WHERE PIPE ROUGH-IN PENETRATES WALL.
- 15. PROVIDE CHROME PLATED BRASS SHUT-OFF VALVE WITH CHROME SUPPLY PIPE AT EACH WATER CLOSET, LAVATORY, AND SINK.
- 16. BATHTUB AND SHOWER VALVES SHALL BE EQUIPPED WITH INTEGRAL SHUT-OFF VALVES.
- 17. PROVIDE BRASS SHUT-OFF VALVES AT WATER HEATER, DISHWASHER, ICE MAKER WATER BOX, AND WASHER BOX.

Plumbing Legend

—— w ——	WATER SERVICE PIPING
CW	COLD WATER SUPPLY PIPING
—— нw ——	HOT WATER SUPPLY PIPING
—— SAN ——	SANITARY PIPING
	VENT PIPING
—— G——	LOW PRESSURE GAS PIPING
<u> </u>	GATE VALVE (LINE SIZE)
	BALL VALVE (LINE SIZE)
	CHECK VALVE (LINE SIZE)
	LUBRICATED PLUG VALVE (LINE SIZE)
	THERMOMETER
	FLOOR DRAIN
○ co	CLEAN OUT
— CO	CLEAN OUT PLUG
	OUTSIDE CLEANOUT
#	HOSE BIBB (INSTALL 18" A.F.G.)
	UNION
<u> </u>	SHOCK ARRESTOR
A.A.V.	AUTOMATIC AIR VENT

Detail Notes

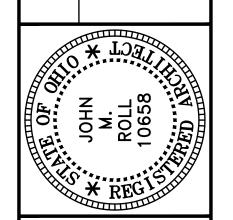
A. GAS WATER HEATER: A.O. SMITH #ENT-50, 50 GALLON STORAGE, 21 GPH @ 90F RISE, 4.5 KW INPUT.

VENT THRU ROOF

- B. EXPANSION TANK.
- C. BALL VALVE.
- D. DRAIN VALVE. E. TEMPERATURE AND PRESSURE RELIEF VALVE.
- F. 3/4" DRAIN PIPE, EXTEND TO HUB DRAIN.
- G. UNION.
- H. PROVIDE 24"x24"x2" GALVANIZED SHEET METAL DRIP PAN BELOW WATER HEATER, EXTEND 3/4" DRAIN LINE TO FLOOR


3-15-23 BUILDING PERMIT 5-31-23 PERMIT CORRECTIONS

DESCRIPTION



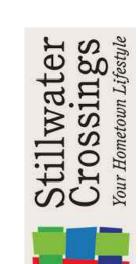LANNERS
YTON, OHIO 45439
FAX (937) 299-3254






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BUILDING 1 VILLAS @ WEST MILTON

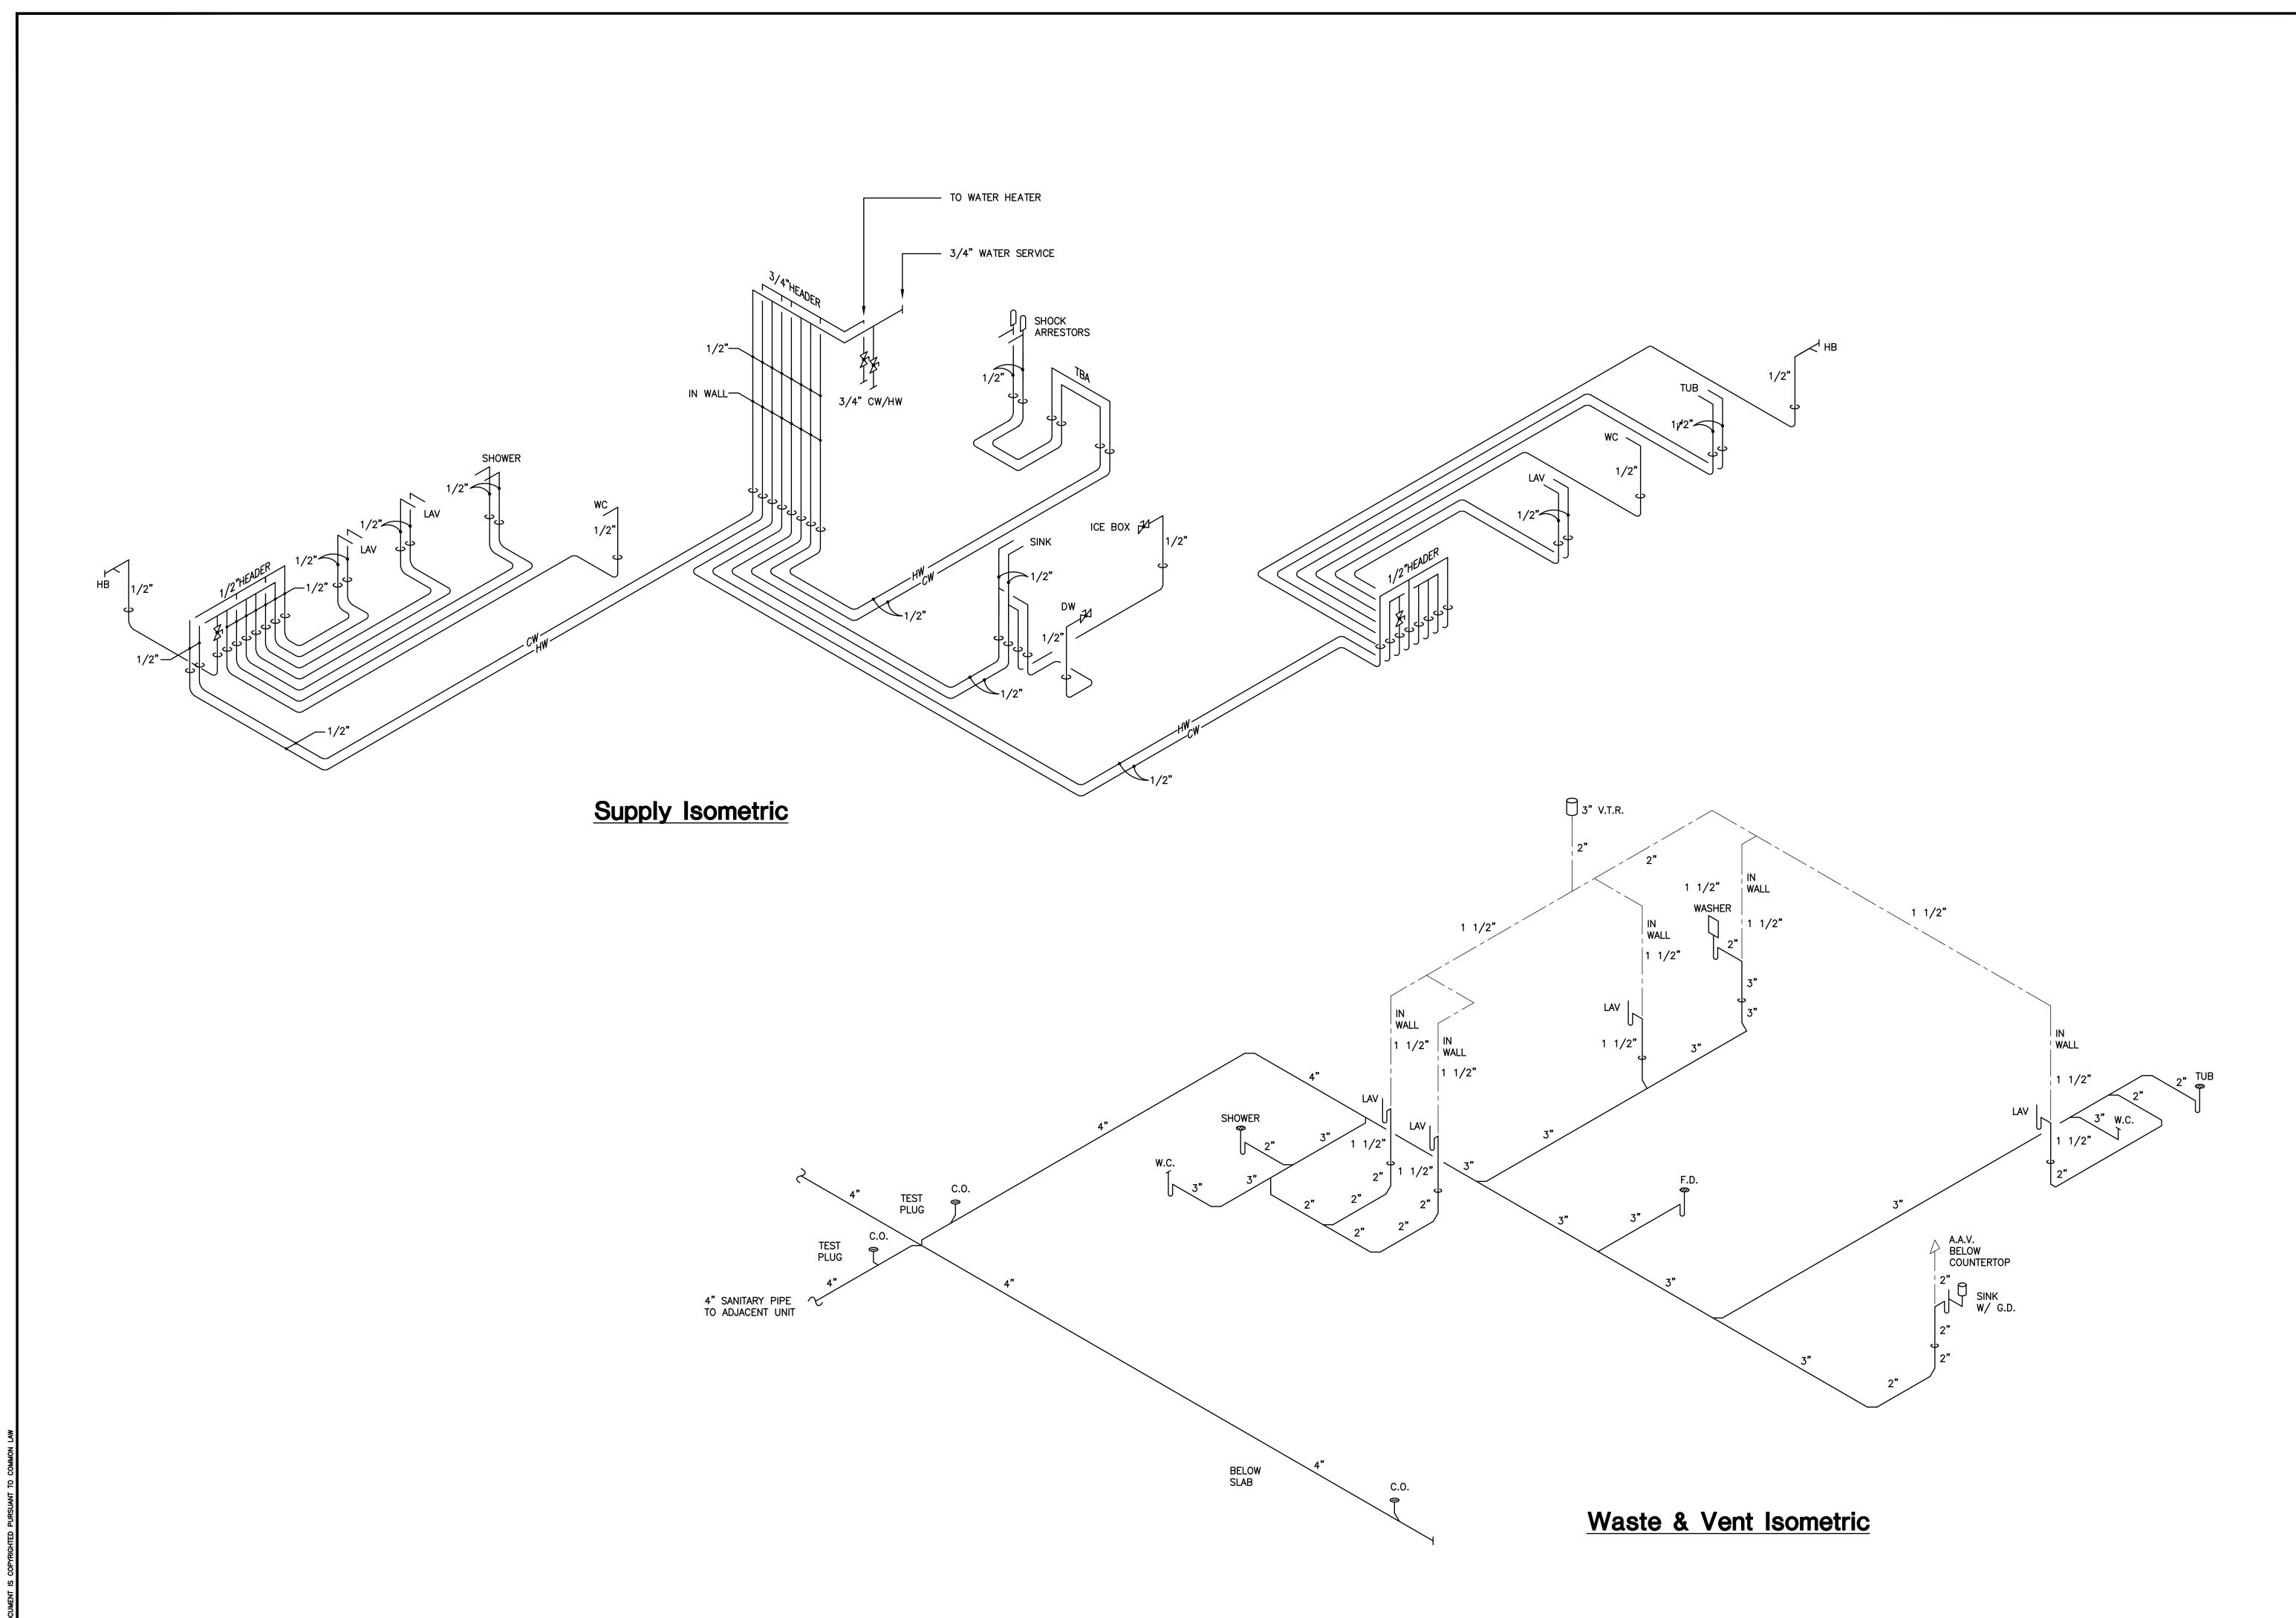
> PLUMBING **DETAILS**




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DWG. TITLE
PLUMBING
ISOMETRICS
- VILLA "B"
DWG. NO.

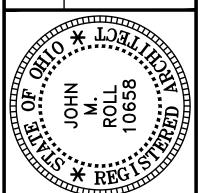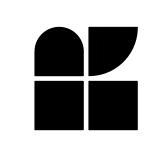P-3