

- ALL HEADERS ARE (2) 2x6 w/ 2x4 WALLS OR (3) 2x6 w/ 2x6 WALLS, INLESS OTHERWISE MOTED.

 2x6 WALLS, INLESS OTHERWISE MOTED.

 3x1 LEXTERS TO HAVE (1) 2x4 OR 2x6 JACK AND KING STUD EACH END, INLESS OTHERWISE MOTED.

 3x1 LEXTERIOR WALLS TO BE 3x w/ 2x6 JACK AND KING STUD EACH END FIREAUS STRUCTURAL SHEATHINS, ALL INTERIOR WALLS TO BE 3 1/2; INLESS OTHERWISE MOTED.

 4x1 HATCHED AREAS INDICATE DROPPED CEILINGS, ALL DROPPED CEILINGS, ALL STUD ET UN LESS OTHERWISE MOTED.

 5x6E** GRACED WALL PANEL DETAIL SHEET** FOR SPECIAL WALL FRANKING LOCATIONS AND HEADER SIZES, IF APPLICABLE.

- ATTLICABLE.

 ALL PIRIDONS HAVE TO I/2" HEADER HEIGHT IMLESS
 OTHERWISE NOTHED.

 ALL HEADERS IN INCH-BEARING WALLS SHALL BE A
 SINGLE FLAT 23/4 OR 23/6 ATTACHED TO CRIPPLES
 ABOVE, IMLESS OTHERWISE NOTED.

 TANKED WATTER HEATER SHOWN AS BASE CONDITION,
 OPTIONAL TANKLESS HATER HEATER IS AVAILABLE IN
 LIEU OF TANKED WATER HEATER.


GYPSUM NOTES

AT GARAGE:

GYPSUM BOARD AT COMMON WALLS, CEILINGS, BEAM WRAPS AND SUPPORTS AS REQUIRED BY LOCAL CODE.

AT STAIRS:


1/2" GYPSUM BOARD AT UNDERSIDE OF STAIRS AND WALLS IN CLOSET

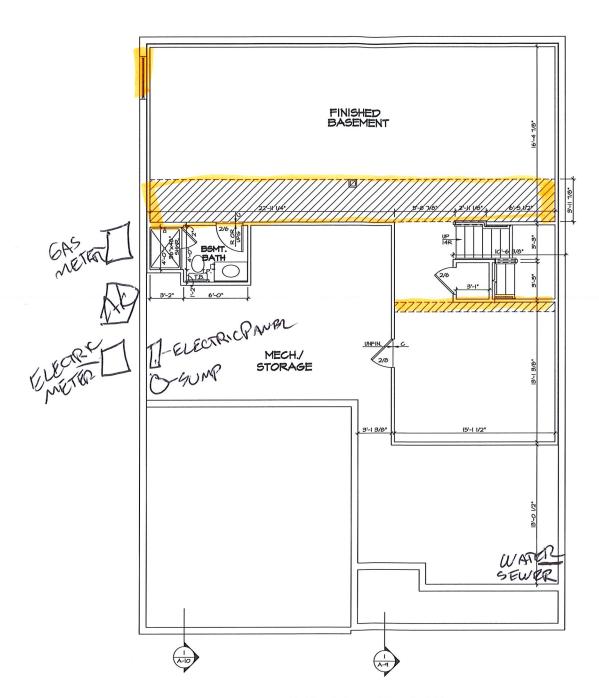


BASEMENT FLOOR PLAN


SCALE: 1/4" = 1'-0"

| REMARKS | | | | | |
|---|-----------------|--|--|--|--|
| REV. NO. DATE | | | | | |
| Will the common supparable inserved in common law copyright and other proposery rights in these plons. These plons or not to be reproduced, changed, or copied in copy form or moner whetsever, or to the copy form or moner whetsever is the copy form or server to the law or to the law or to the law copy form or and the server whether consent of NVR, Inc. | | | | | |
| 03 100 | | | | | |
| SET NO. TRACOO VERSION OI DRAWN BY DATE: OPTION | | | | | |
| HODEL YORK DRAWING TITLE BASEMENT FLOOR PLAN OPTION DESCRIPTION | Treance, MU Z.I | | | | |
| SHEET NO. № ЗТ | | | | | |

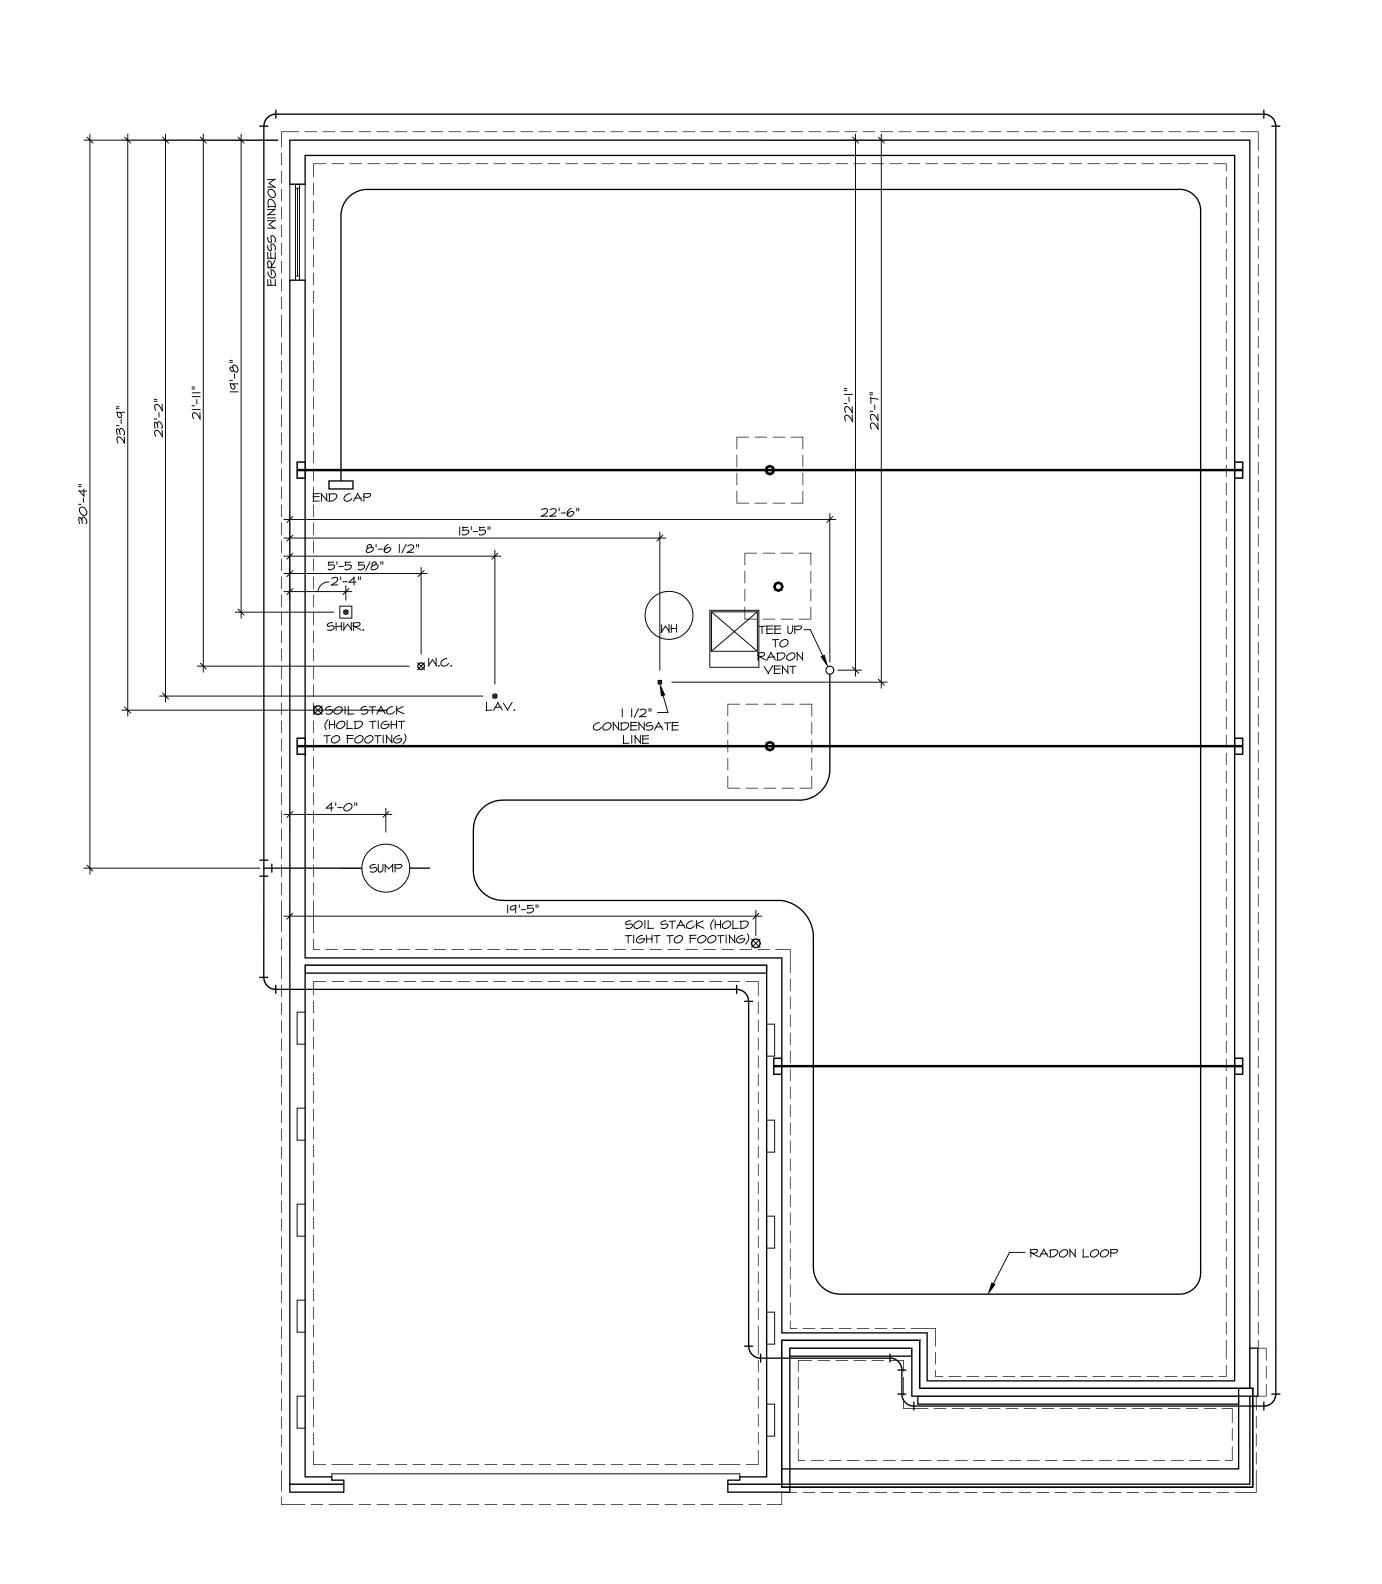



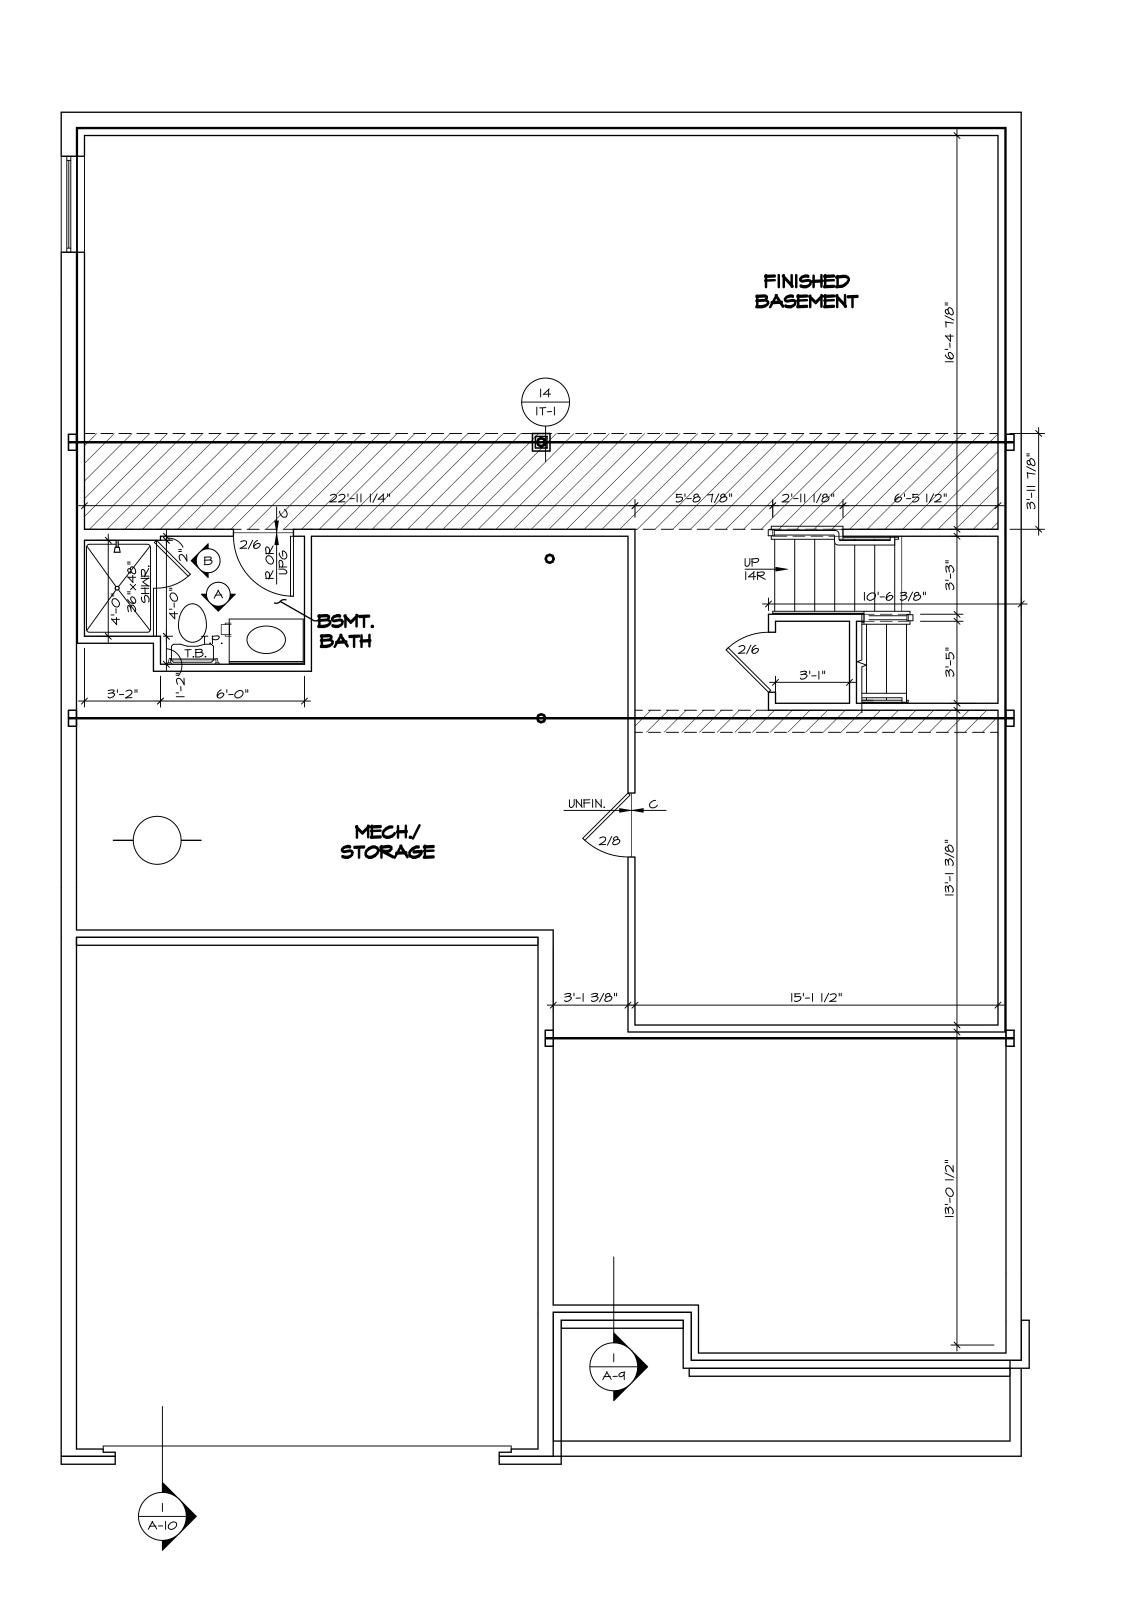

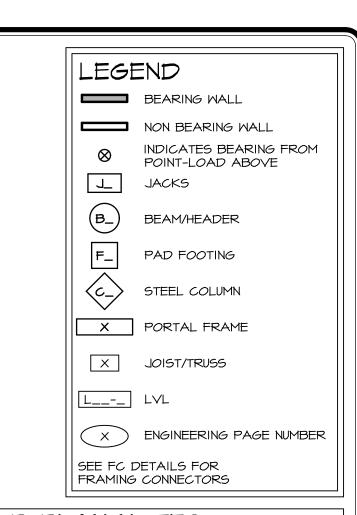

- I. ALL HEADERS ARE (2) 2x6 w/ 2x4 WALLS OR (3) 2x6 w/ 2x6 WALLS, UNLESS OTHERWISE NOTED.
- 2. ALL HEADERS TO HAVE (1) 2x4 OR 2x6 JACK AND KING
- STUD EACH END, UNLESS OTHERWISE NOTED.

 3. ALL EXTERIOR WALLS TO BE 4" W/ OSB OR 3 1/2"
- W/ LAMINATED FIBROUS STRUCTURAL SHEATHING, ALL INTERIOR WALLS TO BE 3 I/2", UNLESS OTHERWISE NOTED.

 4. HATCHED AREAS INDICATE DROPPED CEILINGS. ALL DROPPED CEILINGS ARE I2" UNLESS OTHERWISE NOTED.

 5. SEE "BRACED WALL PANEL DETAIL SHEET" FOR SPECIAL
- WALL FRAMING LOCATIONS AND HEADER SIZES, IF APPLICABLE.

 6. SEE STANDARD DETAIL CATEGORY "IT" SHEET(S) FOR
- INTERIOR TRIM DETAILS.

 7. SEE ARCHITECTURAL DETAIL SHEET "AD" FOR HOUSE
- SPECIFIC INTERIOR TRIM OPTION TABLE.

 8. ALL WINDOWS HAVE 7'-0 1/2" HEADER HEIGHT UNLESS
- OTHERWISE NOTED.

 9. ALL HEADERS IN NON-BEARING WALLS SHALL BE A SINGLE FLAT 2X4 OR 2X6 ATTACHED TO CRIPPLES
- ABOVE, UNLESS OTHERWISE NOTED.

 10. TANKED WATER HEATER SHOWN AS BASE CONDITION,
- OPTIONAL TANKLESS WATER HEATER IS AVAILABLE IN LIEU OF TANKED WATER HEATER.

GYPSUM NOTES

AT GARAGE:

GYPSUM BOARD AT COMMON WALLS, CEILINGS, BEAM WRAPS AND SUPPORTS PER STANDARD DETAIL **FA-I(b)** FIRE ASSEMBLIES OR AS REQUIRED BY LOCAL CODE.

AT STAIRS:

I/2" GYPSUM BOARD AT UNDERSIDE OF STAIRS AND WALLS IN CLOSET REV. NO. DATE

NVR, Inc., owner, expressly reserves its common law copyright and other property rights in these plans. These plans are not to be reproduced, changed, or copied in any form or manner whatsoever, nor are they to be assigned to any third party, without first obtaining the expressed written consent of NVR, Inc.

NVR, Inc.

NN BY

DRAWN BY
DATE:


A Ja N

WING TITLE
ASEMENT FLOOR
TON DESCRIPTION

9 4

BASEMENT FLOOR PLAN

SCALE: 1/4" = 1'-0"

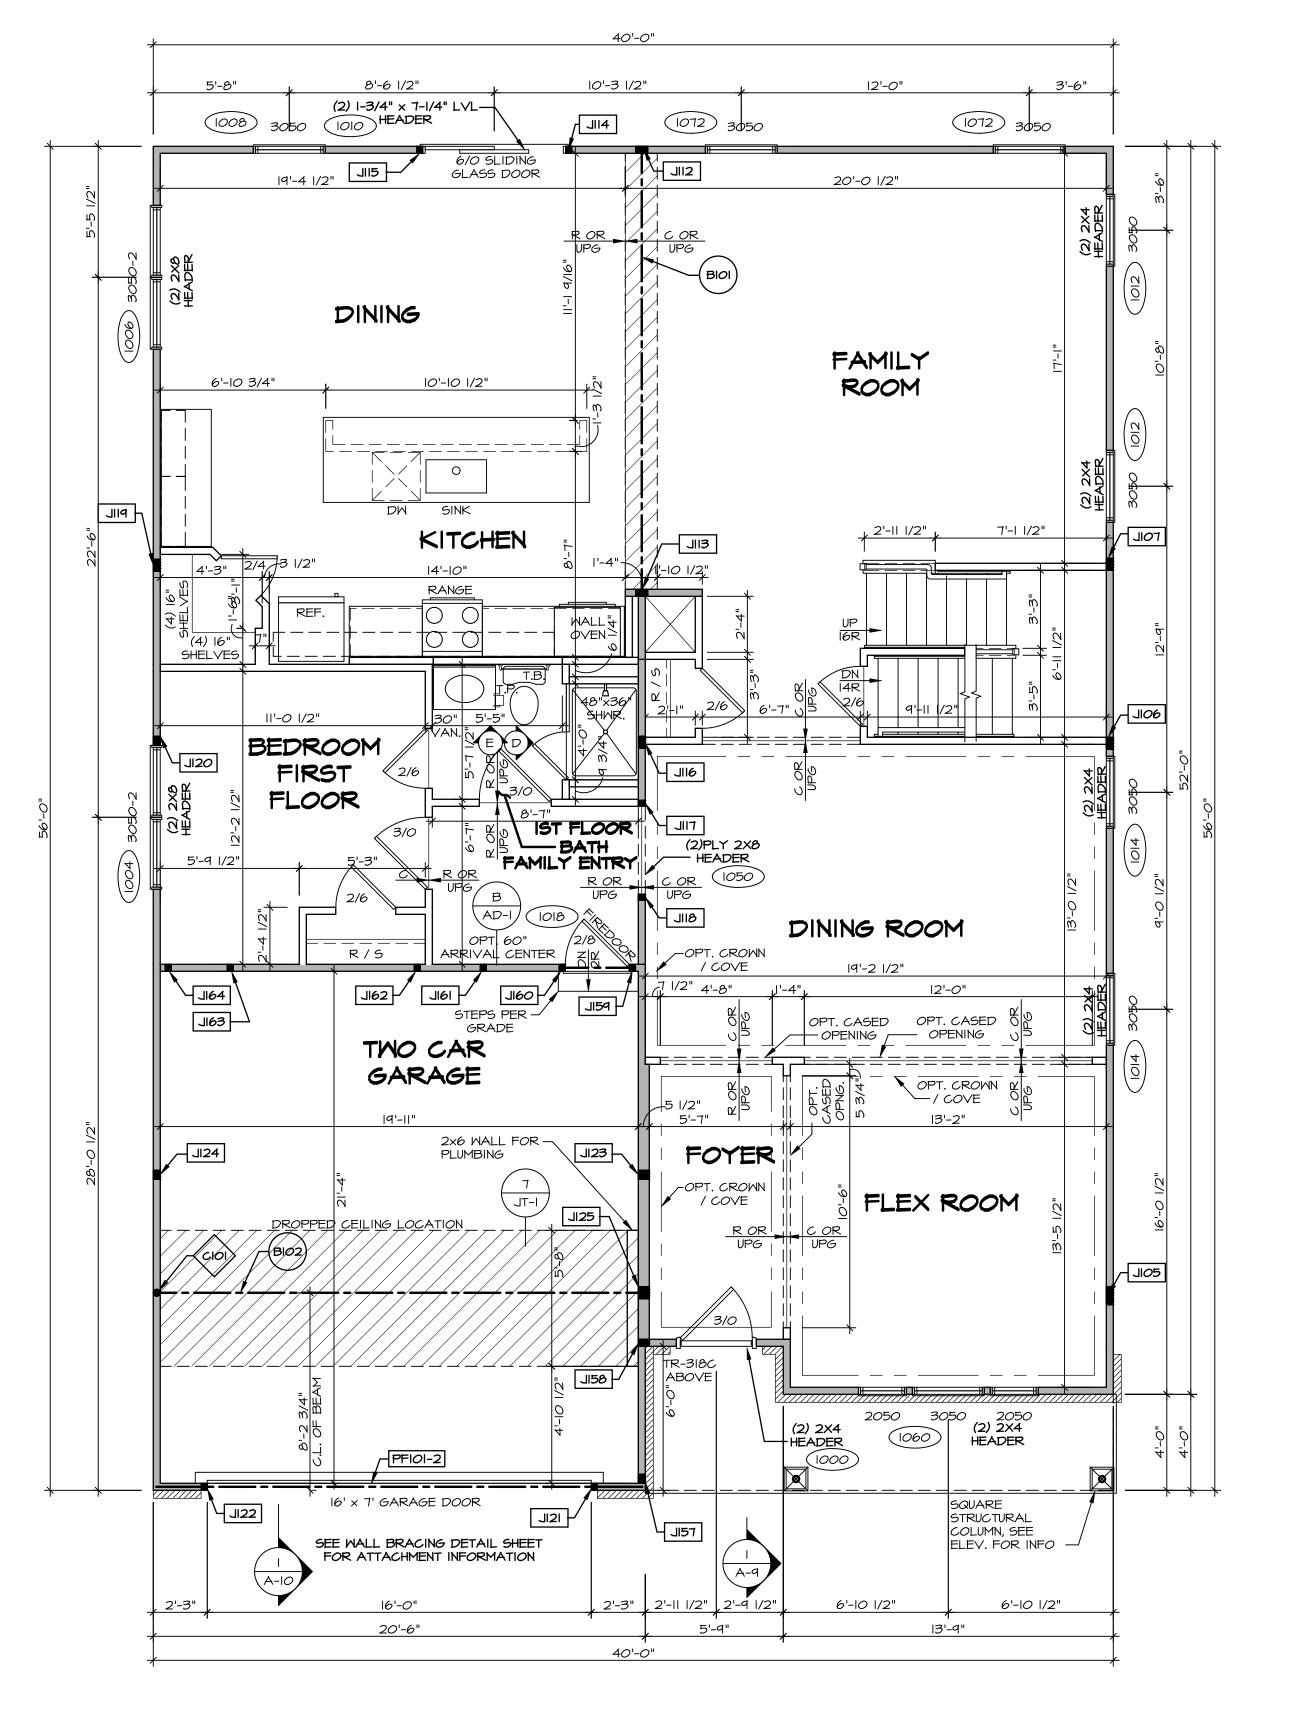



- ALL HEADERS ARE (2) 2x6 W/ 2x4 WALLS OR (3) 2x6 W/ 2x6 WALLS, UNLESS OTHERWISE NOTED.
- ALL HEADERS TO HAVE (1) 2x4 OR 2x6 JACK AND KING STUD EACH END, UNLESS OTHERWISE NOTED. . ALL EXTERIOR WALLS TO BE 4" W/ OSB OR 3 1/2"
- INTERIOR WALLS TO BE 3 1/2", UNLESS OTHERWISE NOTED. HATCHED AREAS INDICATE DROPPED CEILINGS. ALL DROPPED CEILINGS ARE 12" UNLESS OTHERWISE NOTED. SEE "BRACED WALL PANEL DETAIL SHEET" FOR SPECIAL

W/ LAMINATED FIBROUS STRUCTURAL SHEATHING, ALL

- WALL FRAMING LOCATIONS AND HEADER SIZES, IF APPLICABLE.
- SEE STANDARD DETAIL CATEGORY "IT" SHEET(S) FOR INTERIOR TRIM DETAILS. SEE ARCHITECTURAL DETAIL SHEET "AD" FOR HOUSE
- SPECIFIC INTERIOR TRIM OPTION TABLE. ALL WINDOWS HAVE 7'-0 1/2" HEADER HEIGHT UNLESS OTHERWISE NOTED. ALL HEADERS IN NON-BEARING WALLS SHALL BE A SINGLE FLAT 2X4 OR 2X6 ATTACHED TO CRIPPLES
- ABOVE, UNLESS OTHERWISE NOTED. O. TANKED WATER HEATER SHOWN AS BASE CONDITION, OPTIONAL TANKLESS WATER HEATER IS AVAILABLE IN LIEU OF TANKED WATER HEATER.


GYPSUM NOTES

AT GARAGE:

GYPSUM BOARD AT COMMON WALLS, CEILINGS, BEAM WRAPS AND SUPPORTS PER STANDARD DETAIL FA-I(b) FIRE ASSEMBLIES OR AS REQUIRED BY LOCAL CODE.

AT STAIRS:

1/2" GYPSUM BOARD AT UNDERSIDE OF STAIRS AND WALLS

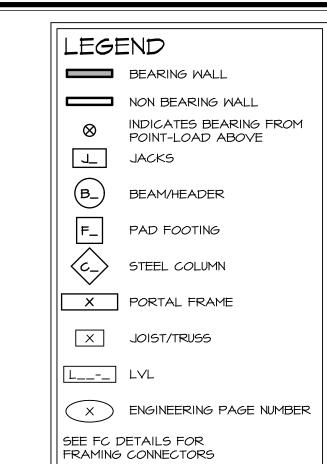


LVL PLY TO PLY FASTENING SCHEDULE: (WHERE APPLICABLE BASED ON LVL USAGE) I.A - (2) PLY UP TO AND INCLUDING II 7/8" TALL: FASTEN PLIES W/ (2) ROWS 16D NAILS AT 12" O.C. OR

- ALT I I/2" WIDE LVL FASTEN PLIES W/ (3) ROWS I2D NAILS AT I2"O.C. 2.A - (2) PLY 14" TO AND 18" TALL (INCLUSIVE): FASTEN PLIES W/ (3) ROWS 16D NAILS AT 12" O.C. OR
- ALT I 1/2" WIDE LVL FASTEN PLIES W/ (4) ROWS 12D NAILS AT 12"O.C. 3.A - (2) PLY 20" TALL AND OVER: FASTEN PLIES W/ (4) ROWS 16D NAILS AT 12" O.C. OR ALT I 1/2" WIDE
- LVL FASTEN PLIES W/ (5) ROWS 12D NAILS AT 12"O.C. 4.A - (3) PLY UP TO AND INCLUDING II 7/8" TALL: FASTEN PLIES W/ (2) ROWS I6D NAILS AT I2" O.C. FROM EACH SIDE OR ALT I I/2" WIDE LVL FASTEN PLIES W/ (3) ROWS I2D NAILS AT I2"O.C. FROM
- 5.A (3) PLY 14" TO AND 18" TALL (INCLUSIVE): FASTEN PLIES W/ (3) ROWS 16D NAILS AT 12" O.C. FROM EACH SIDE OR ALT I 1/2" WIDE LVL FASTEN PLIES W/ (4) ROWS 12D NAILS AT 12"O.C. FROM EACH SIDE. 6.A - (3) PLY 20" TALL AND OVER: FASTEN PLIES W/ (4) ROWS 16D NAILS AT 12" O.C. FROM EACH SIDE
- OR ALT I I/2" WIDE LVL FASTEN PLIES W/ (5) ROWS I2D NAILS AT I2"O.C. FROM EACH SIDE. 7.A - (4) PLY (ALL SIZES); FASTEN PLIES W/ (2) ROMS I/2" DIAMETER A307 BOLTS AT 24" O.C. SEE SHOP DRAWING FOR ADDITIONAL INFORMATION.


| | FIRST FLOOR JACK SCHEDULE | | | | |
|---------------|-------------------------------|---------|-----------|---------|--|
| IDENTIFIER | DESCRIPTION | OPTIONS | ENG. NUM. | REMARKS | |
| JI <i>0</i> 5 | JACK - (6) 2X4 SP#I | | 2008 | | |
| JI06 | JACK - (4) 2X4 SPF STUD GRADE | | 1056 | | |
| TOIL | JACK - (4) 2X4 SPF STUD GRADE | | 1056 | | |
| 211 | JACK - (4) 2X4 SP#I | | 1016 | | |
| SIIL | JACK - (4) 2X4 SP#I | | 1016 | | |
| JII4 | JACK - (2) 2X4 SPF STUD GRADE | | 1010 | | |
| JII5 | JACK - (2) 2X4 SPF STUD GRADE | | 1010 | | |
| اال | JACK - (4) 2X4 SPF STUD GRADE | | 1056 | | |
| TIL | JACK - (2) 2X4 SPF STUD GRADE | | 1050 | | |
| BIIL | JACK - (2) 2X4 SPF STUD GRADE | | 1050 | | |
| PIIL | JACK - (4) 2X4 SPF STUD GRADE | | 1056 | | |
| J120 | JACK - (3) 2X4 SPF STUD GRADE | | 1056 | | |
| J 2 | JACK - (2) 2X4 SPF STUD GRADE | | 1002 | | |
| J122 | JACK - (2) 2X4 SPF STUD GRADE | | 1002 | | |
| J123 | JACK - (3) 2X6 SPF STUD GRADE | | 1083 | | |
| JI24 | JACK - (3) 2X4 SPF STUD GRADE | | 1083 | | |
| JI25 | JACK - (4) 2X6 SP#I | | 1031 | | |
| J157 | JACK - (3) 2X4 SPF STUD GRADE | | 1065 | | |
| J158 | JACK - (2) 2X6 SPF STUD GRADE | | 1020 | | |
| J159 | JACK - (2) 2X4 SPF STUD GRADE | | 1018 | | |
| J160 | JACK - (2) 2X4 SPF STUD GRADE | | 1018 | | |
| J161 | JACK - (2) 2X4 SPF STUD GRADE | | 2010 | | |
| JI62 | JACK - (2) 2X4 SPF STUD GRADE | | 2010 | | |
| J163 | JACK - (2) 2X4 SPF STUD GRADE | | 2010 | | |
| JI64 | JACK - (2) 2X4 SPF STUD GRADE | | 2010 | | |

| FIELD INSTALLED FIRST FLOOR BEAM/HEADER SCHEDULE | | | | | |
|--|---------------------|------------|----------------------|-----------|-----------------|
| IDENTIFIER | DESCRIPTION | LENGTH | OPTIONS | ENG. NUM. | REMARKS |
| BIOI | BEAM STEEL - WIOX26 | 18'-8 1/2" | | 1016 | |
| BI02 | BEAM STEEL - WIOX26 | 20'-7 1/2" | SXC / SXS AND EVA | 1031 | |
| PFIOI-2 | LVL 1.75 - 11-04 | 20'-3" | | 1002 | FIELD INSTALLED |

| STEEL COLUMN SCHEDULE | | | | | |
|-----------------------|------------------------------|-----------|---------|-----------|---------|
| IDENTIFIER | STYLE | HEIGHT | OPTIONS | ENG. NUM. | REMARKS |
| CIOI | STANCHION - 3 IN SCHED 40 | 9'-2 1/4" | FBA | 1031 | |

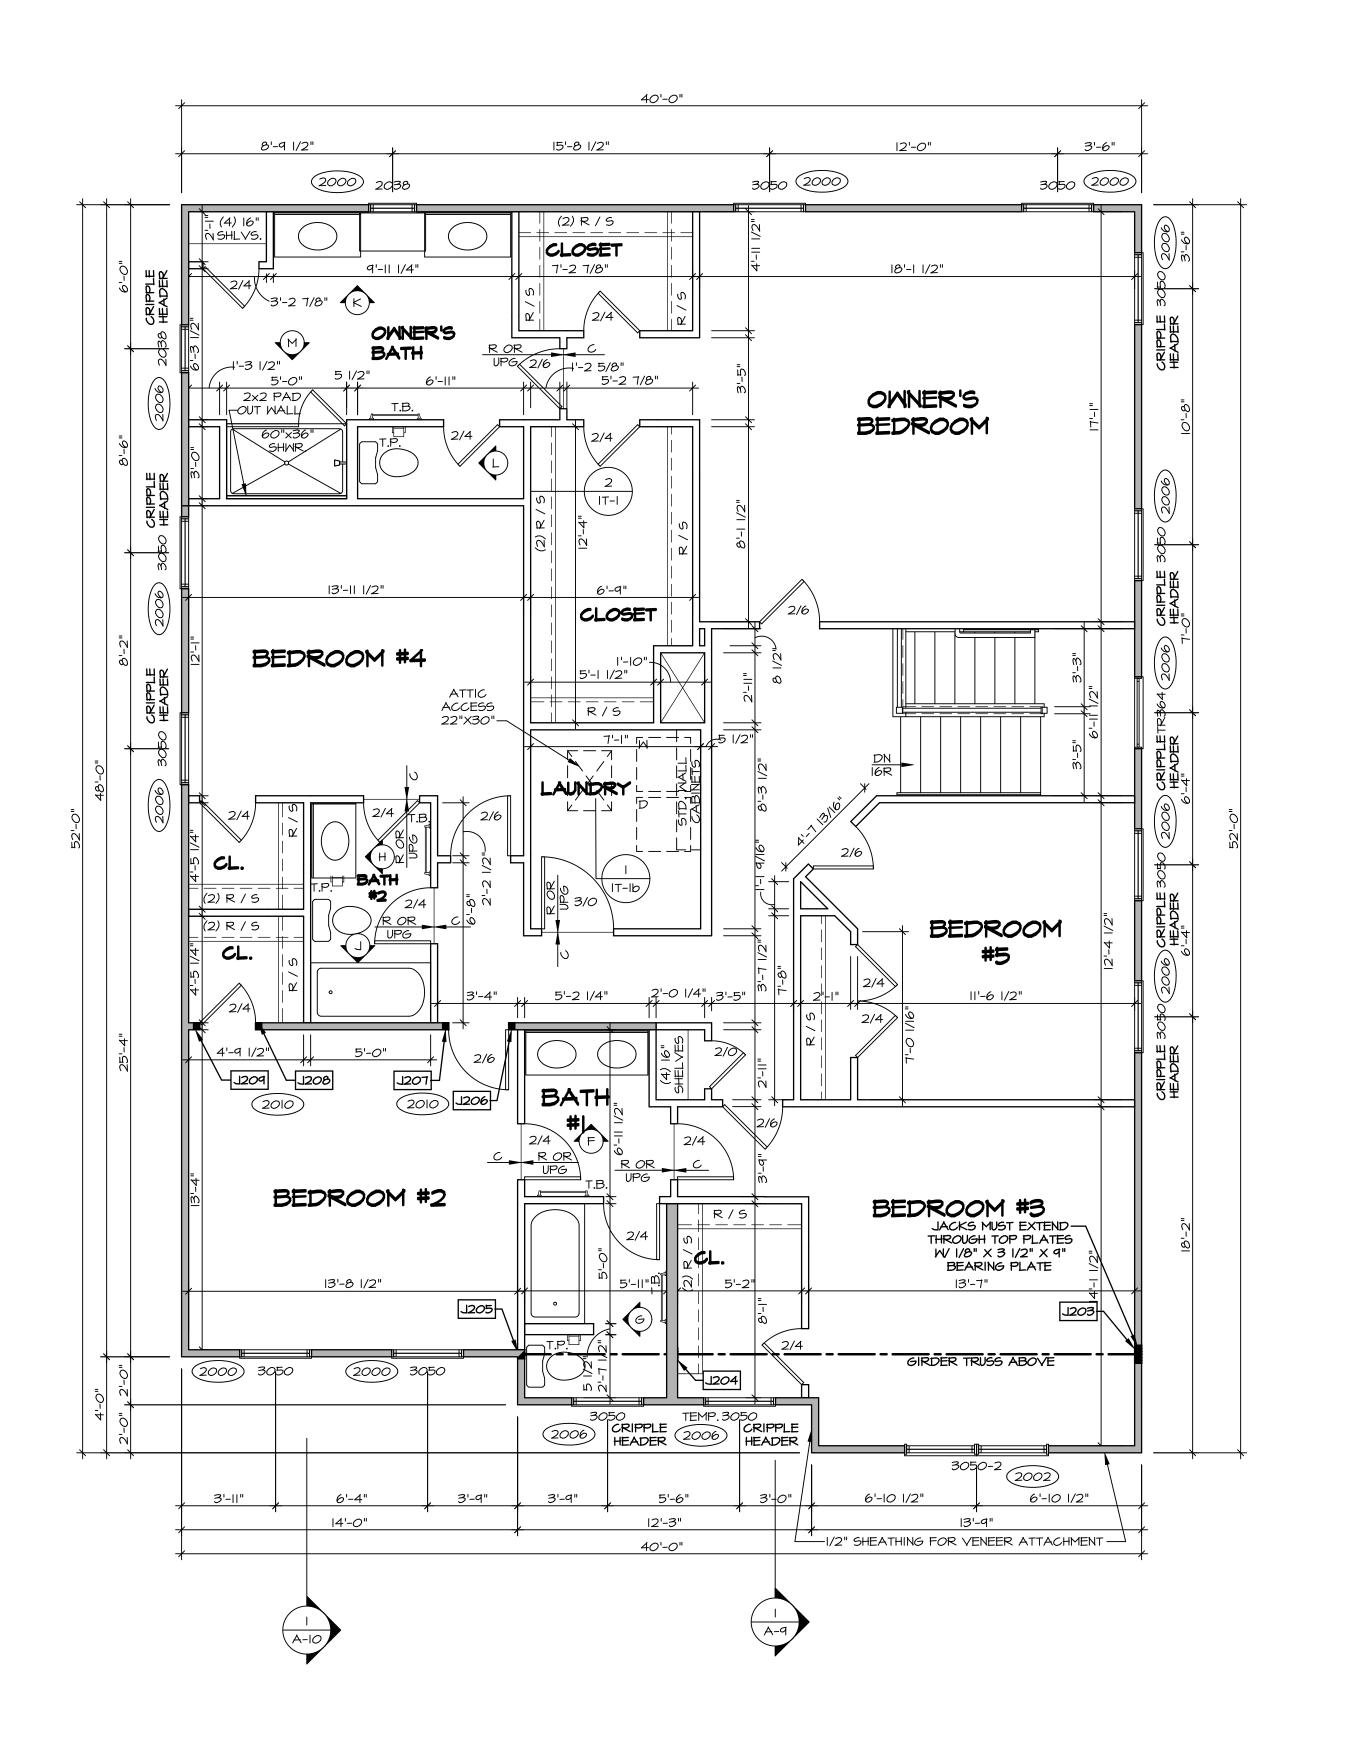



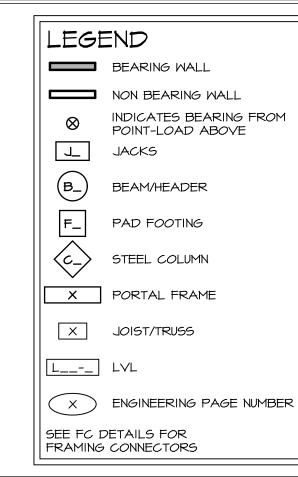

- ALL HEADERS ARE (2) 2x6 W/ 2x4 WALLS OR (3) 2x6 W/ 2x6 WALLS, UNLESS OTHERWISE NOTED.
- ALL HEADERS TO HAVE (I) 2x4 OR 2x6 JACK AND KING STUD EACH END, UNLESS OTHERWISE NOTED.

 3. ALL EXTERIOR WALLS TO BE 4" w/ OSB OR 3 1/2"
- W/ LAMINATED FIBROUS STRUCTURAL SHEATHING, ALL INTERIOR WALLS TO BE 3 1/2", UNLESS OTHERWISE NOTED. . HATCHED AREAS INDICATE DROPPED CEILINGS. ALL DROPPED CEILINGS ARE 12" UNLESS OTHERWISE NOTED.
 SEE "BRACED WALL PANEL DETAIL SHEET" FOR SPECIAL
- WALL FRAMING LOCATIONS AND HEADER SIZES, IF APPLICABLE. . SEE STANDARD DETAIL CATEGORY "IT" SHEET(S) FOR
- INTERIOR TRIM DETAILS.
 SEE ARCHITECTURAL DETAIL SHEET "AD" FOR HOUSE
- SPECIFIC INTERIOR TRIM OPTION TABLE.

 8. ALL WINDOWS HAVE 7'-0 1/2" HEADER HEIGHT UNLESS
- OTHERWISE NOTED. ALL HEADERS IN NON-BEARING WALLS SHALL BE A SINGLE FLAT 2X4 OR 2X6 ATTACHED TO CRIPPLES
- ABOVE, UNLESS OTHERWISE NOTED. . TANKED WATER HEATER SHOWN AS BASE CONDITION, OPTIONAL TANKLESS WATER HEATER IS AVAILABLE IN LIEU OF TANKED WATER HEATER.

GYPSUM NOTES


AT GARAGE:

GYPSUM BOARD AT COMMON WALLS, CEILINGS, BEAM WRAPS AND SUPPORTS PER STANDARD DETAIL FA-I(b) FIRE ASSEMBLIES OR AS REQUIRED BY LOCAL CODE.


AT STAIRS:

1/2" GYPSUM BOARD AT UNDERSIDE OF STAIRS AND WALLS IN CLOSET


| SECOND FLOOR JACK SCHEDULE | | | | | | |
|----------------------------|-------------------------------|---------|-----------|---------|--|--|
| IDENTIFIER | DESCRIPTION | OPTIONS | ENG. NUM. | REMARKS | | |
| J203 | JACK - (6) 2X4 SP#I | | 2008 | | | |
| J204 | JACK - (4) 2X6 SPF STUD GRADE | | 2008 | | | |
| J205 | JACK - (3) 2X4 SPF STUD GRADE | | 2008 | | | |
| J206 | JACK - (2) 2X4 SPF STUD GRADE | | 2010 | | | |
| J207 | JACK - (2) 2X4 SPF STUD GRADE | | 2010 | | | |
| J208 | JACK - (2) 2X4 SPF STUD GRADE | | 2010 | | | |
| J209 | JACK - (2) 2X4 SPF STUD GRADE | | 2010 | | | |

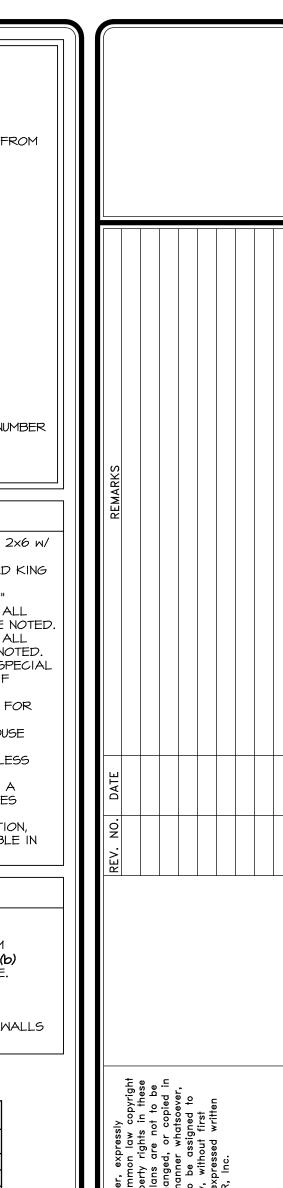



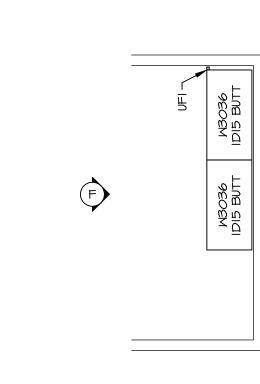

LAUNDRY CABINET PLAN KC-3497

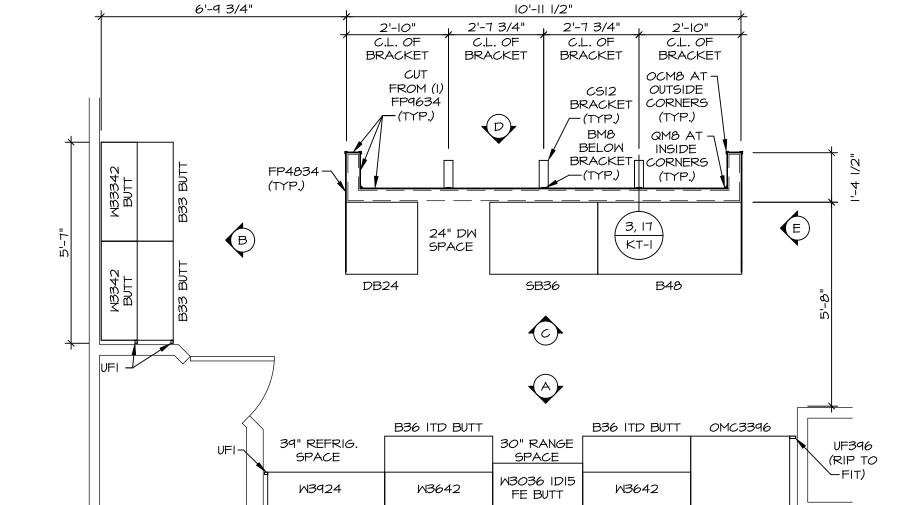



KITCHEN CABINET PLAN KC-3496

UPGRADE KITCHEN LAYOUT "KAG"

KITCHEN ELEVATION

SCALE: 3/8" = 1'-0"

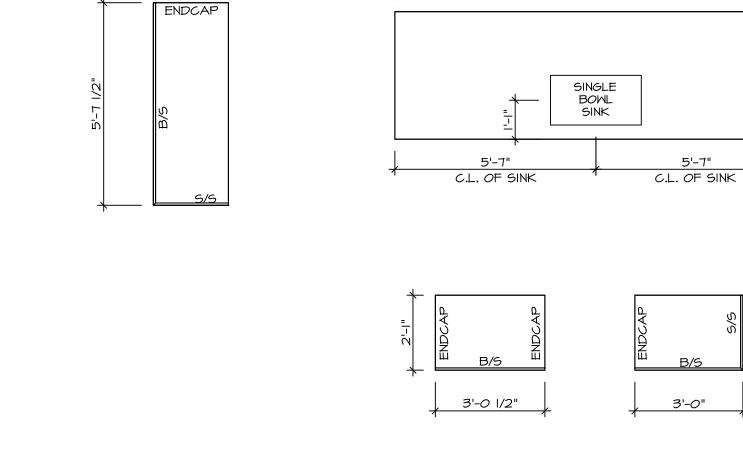


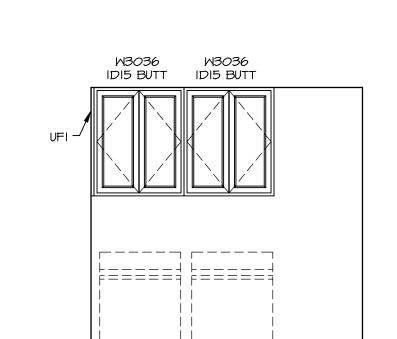



SCALE: 3/8" = 1'-0" A-12


KITCHEN COUNTERTOP PLAN - KC 3496 2 SCALE: 3/8" = 1'-0" A-12 UPGRADE KITCHEN LAYOUT "KAG"

LAUNDRY ELEVATION

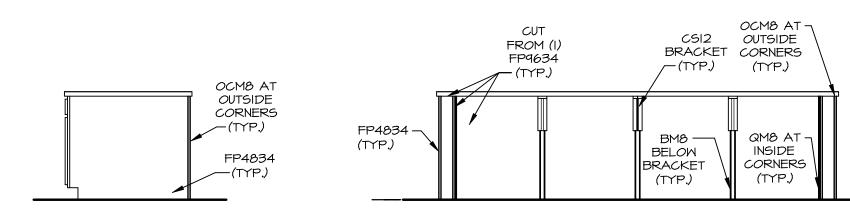

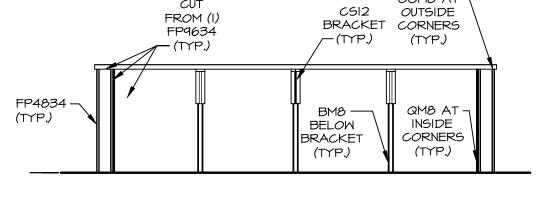


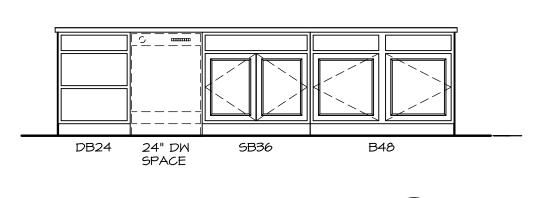

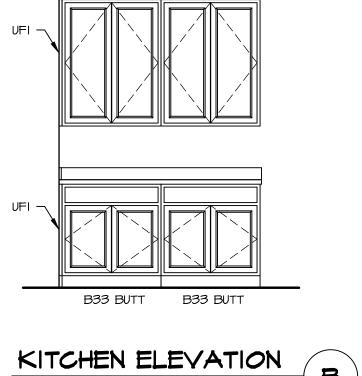

M3342 BUTT

M3342 BUTT

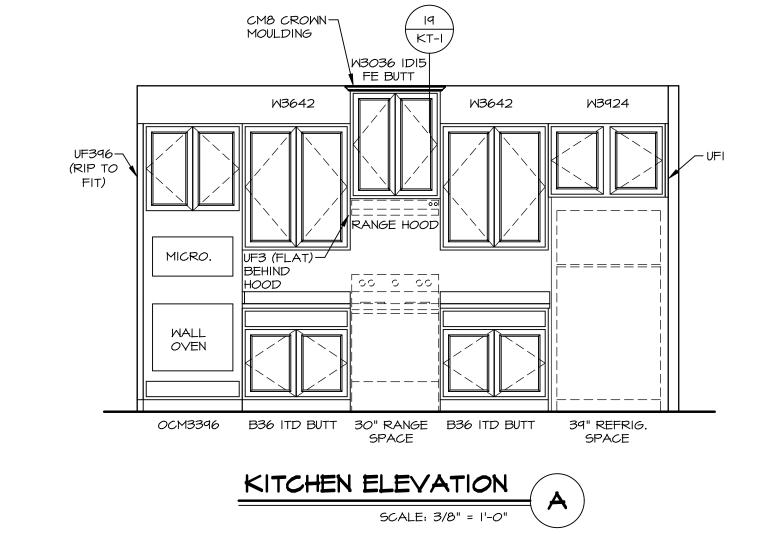


KITCHEN ELEVATION SCALE: 3/8" = 1'-0"


SCALE: 3/8" = 1'-0" A-12








NOTE: CABINET LAYOUT(S) ARE BASED ON FINISHED DIMENSION TO DRYWALL. NOTE:
KITCHEN ELEVATIONS/PLANS CALL
OUT STANDARD MOLDING, REFER TO
DETAIL II/KT-I FOR REPLACEMENT
BASED ON CABINET STYLE.

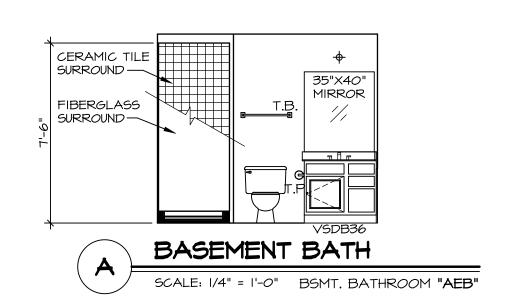


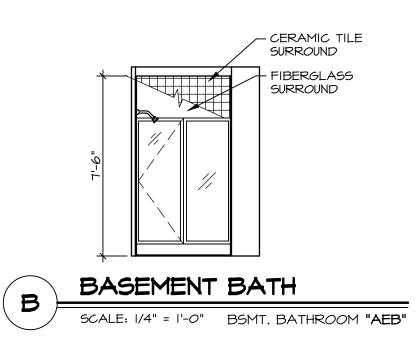


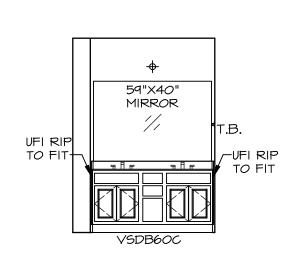


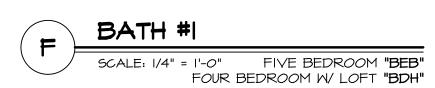


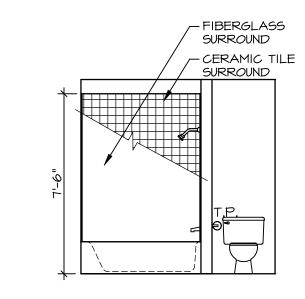


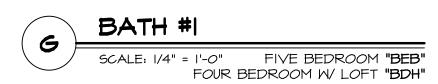

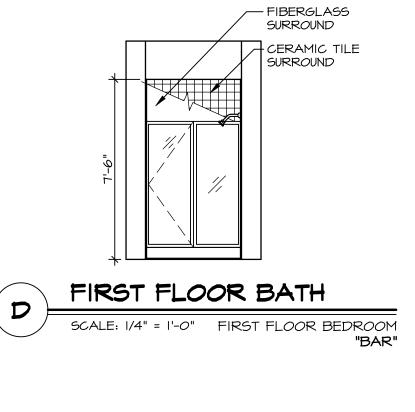

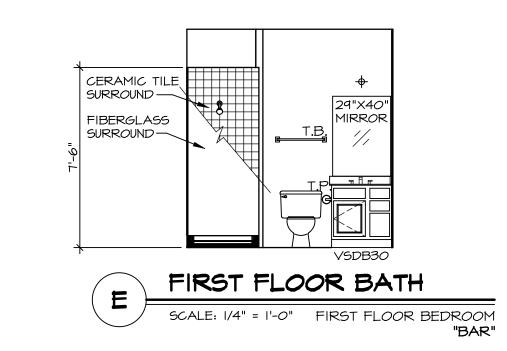

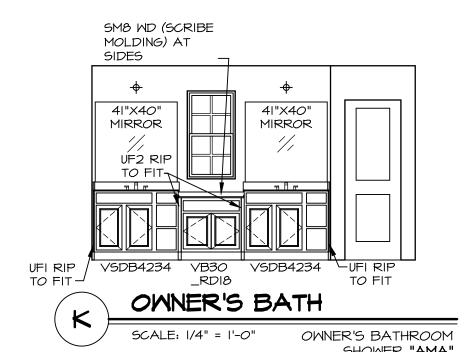

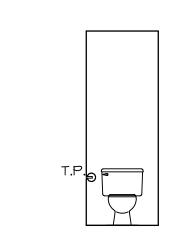



NOTES:

- I. TEMPERED GLASS SHOWER ENCLOSURE WITH SWING DOOR OR
- PICLOSURE WITH SMING DOOR OR
 OPTIONAL SLIDING DOOR BY DIVISION

 TUB ACCESS PANELS PROVIDED AS
 NEEDED, ALL MATERIALS BY DIVISION

 REFER TO SHEET D-XX FOR TUB AND
 SHOWER DETAILS.

 ALL VSDB24-42 DRAWERS TO BE SET ON
 RIGHT HAND

- RIGHT HAND.

 5. ALL BATH ELEVATIONS ARE SHOWN PER PLAN.

