




	REMARKS				
	REV. NO. DATE				
	REV. NO				
	NVR, Inc., owner, expressly reserves its common law copyright	plans. These plans are not to be reproduced, changed, or copied in	any form of manner whatsoever, nor are they to be assigned to any third party, without first	NVR, Inc. Architectural Services	Architects
				Archite	
	SET NO. FLROO	DRAWN BY	DATE:	OPTION	
	NCIE			IPTION	

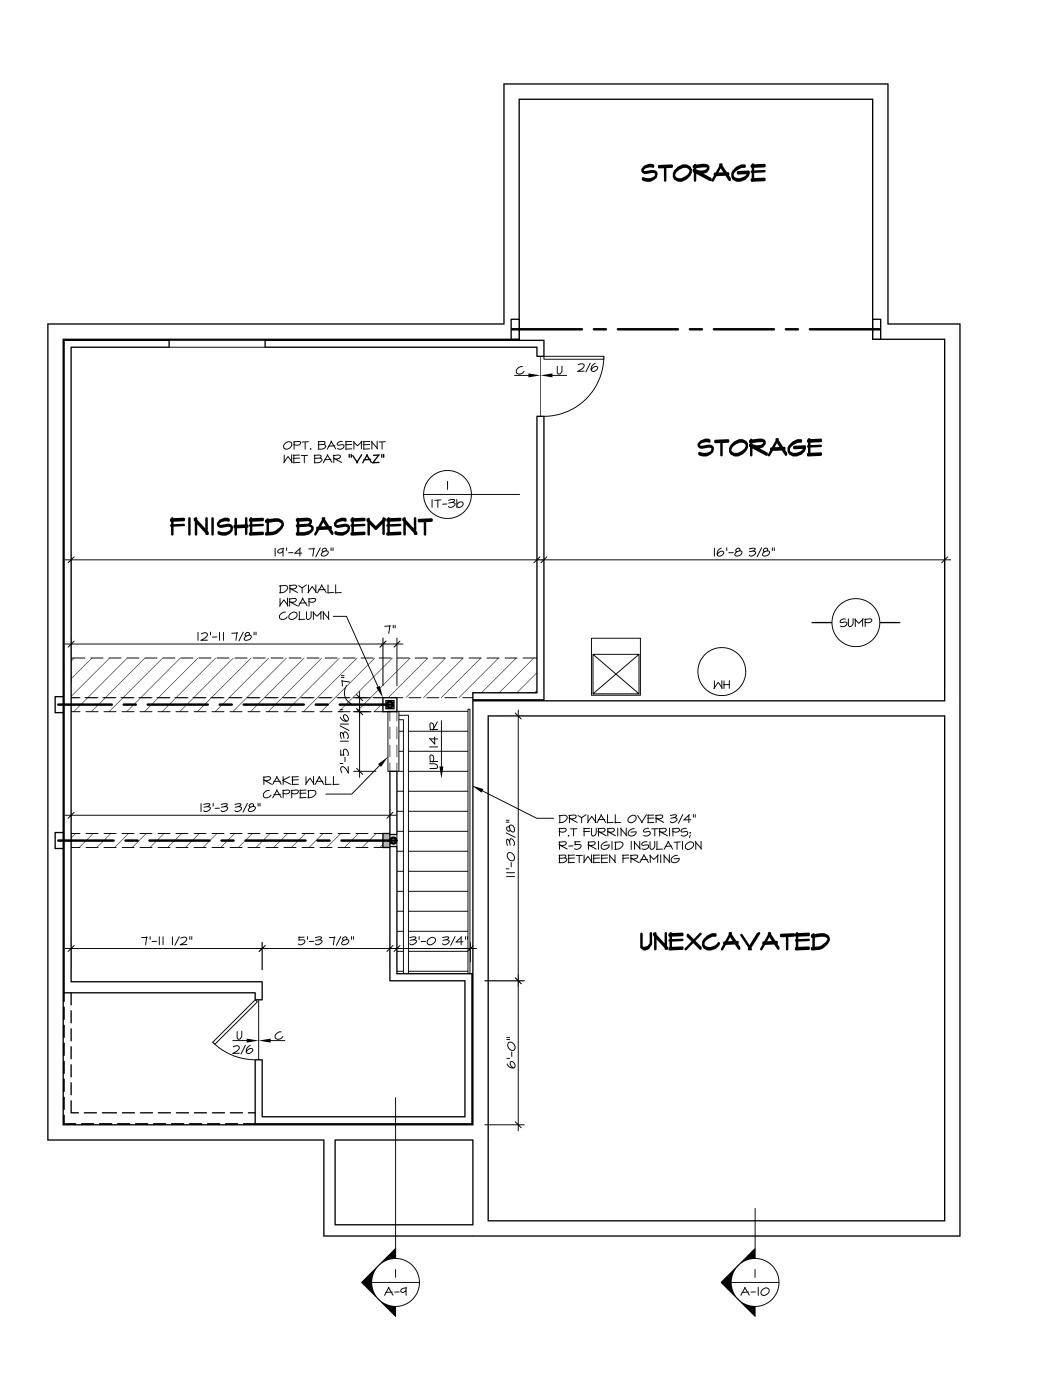

BASEMENT FLOOR PLAN

A-6 SCALE: 1/4" = 1'-0"

FLOOR PLAN NOTES

- ALL HEADERS ARE (2) 2x6 w/ 2x4 WALLS OR (3) 2x6 w/ 2x6 WALLS, UNLESS OTHERWISE NOTED.
- . ALL HEADERS TO HAVE (1) 2x4 OR 2x6 JACK EACH END, UNLESS OTHERWISE NOTED. . ALL EXTERIOR WALLS TO BE 4" AND ALL INTERIOR WALLS TO BE 3 1/2", UNLESS OTHERWISE NOTED
 . HATCHED AREAS INDICATE DROPPED CEILINGS. ALL
- DROPPED CEILINGS ARE 12" UNLESS OTHERWISE NOTED.

 SEE "BRACED WALL PANEL DETAIL SHEET" FOR SPECIAL WALL FRAMING LOCATIONS AND HEADER SIZES, IF APPLICABLE.
- . SEE STANDARD DETAIL CATEGORY "IT" SHEET(S) FOR INTERIOR TRIM DETAILS. SEE ARCHITECTURAL DETAIL SHEET "AD" FOR HOUSE
- SPECIFIC INTERIOR TRIM OPTION TABLE. . ALL MINDOMS HAVE 7'-0 1/2" HEADER HEIGHT UNLESS OTHERWISE NOTED.

GYPSUM NOTES

AT GARAGE:

GYPSUM BOARD AT COMMON WALLS, CEILINGS, BEAM WRAPS AND SUPPORTS PER STANDARD DETAIL FA-I(b) FIRE ASSEMBLIES OR AS REQUIRED BY LOCAL CODE.

AT STAIRS:

1/2" GYPSUM BOARD AT UNDERSIDE OF STAIRS AND WALLS IN CLOSET

LEGEND

BEARING WALL

NON BEARING WALL

INDICATES BEARING FROM POINT-LOAD ABOVE JACKS

(B_ BEAM/HEADER

STEEL COLUMN

X PORTAL FRAME

PAD FOOTING

X JOIST/TRUSS L__-_ LVL

X ENGINEERING PAGE NUMBER

SEE FC DETAILS FOR FRAMING CONNECTORS

	FIRST FLOOR JACK SCHEDULE					
IDENTIFIER	DESCRIPTION	OPTIONS	ENG. NUM.	FIELD INSTALLED		
JOI	JACK - (2) 2X4 SPF STUD GRADE		Ш			
J02	JACK - (3) 2X4 SPF STUD GRADE		Ш			
J03	JACK - (2) 2X4 SPF STUD GRADE		II3			
J04	JACK - (3) 2X4 SPF STUD GRADE		II3			
J05	JACK - (2) 2X4 SPF STUD GRADE		107			
J06	JACK - (2) 2X4 SPF STUD GRADE		107			
JI6	JACK - (6) 2X4 SP#I		101			
TIL	JACK - (5) 2X4 SP#I		101			
J27	JACK - (4) 2X4 SPF STUD GRADE	MAA	125			
J28	JACK - (4) 2X4 SPF STUD GRADE	MAA	125			
J44	JACK - (4) 2X4 SPF STUD GRADE	MAA,KDA	124			
J46	JACK - (5) 2X4 SPF STUD GRADE	MAA	124			

LVL PLY TO PLY FASTENING SCHEDULE:

- I.A (2) PLY UP TO AND INCLUDING II 7/8" TALL: FASTEN PLIES W/ (2) ROWS I6D NAILS AT I2" O.C. 2.A - (2) PLY 14" TO AND 18" TALL (INCLUSIVE): FASTEN PLIES W/ (3) ROWS 16D NAILS AT 12" O.C.
- 3.A (2) PLY 20" TALL AND OVER: FASTEN PLIES W/ (4) ROWS 16D NAILS AT 12" O.C. 4.A - (3) PLY UP TO AND INCLUDING II 7/8" TALL: FASTEN PLIES W/ (2) ROWS 16D NAILS AT 12" O.C.
- FROM EACH SIDE 5.A - (3) PLY 14" TO AND 18" TALL (INCLUSIVE): FASTEN PLIES W (3) ROWS 16D NAILS AT 12" O.C.
- 6.A (3) PLY 20" TALL AND OVER: FASTEN PLIES W/ (4) ROWS 16D NAILS AT 12" O.C. FROM EACH SIDE

FIRST FLOOR BEAM/HEADER SCHEDULE					
IDENTIFIER	DESCRIPTION	LENGTH	OPTIONS	ENG. NUM.	REMARKS
BOI	INT HEADER - 2XI2 - 2 PLY	9'-2 1/2"		III	
B02	INT HEADER - 2X8 - 2 PLY	5'-9"		113	·
B04	BEAM STEEL - WI2X26	20'-2"	SRI, SXS,6CB	101	
B04-2	LVL - 18	15'-5 1/2"	MAA, KDA	124	2 PLY, 2.A
PF02-2	LVL - II-04	19'-11 1/2"	GCB	107	PORTAL FRAME, 2 PLY, I.A

STEEL COLUMN SCHEDULE					
IDENTIFIER	STYLE	HEIGHT	OPTIONS	ENG. NUM.	REMARKS

GYPSUM NOTES

AT GARAGE:

GYPSUM BOARD AT COMMON WALLS, CEILINGS, BEAM WRAPS AND SUPPORTS PER STANDARD DETAIL FA-1(b) FIRE ASSEMBLIES OR AS REQUIRED BY LOCAL CODE.

AT STAIRS:

1/2" GYPSUM BOARD AT UNDERSIDE OF STAIRS AND WALLS IN CLOSET

FLOOR PLAN NOTES RYAN


ALL HEADERS ARE (2) 2x6 w/ 2x4 WALLS OR (3) 2x6 w/ 2x6 WALLS, UNLESS OTHERWISE NOTED. ALL HEADERS TO HAVE (1) 2x4 OR 2x6 JACK AND KING STUD EACH END, UNLESS OTHERWISE NOTED.

ALL EXTERIOR WALLS TO BE 4" W/ OSB OR 3 1/2" W/ T-PLY, ALL INTERIOR WALLS TO BE 3 I/2", UNLESS OTHERWISE NOTED. HATCHED AREAS INDICATE DROPPED CEILINGS. ALL

DROPPED CEILINGS ARE 12" UNLESS OTHERWISE NOTED. SEE "BRACED WALL PANEL DETAIL SHEET" FOR SPECIAL WALL FRAMING LOCATIONS AND HEADER SIZES, IF APPLICABLE.

SEE STANDARD DETAIL CATEGORY "IT" SHEET(S) FOR INTERIOR TRIM DETAILS. SEE ARCHITECTURAL DETAIL SHEET "AD" FOR HOUSE (SPECIFIC INTERIOR TRIM OPTION TABLE. ALL WINDOWS HAVE 7'-0 1/2" HEADER HEIGHT UNLESS


OTHERWISE NOTED. ALL HEADERS IN NON-BEARING WALLS SHALL BE A SINGLE FLAT 2X4 OR 2X6 ATTACHED TO CRIPPLES ABOVE, UNLESS OTHERWISE NOTED.

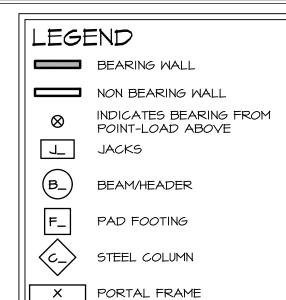

RYAN

X JOIST/TRUSS L__-_ LVL X ENGINEERING PAGE NUMBER


SEE FC DETAILS FOR FRAMING CONNECTORS

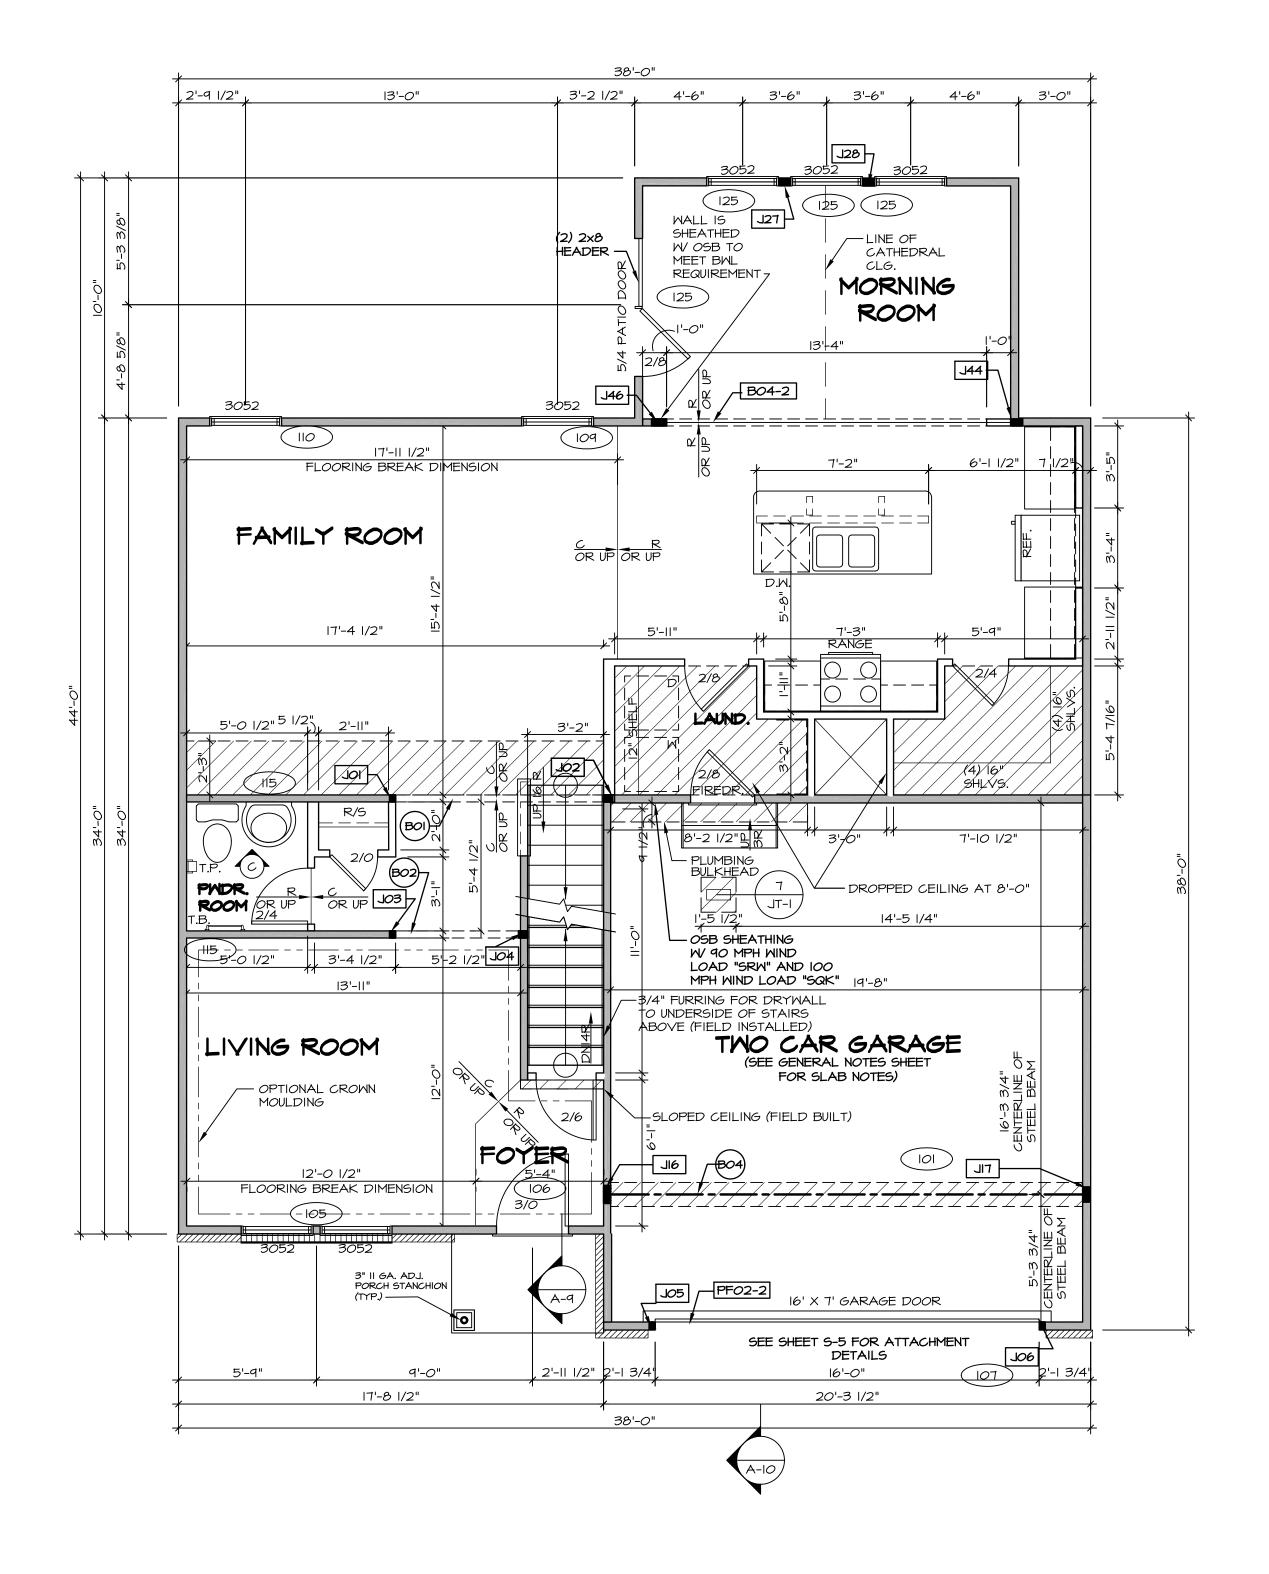




SECOND FLOOR JACK SCHEDULE

IDENTIFIER DESCRIPTION OPTIONS ENG. NUM. FIELD INSTALLED

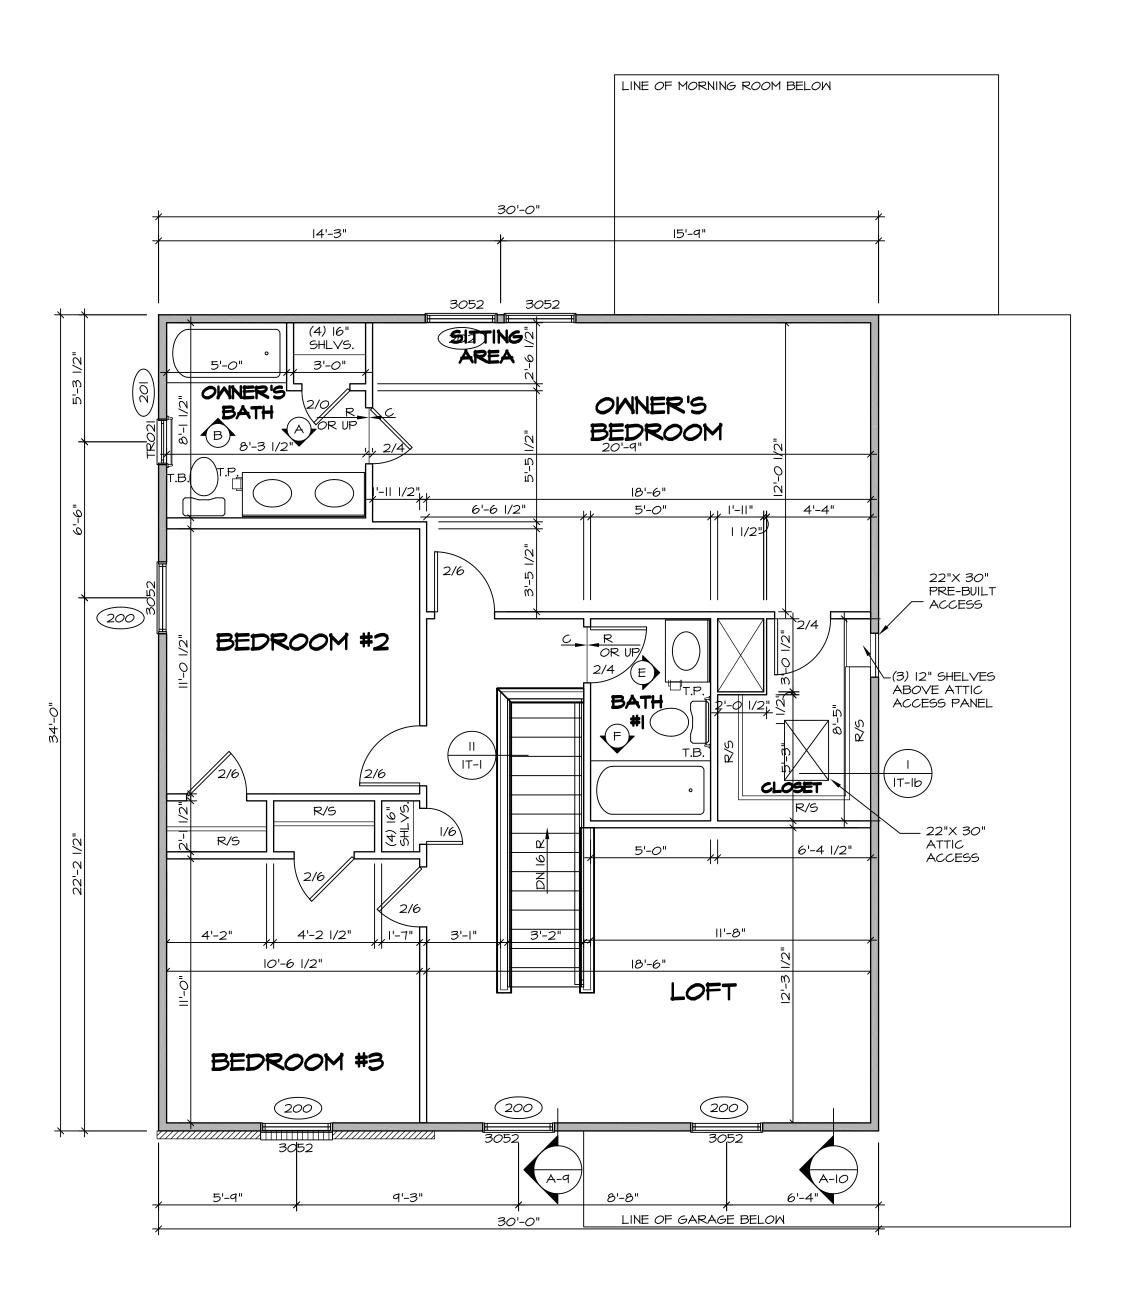




FLOOR PLAN NOTES I. ALL HEADERS ARE (2) 2x6 w/ 2x4 WALLS OR (3) 2x6 w/ 2x6 WALLS, UNLESS OTHERWISE NOTED. 2. ALL HEADERS TO HAVE (I) 2x4 OR 2x6 JACK AND KING STUD EACH END, UNLESS OTHERWISE NOTED. 3. ALL EXTERIOR WALLS TO BE 4" w/ OSB OR 3 I/2" w/ T-PL-Y, ALL INTERIOR WALLS TO BE 3 I/2", UNLESS OTHERWISE NOTED. 4. HATCHED AREAS INDICATE DROPPED CEILINGS. ALL DROPPED CEILINGS ARE 12" UNLESS OTHERWISE NOTED. 5. SEE "BRACED WALL PANEL DETAIL SHEET" FOR SPECIAL WALL FRAMING LOCATIONS AND HEADER SIZES, IF APPLICABLE. 6. SEE STANDARD DETAIL CATEGORY "IT" SHEET(S) FOR INTERIOR TRIM DETAILS. 7. SEE ARCHITECTURAL DETAIL SHEET "AD" FOR HOUSE SPECIFIC INTERIOR TRIM OPTION TABLE. 8. ALL WINDOWS HAVE 7'-O I/2" HEADER HEIGHT UNLESS OTHERWISE NOTED. 9. ALL HEADERS IN NON-BEARING WALLS SHALL BE A SINGLE FLAT 2X4 OR 2X6 ATTACHED TO CRIPPLES ABOVE, UNLESS OTHERWISE NOTED.	BEARING WALL NON BEARING WALL NON BEARING WALL NON BEARING FROM POINT-LOAD ABOVE JACKS B. BEAM/HEADER F. PAD FOOTING STEEL COLUMN X PORTAL FRAME X JOIST/TRUSS L LVL X ENGINEERING PAGE NUMBER SEE FC DETAILS FOR FRAMING CONNECTORS	REMARKS
		REV. NO. DATE I O7/28/16 TM - DRAWING ALIGNMENT 2 7/24/17 DRH - T-PLY CONVERSION
		NVR, Inc., owner, expressly reserves its common law copyright and other property rights in these plans. These plans are not to be reproduced, changed, or copied in any form or manner whatsoever, nor are they to be assigned to any third party, without first obtaining the expressed written consent of NVR, Inc.
		SET NO. FLROO VERSION O6 DRAWN BY DATE: OPTION Architectural Services Architects Archite
		MODEL FLORENCE BRAWING TITLE SECOND FLOOR PLAN OPTION DESCRIPTION Solves\FLORENCE_FLR00_06\DCY-CH-S125\610652\Sh

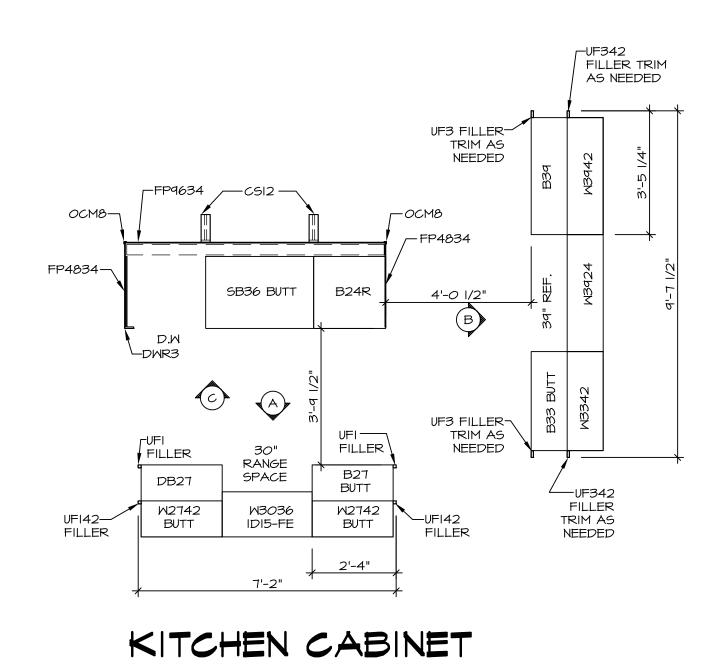


PLAN - KC-3414

A-12 SCALE: 3/8" = 1'-0"

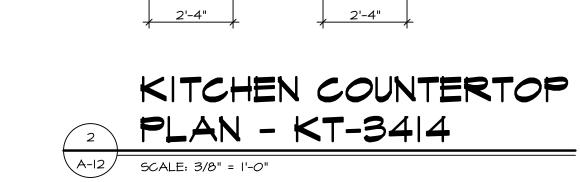

-SIDESPLASH

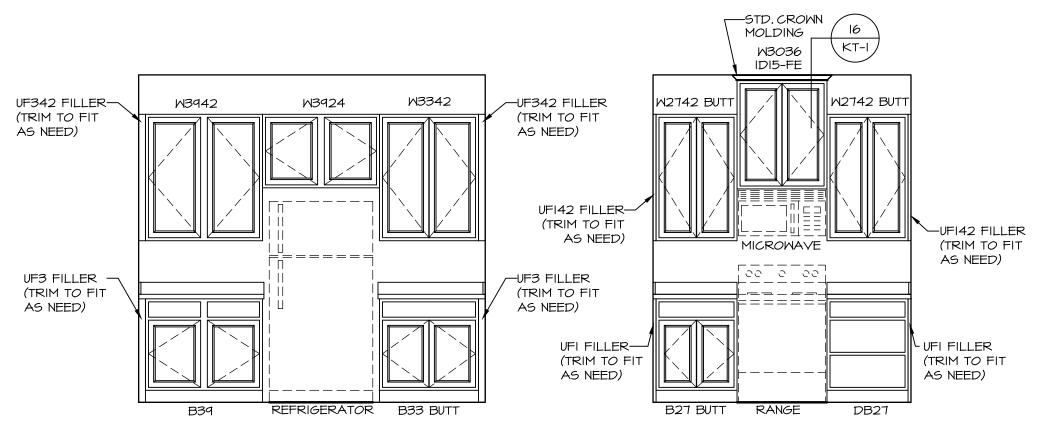






_DMR3 (TRIM TO I")


_SIDESPLASH


END CAP 2'-1"


LSIDESPLASH


-SIDESPLASH

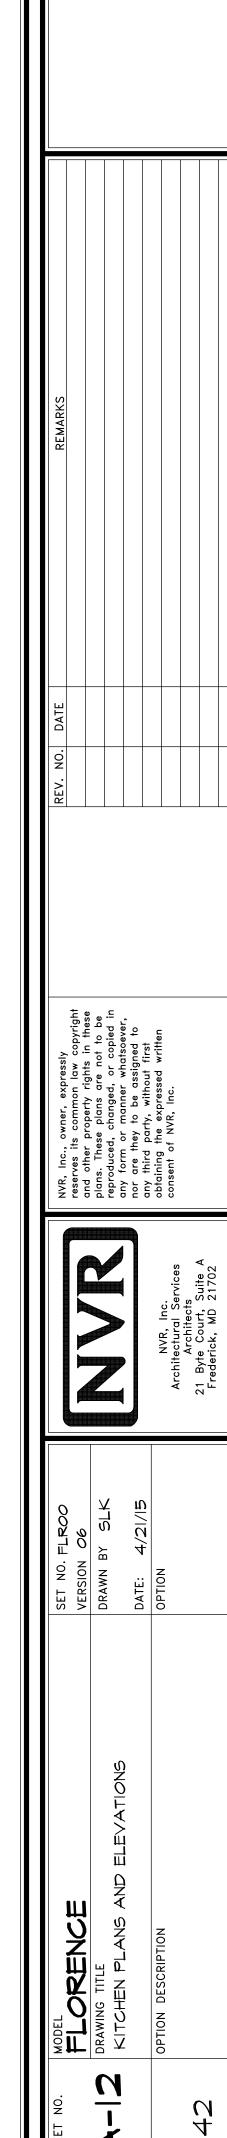


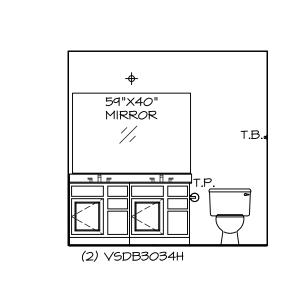

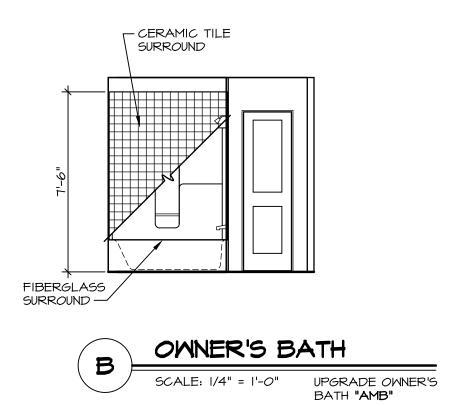

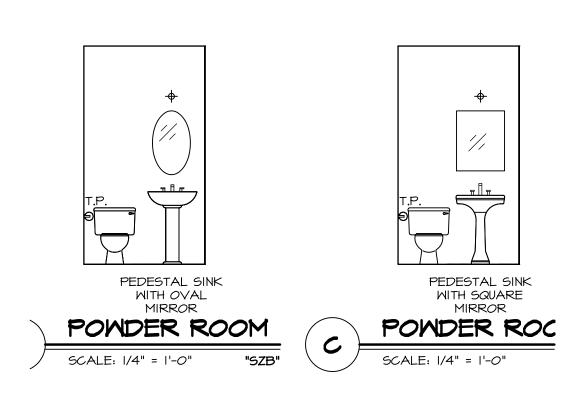

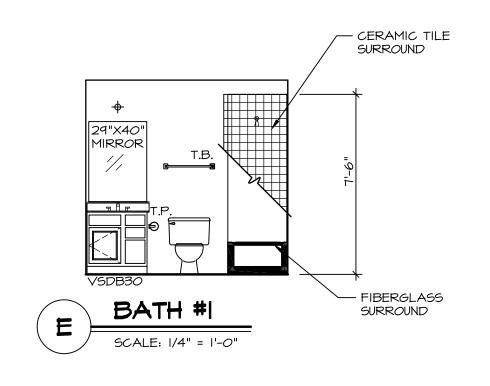

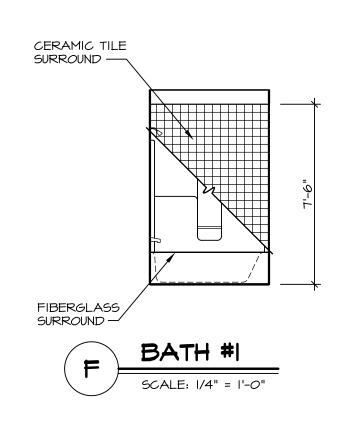

NOTES:

- TEMPERED GLASS SHOWER
 ENCLOSURE WITH SWING DOOR OR
 OPTIONAL SLIDING DOOR BY DIVISION
 TUB ACCESS PANELS PROVIDED AS
 NEEDED, ALL MATERIALS BY DIVISION
 REFER TO SHEET (IT-2) FOR TUB AND
 SHOWER DETAILS.
 ALL VSDB24-42 DRAWERS TO BE SET ON
 RIGHT HAND.
 BATH ELEVATIONS ARE SHOWN PER PLAN.