
DY 8389 1270 DEER VALLEY DR

2 Story Basementfull bath basement50 gal electricAA on kitchen2 showers1 tub

Gas Furnace

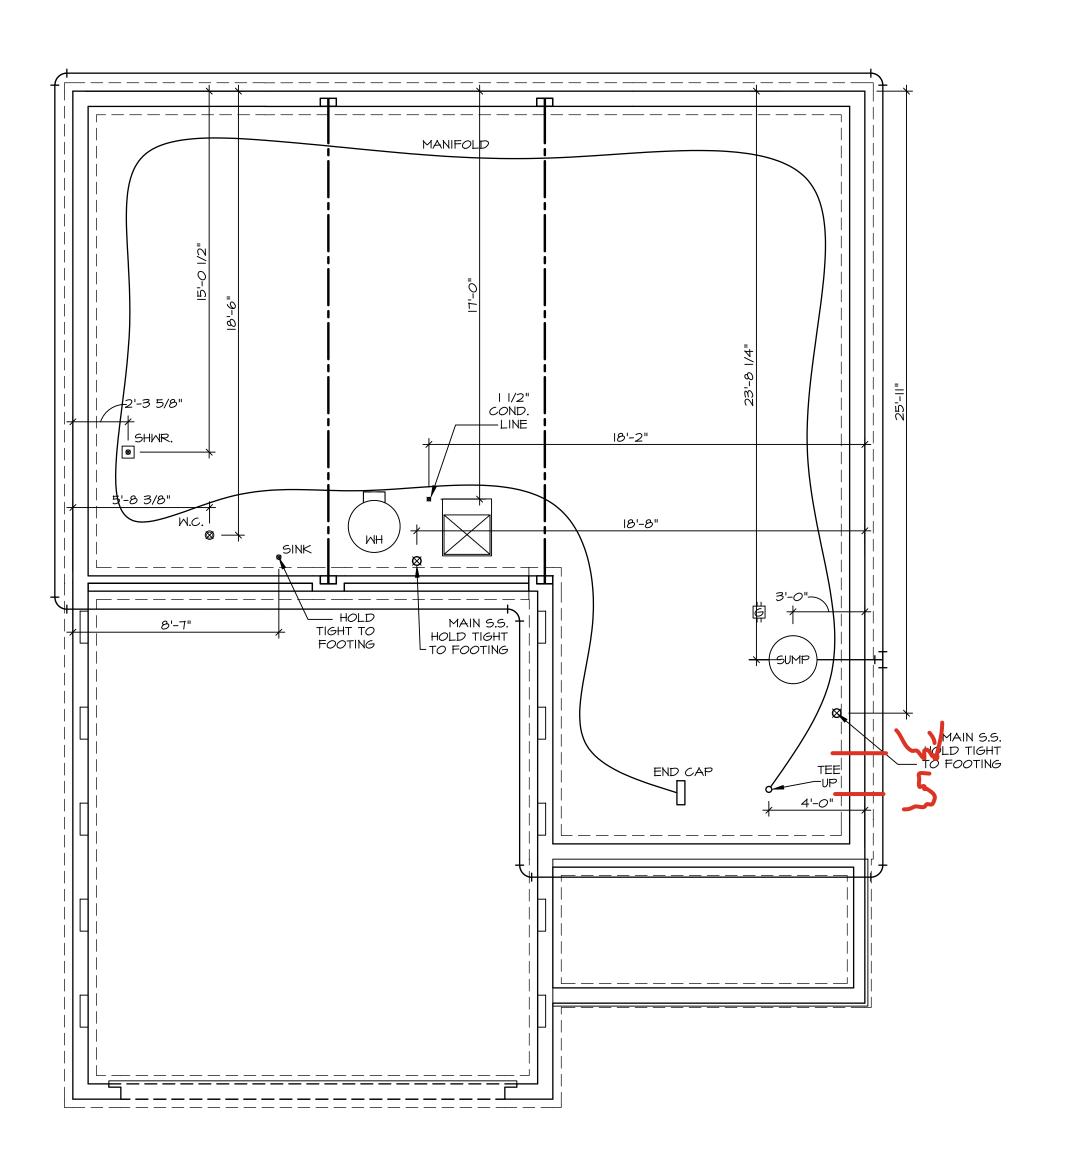



PLUMBING NOTES:

RADON REMEDIATION
RADON LOOP:

- (4") PERFORATED "LOOP"

- MUST BE PLACED IN STONE BED SLIGHTLY HIGHER THAN ANY INTERIOR DRAINTILE


- LOOP TO BE SEPARATE FROM ANY DRAINTILE ELEMENTS

- TO BE CORRUGATED PIPE


- SCREWS TO BE INSTALLED THROUGH LOOP AT TEE UP INTO STACK
STACK REQUIREMENTS:

- 3" PVC STACK (4" IF BASEMENT IS GREATER THAN 2200 SQFT.)

3" PVC STACK (4" IF BASEMENT IS GREATER THAN 2200 SQFT.)
NO PART OF STACK IS TO BE HORIZONTAL (45° ELBOWS PERMITTED AS REQUIRED)
PIPE TO BE PHYSICALLY LABELED IN THE FIELD AS "RADON VENT" OR OTHER JURISDICTIONALLY REQUIRED LANGUAGE (ON EVERY LEVEL OF HOUSE)
ROOF TERMINATION TO BE IN TOP 1/3 OF ROOF
SCREEN OR VENT CAP INSTALLED TO KEEP PESTS OUT OF RADON VENT AT ROOF TERMINATION.

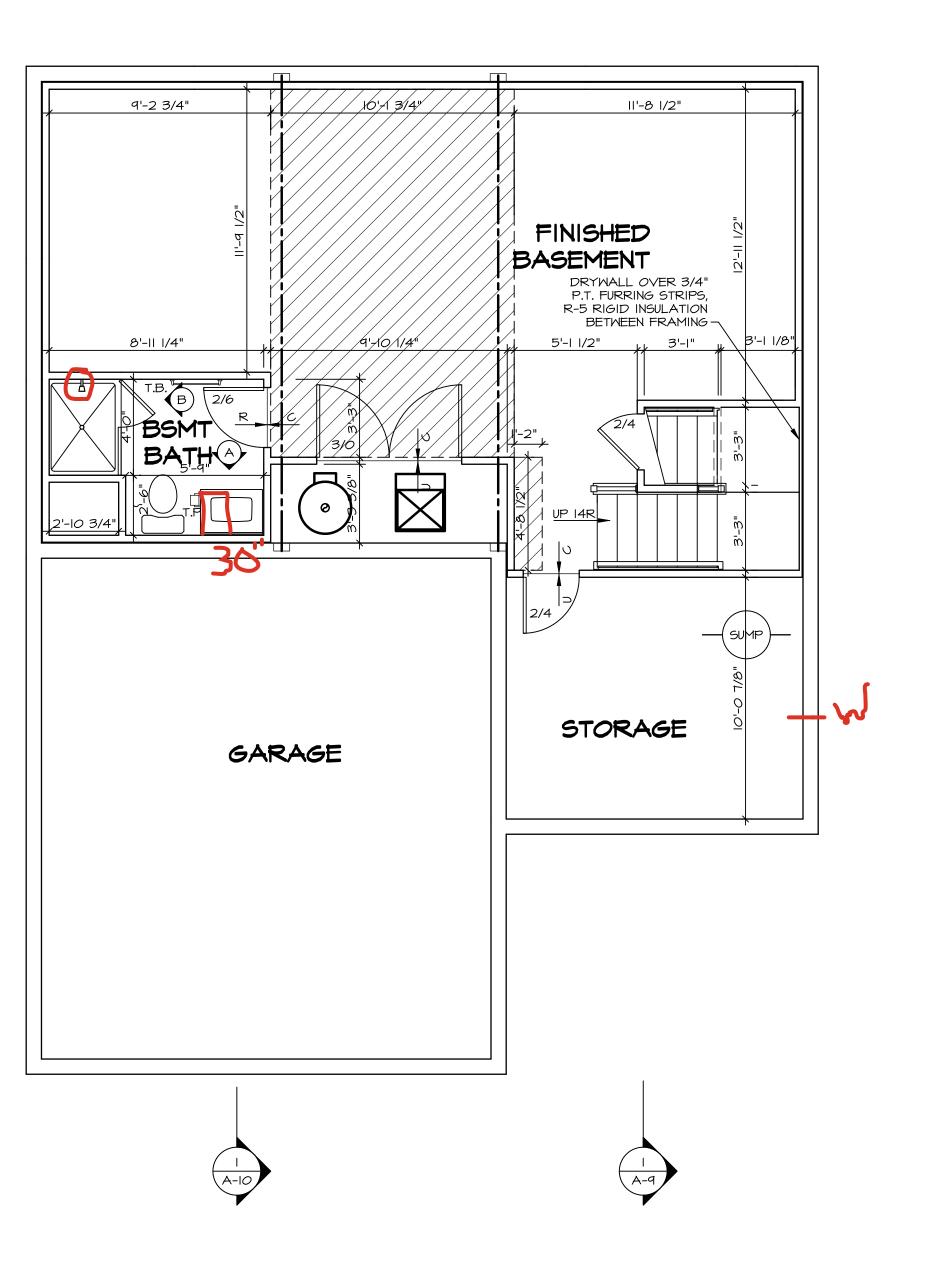



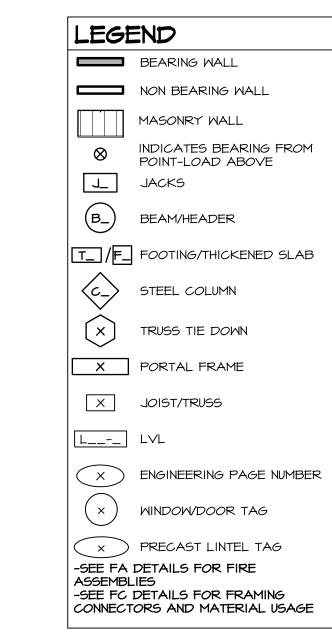

FLOOR PLAN NOTES:

- ALL HEADERS ARE (2) 2x6 w/ 2x4 WALLS OR (3) 2x6 w/ 2x6 WALLS, UNLESS OTHERWISE NOTED.
 ALL HEADERS TO HAVE (I) 2x4 OR 2x6 JACK AND KING STUD EACH END, UNLESS OTHERWISE NOTED.
 MULTI-OPENING HEADERS TO HAVE (2) JACKS AT INTERMEDIATE BEARING, UNLESS OTHERWISE NOTED. NO ADDITIONAL FLOOR SYSTEM BLOCKING OR CONTINUOUS LOAD PATH JACKS ARE REQUIRED UNLESS OTHERWISE
- 3. ALL EXTERIOR WALLS TO BE 4" OR 6" AND ALL INTERIOR WALLS TO BE 3 I/2", UNLESS OTHERWISE NOTED.
 4. HATCHED AREAS INDICATE DROPPED CEILINGS. ALL DROPPED CEILINGS ARE I2" UNLESS OTHERWISE NOTED.
 SEE ARCHITECTURAL DETAIL 8/IT-IB FOR 3/4" FIRE
- STOPPING AT BULKHEAD / CEILING PANELS

 5. SEE "BRACED WALL PANEL DETAIL SHEET" FOR SPECIAL WALL FRAMING LOCATIONS AND HEADER SIZES, IF APPLICABLE.
- 6. SEE STANDARD DETAIL CATEGORY "IT" SHEET(S) FOR INTERIOR TRIM DETAILS.
 7. SEE DETAIL SHEET "AD" FOR HOUSE SPECIFIC INTERIOR
- TRIM OPTION TABLE.

 8. ALL HEADERS IN NON-BEARING WALLS SHALL BE A SINGLE FLAT 2X4 OR 2X6 ATTACHED TO CRIPPLES
- ABOVE, UNLESS OTHERWISE NOTED.

 9. TANKED WATER HEATER SHOWN AS BASE CONDITION,
 OPTIONAL TANKLESS WATER HEATER IS AVAILABLE IN
- LIEU OF TANKED WATER HEATER.

 IO. INTERIOR HEADER HEIGHT FOR 8' CEILING WILL BE 6'-II",
 9' CEILING WILL BE 7'-II", IO' CEILING WILL BE 8'-3",
- UNLESS OTHERWISE NOTED.

 II. BASEMENT FINISH DIMENSIONS ASSUME A 1/2" GAP BETWEEN FRAME WALL AND CONCRETE WALL.
- 12. ALL INTERIOR BEARING WALLS SHALL HAVE GYPSUM APPLIED TO AT LEAST ONE SIDE OR HAVE MID-HEIGHT BLOCKING INSTALLED.
 13. NON-BEARING WALLS OVER CONCRETE TO BE HELD 1/2" SHORT OF FRAMING ABOVE.

GYPSUM NOTES:

AT GARAGE:

GYPSUM BOARD AT COMMON WALLS, CEILINGS, BEAM WRAPS AND SUPPORTS PER STANDARD DETAIL FA-I(b) FIRE ASSEMBLIES OR AS REQUIRED BY LOCAL CODE.

AT STAIRS:

1/2" GYPSUM BOARD AT UNDERSIDE OF STAIRS AND WALLS

	90	APT. NO.
	DIV-COMM-LOT-UNIT DCY-DY-8384 COMM-LOT DEER VALLEY - 8384	STREET ADDRESS
	© NVR, Inc., The owner, expressly reserves its copyright and other property rights in these plans. These plans are not to be reproduced, changed, or copied in any form or manner whatsoever, nor are they to be	assigned to any third parry, without first obtaining the expressed written consent of NVR, Inc.

NVR, Inc.
5285 Westview Drive, Suite 100
Frederick, MD 21703

RELEASE NO. ---DRAWN BY TN
DATE: OB/O9/2017
OPTION

VERSI RELEA DRAWI DATE: OPTIO


LEGHENY
ING TITLE
FMENT FLOOR PLAN
N DESCRIPTION

PRAM PLAM BA


	FIRST FLOOR JACK SCHEDULE				
IDENTIFIER	DESCRIPTION	ENG. NUM.	REMARKS		
IOIL	JACK - (4) 2X4 SPF STUD GRADE	1004			
JI02	JACK - (4) 2X6 SPF STUD GRADE	1004			
SOIL	JACK - (5) 2X4 SP#I	1008			
JIO4	JACK - (5) 2X4 SP#I	1008			
JI <i>0</i> 5	JACK - (3) 2X6 SP#I	1010			
JI06	JACK - (3) 2X4 SP#I	1010			
III	JACK - (2) 2X4 SPF STUD GRADE	1025			
JII2	JACK - (2) 2X4 SPF STUD GRADE	1025			
EIIL	JACK - (2) 2X4 SPF STUD GRADE	1033			
JII5	JACK - (4) 2X4 SPF STUD GRADE	1006			
JII6	JACK - (2) 2X4 SPF STUD GRADE	1027			
TIIL	JACK - (2) 2X4 SPF STUD GRADE	1027			
BIIL	JACK - (2) 2X4 SPF STUD GRADE	1027			
PIIL	JACK - (2) 2X4 SPF STUD GRADE	1027			
J120	JACK - (2) 2X4 SPF STUD GRADE	1027			
J 2	JACK - (2) 2X4 SPF STUD GRADE	1027			
JI22	JACK - (2) 2X4 SPF STUD GRADE	1027			
JI24	JACK - (2) 2X4 SPF STUD GRADE	1027			

FIELD INSTALLED FIRST FLOOR BEAM/HEADER SCHEDULE					
IDENTIFIER	DESCRIPTION	LENGTH	ENG. NUM.	REMARKS	
BIOI	BEAM STEEL - WIOX30	20'-6"	1008		
PF107-2	LVL 1.75 - 11-04	19'-9"	1025	PORTAL FRAME I.A	

STEEL COLUMN SCHEDULE				
IDENTIFIER	STYLE	HEIGHT	ENG. NUM.	REMARKS
C107	STANCHION PORCH - 3 IN DIA IIGA ADJ	9'-10 1/8"	1033	

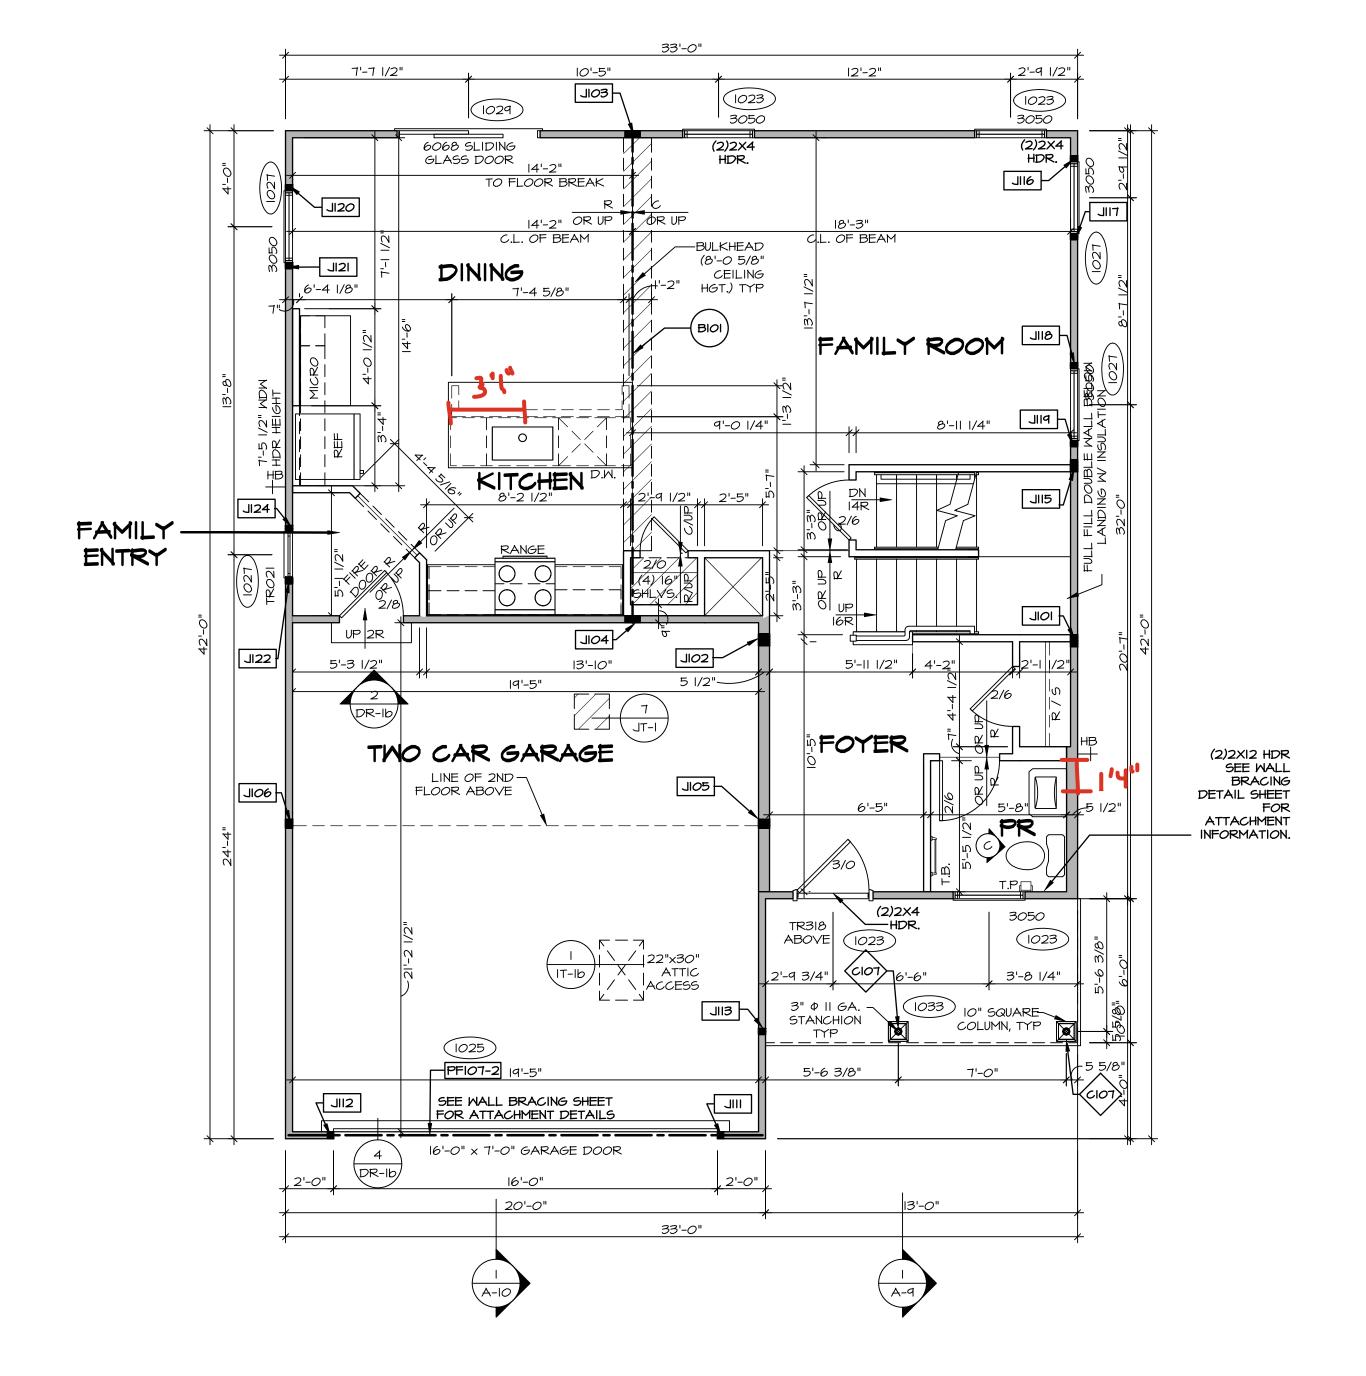



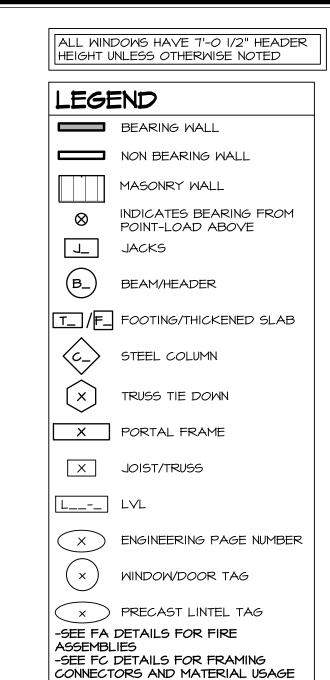

FLOOR PLAN NOTES:

ALL HEADERS ARE (2) 2x6 w/ 2x4 WALLS OR (3) 2x6 w/ 2x6 WALLS, UNLESS OTHERWISE NOTED.
 ALL HEADERS TO HAVE (I) 2x4 OR 2x6 JACK AND KING STUD EACH END, UNLESS OTHERWISE NOTED.
 MULTI-OPENING HEADERS TO HAVE (2) JACKS AT INTERMEDIATE BEARING, UNLESS OTHERWISE NOTED. NO ADDITIONAL FLOOR SYSTEM BLOCKING OR CONTINUOUS LOAD PATH JACKS ARE REQUIRED UNLESS OTHERWISE NOTED.
 ALL EXTERIOR WALLS TO BE 4" OR 6" AND ALL INTERIOR WALLS TO BE 3 I/2", UNLESS OTHERWISE NOTED.
 HATCHED AREAS INDICATE DROPPED CEILINGS. ALL DROPPED CEILINGS ARE I2" UNLESS OTHERWISE NOTED. SEE ARCHITECTURAL DETAIL 8/IT-IB FOR 3/4" FIRE STOPPING AT BULKHEAD / CEILING PANELS

SEE ARCHITECTURAL DETAIL 8/IT-IB FOR 3/4" FIRE STOPPING AT BULKHEAD / CEILING PANELS

5. SEE "BRACED WALL PANEL DETAIL SHEET" FOR SPECIAL WALL FRAMING LOCATIONS AND HEADER SIZES, IF APPLICABLE.

6. SEE STANDARD DETAIL CATEGORY "IT" SHEET(S) FOR

6. SEE STANDARD DETAIL CATEGORY "IT" SHEET(S) FOR INTERIOR TRIM DETAILS.
7. SEE DETAIL SHEET "AD" FOR HOUSE SPECIFIC INTERIOR TRIM OPTION TABLE.
8. ALL HEADERS IN NON-BEARING WALLS SHALL BE A

8. ALL HEADERS IN NON-BEARING WALLS SHALL BE A SINGLE FLAT 2X4 OR 2X6 ATTACHED TO CRIPPLES ABOVE, UNLESS OTHERWISE NOTED.

9. TANKED WATER HEATER SHOWN AS BASE CONDITION, OPTIONAL TANKLESS WATER HEATER IS AVAILABLE IN

LIEU OF TANKED WATER HEATER.

IO. INTERIOR HEADER HEIGHT FOR 8' CEILING WILL BE 6'-II",

9' CEILING WILL BE 7'-II", IO' CEILING WILL BE 8'-3",

UNLESS OTHERWISE NOTED.

II. BASEMENT FINISH DIMENSIONS ASSUME A I/2" GAP
BETWEEN FRAME WALL AND CONCRETE WALL.

I2. ALL INTERIOR BEARING WALLS SHALL HAVE GYPSUM
APPLIED TO AT LEAST ONE SIDE OR HAVE MID-HEIGHT

BLOCKING INSTALLED.

3. NON-BEARING WALLS OVER CONCRETE TO BE HELD 1/2"
SHORT OF FRAMING ABOVE.

GYPSUM NOTES:

AT GARAGE:

GYPSUM BOARD AT COMMON WALLS, CEILINGS, BEAM WRAPS AND SUPPORTS PER STANDARD DETAIL FA-I(b) FIRE ASSEMBLIES OR AS REQUIRED BY LOCAL CODE.

AT STAIRS:

1/2" GYPSUM BOARD AT UNDERSIDE OF STAIRS AND WALLS IN CLOSET

LVL PLY TO PLY FASTENING SCHEDULE: (WHERE APPLICABLE BASED ON LVL USAGE)

I.A - (2) PLY UP TO AND INCLUDING II 7/8" TALL: FASTEN PLIES W (2) ROWS 16D NAILS AT 12" O.C. OR

ALT I 1/2" WIDE LVL FASTEN PLIES W (3) ROWS 12D NAILS AT 12"O.C.

2.A - (2) PLY I4" UP TO AND INCLUDING I8": FASTEN PLIES W/ (3) ROWS I6D NAILS AT I2" O.C. OR ALT I I/2" WIDE LVL FASTEN PLIES W/ (4) ROWS I2D NAILS AT I2"O.C.

3.A - (2) PLY 20" TALL AND OVER: FASTEN PLIES W (4) ROWS 16D NAILS AT 12" O.C. OR ALT 1 1/2" WIDE LVL FASTEN PLIES W (5) ROWS 12D NAILS AT 12"O.C.

4.A - (3) PLY UP TO AND INCLUDING II 7/8" TALL: FASTEN PLIES W (2) ROWS 16D NAILS AT 12" O.C.

FROM EACH SIDE OR ALT I I/2" WIDE LVL FASTEN PLIES W/ (3) ROWS I2D NAILS AT I2"O.C. FROM EACH SIDE.

5.A - (3) PLY I4" UP TO AND INCLUDING I8": FASTEN PLIES W/ (3) ROWS I6D NAILS AT I2"O.C.

FROM EACH SIDE OR ALT I I/2" WIDE LVL FASTEN PLIES W/(4) ROWS I2D NAILS AT I2"O.C. FROM EACH SIDE.


6.A - (3) PLY 20" TALL AND OVER: FASTEN PLIES W/ (4) ROWS I6D NAILS AT I2" O.C. FROM EACH SIDE

6.A - (3) PLY 20" TALL AND OVER: FASTEN PLIES W (4) ROWS 16D NAILS AT 12" O.C. FROM EACH SIDE OR ALT I 1/2" WIDE LVL FASTEN PLIES W (5) ROWS 12D NAILS AT 12"O.C. FROM EACH SIDE.


7.A - (4) PLY (ALL SIZES); FASTEN PLIES WITH (3) ROWS OF SDW22634 STRUCTURAL WOOD SCREWS, OR EQUIVALENT, AT 16" O.C. STAGGERED. SEE SHOP DRAWING FOR ADDITIONAL INFORMATION.

ALLEGHENY
DRAWING TITLE
FIRST FLOOR PLAN
OPTION DESCRIPTION

SECOND FLOOR JACK SCHEI		DULE
IDENTIFIER	DESCRIPTION	ENG. NUM.

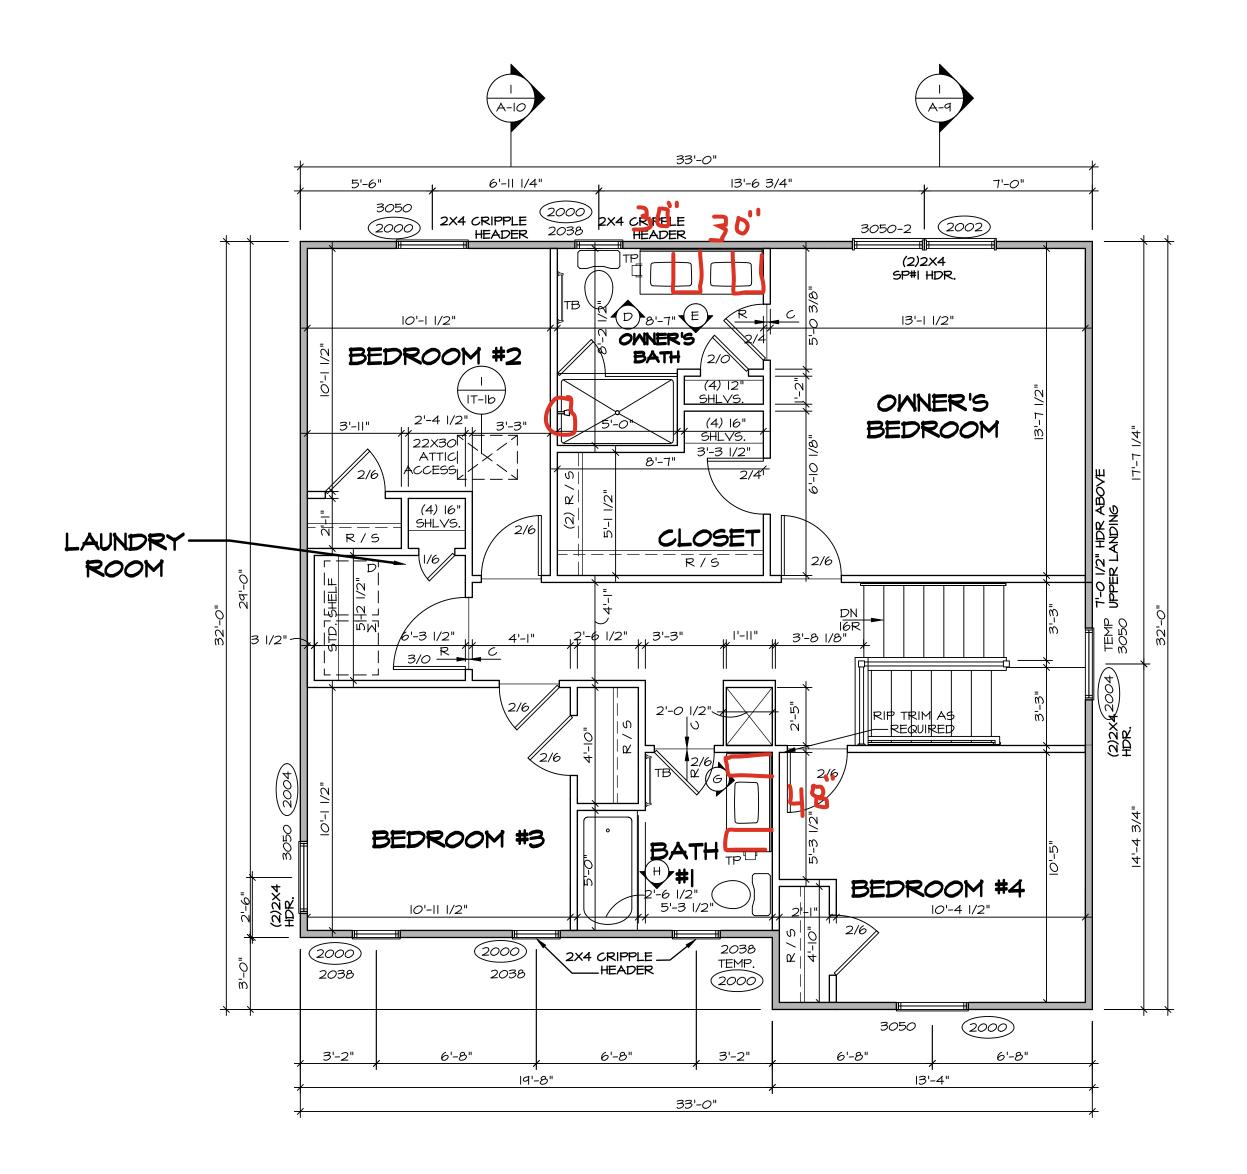



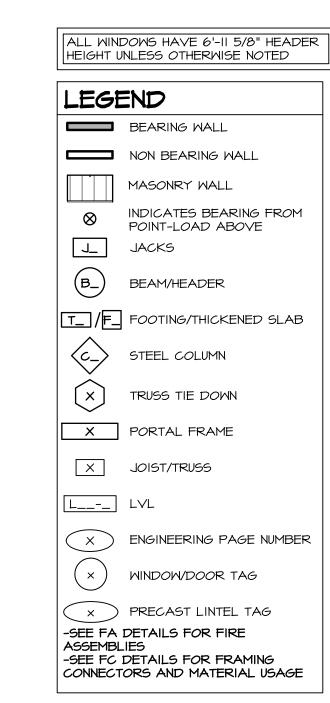

FLOOR PLAN NOTES:

- ALL HEADERS ARE (2) 2x6 w/ 2x4 WALLS OR (3) 2x6 w/ 2x6 WALLS, UNLESS OTHERWISE NOTED.
 ALL HEADERS TO HAVE (I) 2x4 OR 2x6 JACK AND KING STUD EACH END, UNLESS OTHERWISE NOTED.
 MULTI-OPENING HEADERS TO HAVE (2) JACKS AT INTERMEDIATE BEARING, UNLESS OTHERWISE NOTED. NO ADDITIONAL FLOOR SYSTEM BLOCKING OR CONTINUOUS LOAD PATH JACKS ARE REQUIRED UNLESS OTHERWISE NOTED.
- ALL EXTERIOR WALLS TO BE 4" OR 6" AND ALL INTERIOR WALLS TO BE 3 I/2", UNLESS OTHERWISE NOTED.
 HATCHED AREAS INDICATE DROPPED CEILINGS. ALL DROPPED CEILINGS ARE I2" UNLESS OTHERWISE NOTED. SEE ARCHITECTURAL DETAIL 8/IT-IB FOR 3/4" FIRE STOPPING AT BULKHEAD / CEILING PAINELS.
- 5. SEE "BRACED WALL PANEL DETAIL SHEET" FOR SPECIAL WALL FRAMING LOCATIONS AND HEADER SIZES, IF APPLICABLE.

 6. SEE STANDARD DETAIL CATEGORY "IT" SHEET(S) FOR
- 6. SEE STANDARD DETAIL CATEGORY "IT" SHEET(S) FOR INTERIOR TRIM DETAILS.

 7. SEE DETAIL SHEET "AD" FOR HOUSE SPECIFIC INTERIOR
- TRIM OPTION TABLE.

 8. ALL HEADERS IN NON-BEARING WALLS SHALL BE A SINGLE FLAT 2X4 OR 2X6 ATTACHED TO CRIPPLES
- ABOVE, UNLESS OTHERWISE NOTED.

 9. TANKED WATER HEATER SHOWN AS BASE CONDITION,
 OPTIONAL TANKLESS WATER HEATER IS AVAILABLE IN
- LIEU OF TANKED WATER HEATER.

 10. INTERIOR HEADER HEIGHT FOR 8' CEILING WILL BE 6'-II",
 9' CEILING WILL BE 7'-II", 10' CEILING WILL BE 8'-3",
- UNLESS OTHERWISE NOTED.

 II. BASEMENT FINISH DIMENSIONS ASSUME A 1/2" GAP
 BETWEEN FRAME WALL AND CONCRETE WALL.
- 12. ALL INTERIOR BEARING WALLS SHALL HAVE GYPSUM APPLIED TO AT LEAST ONE SIDE OR HAVE MID-HEIGHT BLOCKING INSTALLED.
- 13. NON-BEARING WALLS OVER CONCRETE TO BE HELD 1/2" SHORT OF FRAMING ABOVE.

GYPSUM NOTES:

AT GARAGE:

GYPSUM BOARD AT COMMON WALLS, CEILINGS, BEAM WRAPS AND SUPPORTS PER STANDARD DETAIL FA-I(b) FIRE ASSEMBLIES OR AS REQUIRED BY LOCAL CODE.

AT STAIRS:

IN CLOSET

1/2" GYPSUM BOARD AT UNDERSIDE OF STAIRS AND WALLS

SET NO. ALGOO VERSION OI PRELEASE NO DRAWN BY YON DRAWN BY YON OPTION Frederick, MD 21703 SET NO. ALGOO WERSION OI PROWN-LOT COMM-LOT COMM-LOT COMM-LOT COMM-LOT COMM-LOT DEER VALLEY - 83894 STREET ADDRESS I 270 DEER VALLEY DR STATE CITY DIV-COMM-LOT COMM-LOT COMM-LO						
S285 Westview Drive, Suite 100 Frederick, MD 21703 S285 Westview Drive, Suite 100 Frederick, MD 21703 WINNIEL The owner, expressly reserves its copyright and other property rights in these plans are not to be reproduced, changed, or consent of NVR, Inc. S285 Westview Drive, Suite 100 Frederick, MD 21703 WIAMISBURG S17 DIV-COMM-LOT COMM-LOT COMM-LOT DEER VALLEY - 83894 STREET ADDRESS IZ70 DEER VALLEY DR CITY MIAMISBURG S17	39		APT. NO.		ZIP	45342
The owner, expressly reserves its copyright and other property rights in these plans. These plans are not to be reproduced, changed, or copied in any form or manner whatsoever, nor are they to be assigned to any third party, without first obtaining the expressed written consent of NVR, Inc. 5285 Westview Drive, Suite 100 Frederick, MD 21703 CITY MIAMISBUR	>			٧.	STATE	₹
2017 NVR, Inc. 5285 Westview Drive, Suite 100 Frederick, MD 21703	DIV-COMM-LOT-UNIT	COMM-LOT DEER VALLEY - 8389	STREET ADDRESS	1270 DEER VALLEY DI	CITY	MIAMISBURG
70 7	© NVR, Inc., The owner, expressly reserves its copyright and other property rights in these plans. These plans are not	to be reproduced, changed, or copied in any form or manner whatsoever, nor are they to be	first obtaining the expressed written	;;;;;;;;;;;;;;;;;;;;;;;;;;;;;;;;;;;;;;		
SET NO. ALGOO VERSION OI RELEASE NO DRAWN BY YON DATE: OB/IO/2017 OPTION			NVR, Inc. 5285 Westview Drive, Suite 100	Frederick, MD 21703		
	SET NO. ALGOO VERSION OI RELEASE NO	DRAWN BY YON DATE: 08/10/2017	OPTION			

KITCHEN NOTES:

CABINET LAYOUT (S) ARE BASED ON FINISHED DIMENSIONS TO DRYWALL.

 IF KITCHEN PLANS/ELEVATIONS CALL-OUT STANDARD MOLDING, REFER TO STANDARD

DETAIL II/KT-I FOR REPLACEMENT BASED
ON CABINET STYLE.

3 ALL (UF#) FILLERS ARE TO BE "TRIM TO FIT"

ON CABINET STYLE.

3. ALL (UF#) FILLERS ARE TO BE "TRIM TO FIT"
UNLESS OTHERWISE NOTED.


4. CABINET MUST BE SET, SHIMMED, LEVELED

4. CABINET MUST BE SET, SHIMMED, LEVELED AND PLUMB W/ ADJOINING BASE CABINETS.
5. SET PRE-FINISHED SCRIBE MOLDING AT CABINET BULKHEADS AND AT ENDS (WHERE CABINETS MEET DRYWALL.) PRE-FINISHED SCRIBE MOLDING SHALL BE USED TO PAD OUT CABINET SIDES AT STILE FOR RETURN PIECES OF THE FACE-MOUNTED CABINET CROWN MOLDING.


6. HARDWARE INSTALL NOTE: KNOBS GO ON OPERABLE DOORS AND DRAWERS FOR ALL KITCHEN AND BATH AREAS. DRAWER FRONTS AND DOORS GET (I) KNOB/PULL. NO HARDWARE ON FALSE DRAWER FRONTS. REFER TO STANDARD DETAIL 5/KT-Ib

NOTES


CABINETS ARE NOT REPRESENTATIVE OF ALL STYLES AND ARE MEANT AS A GENERAL DEPICTION OF THE INTENDED CABINET LAYOUT

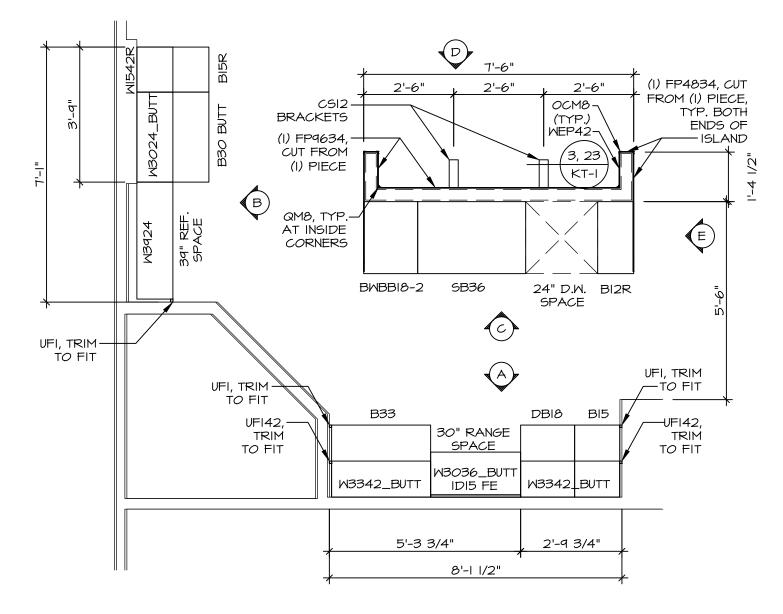




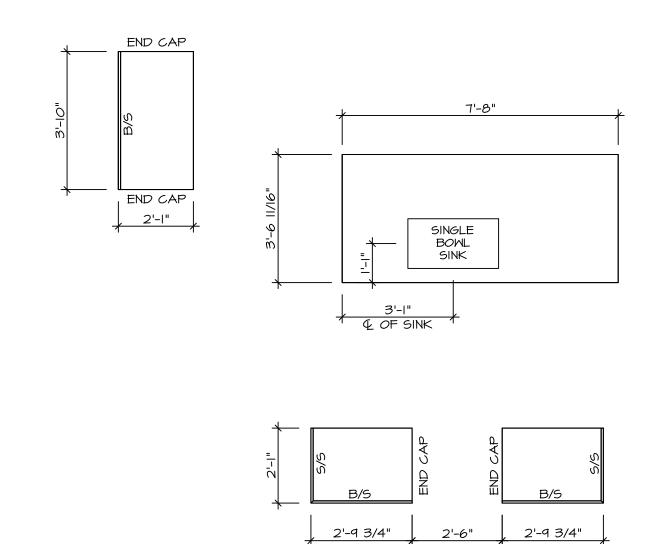




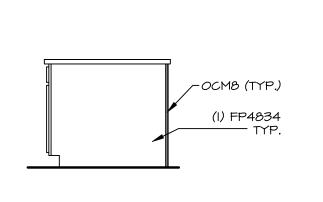




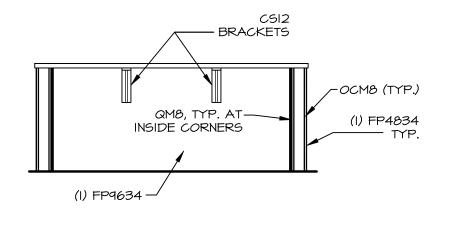




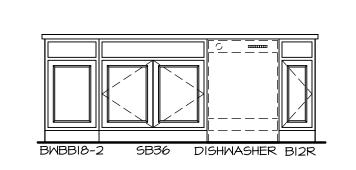




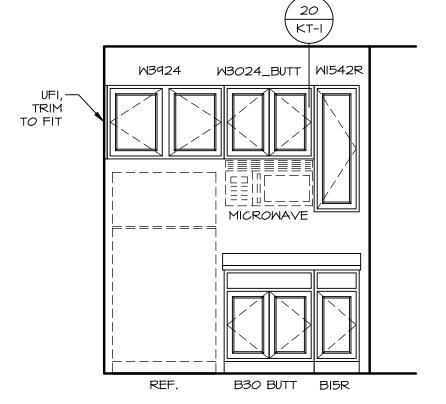




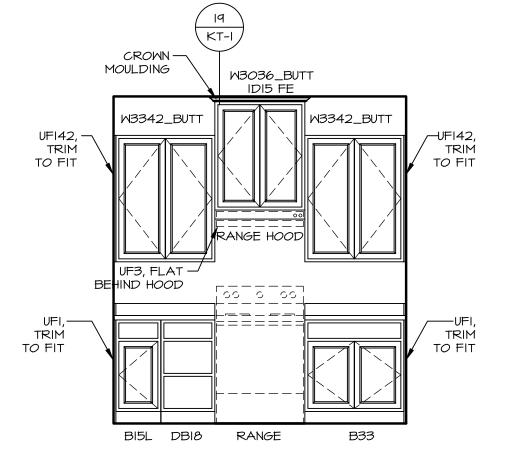


ELEVATION "A"	A
SCALE: 3/8" = 1'-0"	\

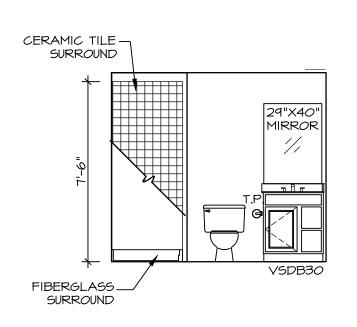




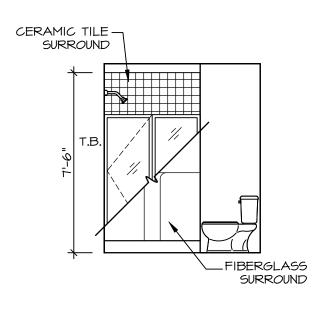





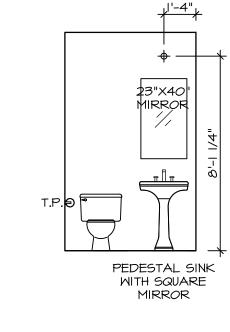




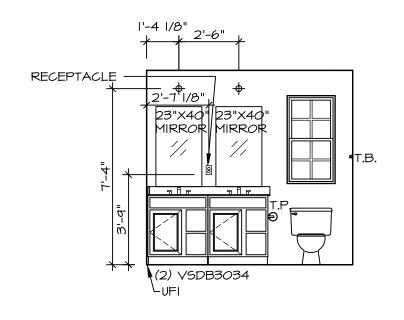


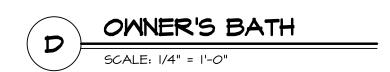


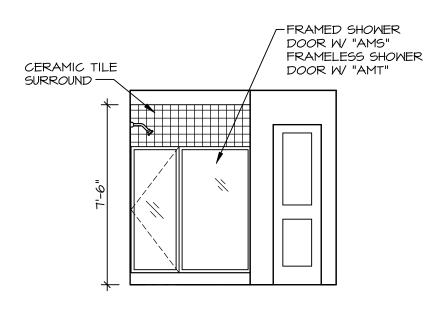



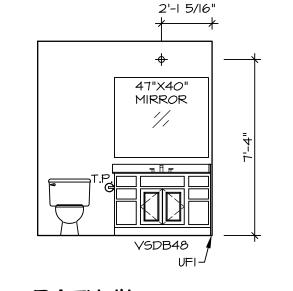

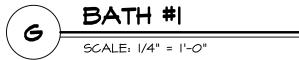

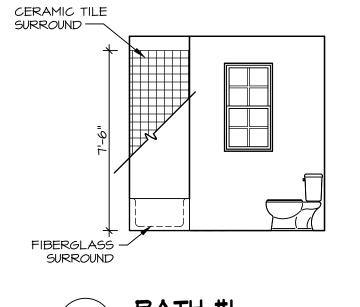

	BATH #I
П	SCALE: 1/4" = 1'-0"

BATH NOTES:

- I. TEMPERED GLASS SHOWER ENCLOSURE
 WITH SWING DOOR OR OPTIONAL SLIDING
 DOOR BY DIVISION.

 2. TUB ACCESS PANELS PROVIDED AS
 NEEDED, ALL MATERIALS BY DIVISION.

 3. REFER TO DETAILS IT- FOR TUB AND
 SHOWER
- 3. REFER TO DETAILS IT- FOR TUB AND SHOWER.
 4. ALL VANITIES WITH DRAWERS TO BE SET WITH DRAWERS ON RIGHT HAND SIDE.
 5. BATH ELEVATIONS ARE SHOWN PER PLAN.
 6. ALL DIMENSIONS SHOWN ON BATH ELEVATIONS ARE ROUGH FRAMING REFERENCES ONLY.