BUILDING TYPE Promenade (D3M - 2010)

8329 Park Place, West Chester, OH 45069 - Lot #162 Epcon Communities - Villas at Park Place

INDEX TO DRAWINGS

BUILDING D-3M

- A.100 FOUNDATION PLAN A.101 FIRST FLOOR PLAN -A.101B COVERED PORCH OPTION
- A.101C SCREENED PORCH A.101D SITTING ROOM OPTION
- A.101E 4 SEASONS ROOM OPTION A.101F ALTERNATE ROOF PLAN
- A.101G ALTERNATE ROOF FRAMING PLAN A.101H ALTERNATE ROOF PLAN ELEVATIONS
- A.101J DELUXE MASTER SUITE PLANS & ELECTRICAL A.101K DELUXE MASTER SUITE ELEVATIONS & ROOF PLANS -A.101L HIP ROOF W/ EXT. GARAGE PLANS & ELECTRICAL A.101M HIP ROOF W/ EXT. GARAGE ROOF PLANS
- A.102 ROOF PLAN
- A.201 EXTERIOR ELEVATIONS
- S.101 ROOF FRAMING PLAN
- S.102 ROOF TRUSS PROFILES S.102A ROOF TRUSS PROFILES
- S.103 SHEAR WALL PLANS S.104 SHEAR WALL DETAILS
- A.301 WALL SECTIONS A.302 WALL SECTIONS
- A.303 WALL SECTIONS A.304 DETAILS
- A.401 INTERIOR ELEVATIONS
- A.501 INTERIOR FINISH PLAN AND SCHEDULES A.502 WINDOW DETAILS
- P.100 PLUMBING PLANS
- P.101 SUPPLY PLUMBING PLAN P.102 PLUMBING SPECIFICATIONS AND SCHEDULES
- H.100 HVAC PLANS
- H.101 HVAC SCHEDULES & DETAILS E.100 ELECTRICAL PLAN
- E.101 ELECTRICAL PLAN AND DETAILS DELUXE KITCHEN

GENERAL NOTES

- 1. ALL WORK, SHALL COMPLY WITH APPLICABLE STATE AND LOCAL BUILDING CODES AND THE BUILDING STANDARDS REFERENCED THEREIN.
- 2. ALL WORK SHALL CONFORM TO THE HIGHEST LEVELS OF THE APPROPRIATE INDUSTRY STANDARDS FOR CUSTOM WORK.
- 3. ALL WORK TO BE COORDINATED AND SCHEDULED BY THE OWNER.
- 4. FRAMING LUMBER IN CONTACT WITH CONCRETE OR MASONRY, OR EXPOSED TO THE EXTERIOR SHALL BE PRESERVATIVE PRESSURE TREATED.
- 5. PLAN DIMENSIONS ARE TO FACE OF ROUGH FRAMING OR MASONRY UNLESS NOTED OTHERWISE. DIMENSIONS TO EXTERIOR WALLS INCLUDE 7/16" EXT. SHEATHING, ROUNDED TO THE NEAREST 1/4".
- 6. FINISH FLOOR ELEV. @ FIRST FLOOR LEVEL IS SET AT 100'-0". SEE SITE PLAN FOR ACTUAL FIRST FLOOR ELEVATION @ EACH BUILDING.
- 7. ALL INTERIOR PARTITIONS SHALL BE 2 x 4 STUDS @ 16" O.C. WITH 1/2" DRYWALL EACH SIDE. PLAN DIMENSION IS ASSUMED TO BE 3 1/2" UNLESS NOTED OTHERWISE. PROVIDE SOLID LUMBER BLOCKING FOR ALL WALL MOUNTED ITEMS.
- 8. ALL DRYWALL IN WET AREAS, AND AS A SUBSTRATE FOR TILE, SHALL BE MOISTURE RESISTANT 1/2" WATERBOARD OR GREENBOARD.
- 9. ALL INTERIOR COLORS AND FINISHES, NOT SPECIFIED HEREIN, TO BE SELECTED BY THE

Condominium



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CODE REVIEW INFORMATION

GOVERNING BUILDING CODE: 2013 RESIDENTIAL CODE OF OHIO

CONSTRUCTION TYPE: WOOD FRAME 1 STORY NUMBER OF STORIES:

BUILDING AREAS: 2,488 SF TOTAL AREA - FIRST FLOOR

GENERAL BUILDING INFORMATION

THIS BUILDING IS A (1) UNIT SINGLE FAMILY DWELLING STRUCTURE. THE DWELLING UNIT CONTAINS:

1,995 SF OF LIVING SPACE AND 493 SF GARAGE IN EACH UNIT. TOTAL = 2,488 SF. THE TYPE D-3M UNIT IS A SINGLE STORY DESIGN.

THE "EXTENDED GARAGE" OPTION HAS 2,013 SF OF LIVING SPACE AND 561 SF GARAGE.

THE OPTIONS BELOW WILL EACH ADD THE FOLLOWING SQUARE **FOOTAGE:**

SITTING ROOM - 105 SF

EXTENDED MASTER SUITE - 189 SF 68 SF

NOTES: 1. All Wall Insulation to be R-15, not R-13.

- 2. Drywall Ceiling area, except in garage, to be 1/2", not 5/8".
- 3. Builder may switch gas to Duke standard pressure (in lieu of 2 lb.), thereby increasing interior lines to 1" CSST and eliminating regulator.

GENERAL SPECIFICATIONS

- THE STRUCTURE IS DESIGNED TO BE SELF-SUPPORTING AND STABLE AFTER THE BUILDING IS FULLY COMPLETE. IT IS SOLELY THE CONTRACTORS RESPONSIBILITY TO INSURE THE SAFETY OF THE BUILDING AND ITS COMPONENT PARTS DURING ERECTION. THIS INCLUDES THE ADDITION OF TEMPORARY BRACING OR GUYS THAT MIGHT BE NECESSARY.
- 2. IT IS SOLELY THE CONTRACTOR'S RESPONSIBILITY TO FOLLOW ALL APPLICABLE SAFETY CODES AND REGULATIONS DURING ALL PHASES OF CONSTRUCTION.
- 3. THIS STRUCTURE IS DESIGNED TO RESIST THE FOLLOWING MINIMUM UNIFORMLY DISTRIBUTED LIVE LOADS: ATTICS WITHOUT STORAGE
- ATTICS WITH LIMITED STORAGE 20 PSF HABITABLE ATTICS 30 PSF ATTICS WITH FIXED STAIRS 30 PSF BALCONIES & DECKS 40 PSF
- ROOMS OTHER THAN SLEEPING ROOMS 30 PSF SLEEPING ROOMS 25 PSF (GROUND SNOW LOAD)
- CEILING JOISTS (HIGH SLOPE RAFTERS) CEILING JOISTS (LOW SLOPE/NO STORAGE) IO PSF
- 90 MPH (3 SECOND GUST), EXP. B

<u>CONCRETE</u>

- STRUCTURAL CONCRETE: FOOTINGS, INTERIOR SLABS F'C = 3000 PSI EXPOSED WALLS, GARAGE SLABS
- AND EXTERIOR SLABS ON GRADE F'C = 4000 PSI (5%-7% ENTRAINED AIR) ALL DEFORMED REINFORCING BARS FY = 60,000 PSI
- 2. CONCRETE TO BE MIXED AND PLACED PER ACI SPECIFICATIONS.

- MASONRY VENEER SHALL BE ANCHORED TO THE SUPPORTING WALL WITH CORROSION-RESISTANT METAL TIES EMBEDDED IN MORTAR OR GROUT, AND EXTENDING INTO THE VENEER A MINIMUM OF 1-1/2", WITH NOT LESS THAN 5/8"MORTAR OR GROUT COVER TO OUTSIDE FACE.
- 2. WHERE VENEER IS ANCHORED TO WOOD BACKINGS BY CORRUGATED SHEET METAL TIES, THE DISTANCE SEPARATING THE VENEER FROM THE SHEATHING MATERIAL SHALL BE A MAXIMUM OF I".
- 3. SHEET METAL TIES SHALL BE NOT LESS THAN NO. 22 U.S. GAGE BY 7/8" CORRUGATED. EACH TIE SHALL BE SPACED NOT MORE THAN 24" ON CENTER HORIZONTALLY AND VERTICALLY, AND SHALL SUPPORT NOT MORE THAN 2.67 SF OF
- 4. ADDITIONAL TIES SHALL BE PROVIDED AROUND ALL WALL OPENINGS GREATER THAN 16" IN EITHER DIMENSION. METAL TIES AROUND THE PERIMETER OF OPENINGS SHALL BE SPACED NOT MORE THAN 3'-O" O.C., AND PLACED WITHIN 12" OF THE WALL OPENING.

- VINYL SIDING SHALL BE CERTIFIED AND LABELED AS CONFORMING TO THE REQUIREMENTS OF ASTM D 3679 BY AN APPROVED QUALITY CONTROL AGENCY.
- 2. VINYL SIDING, SOFFIT, AND ACCESSORIES SHALL BE INSTALLED IN ACCORDANCE WITH THE MANUFACTURER'S INSTALLATION INSTRUCTIONS.
- 3. SOFFIT PANELS SHALL BE INDIVIDUALLY FASTENED TO A SUPPORTING COMPONENT SUCH AS A NAILING STRIP, FASCIA, OR SUBFASCIA COMPONENT, OR AS SPECIFIED BY THE MANUFACTURER.

ASPHALT SHINGLES

- SHINGLE PACKAGING SHALL BEAR A LABEL TO INDICATE COMPLIANCE TO:
- ASPHALT SHINGLES SHALL BE TESTED IN ACCORDANCE WITH ASTM D 7158. SHINGLES SHALL MEET THE CLASSIFICATION REQUIREMENTS FOR THE APPROPRIATE MAXIMUM BASIC WIND SPEED:

G OR H

GORH

MAXIMUM BASIC WIND SPEED CLASSIFICATION REQUIREMENT PER ASTM D 7158 D, G OR H 100 MPH

STRUCTURAL LUMBER

- JOISTS, BEAMS, RAFTERS, AND 2 x 6 STUDS ARE TO BE A MINIMUM GRADE OF SPRUCE-PINE-FIR (SOUTH) NO. 2, WITH THE FOLLOWING MINIMUM PROPERTIES
 - FB = 750 PSI FV = 70 PSI
 - FC = 335 PSI (PERPENDICULAR) FC = 975 PSI (PARALLEL)
 - E = 1,000,000 PSI
 - 2. 2 x 4 STUDS, UNLESS NOTED OTHERWISE, ARE TO BE A MINIMUM GRADE OF HEM-FIR STUD GRADE, WITH THE
 - FOLLOWING MINIMUM PROPERTIES: FB = 675 PSI FT
 - FV = 75 PSI
 - FC = 405 PSI (PERPENDICULAR) FC = 800 PSI
 - E = 1,200,000 PSI 3. LAMINATED VENEER LUMBER (LVL) SHALL BE "I.9 E MICROLAM LVL" AS MANUFACTURED BY TRUS JOIST MACMILLAN
 - (OR EQUAL), WITH THE FOLLOWING DESIGN PROPERTIES: FB = 2,800 PSI (SINGLE 12" MEMBER) FV = 285 PSI
 - FC = 750 PSI (PERPENDICULAR) FC = 2000 PSI (PARALLEL TO GRAIN)
 - E = 1,900,000 PSI 4. UNLESS SPECIFICALLY SHOWN OTHERWISE, DESIGN, FABRICATION AND ERECTION SHALL BE GOVERNED BY THE
 - NATIONAL DESIGN SPECIFICATION FOR WOOD CONSTRUCTION PRODUCT STANDARD PS-I-83 FOR CONSTRUCTION AND INDUSTRIAL PLYWOOD
 - APA PRP-108 FOR STRUCTURAL USE PANELS, OR PS 2-92 FOR WOOD-BASED STRUCTURAL USE PANELS APA RESIDENTIAL CONSTRUCTION GUIDE
 - 5. TRUSSES, STRUCTURAL COMPOSITE LUMBER, STRUCTURAL GLUE-LAMINATED MEMBERS, AND 1-JOISTS SHALL BE SUPPORTED LATERALLY AS REQUIRED BY THE MANUFACTURER. 6. ANY DRILLING OR NOTCHING OF THE WALL DOUBLE TOP PLATES SHALL BE IN COMPLIANCE WITH THE BUILDING CODE.

- USE ONE LINE OF SOLID BLOCKING OR CROSS BRIDGING AT 8'-O" O/C FOR CEILING JOISTS. USE SOLID BLOCKING
- 2. USE ONE CRIPPLE STUD AND ONE FULL HEIGHT STUD UNDER BEAM AND HEADER BEARING LESS THAN 4'-O AND ONE CRIPPLE STUD AND TWO FULL HEIGHT STUDS UNDER BEAM AND HEADER BEARING 4'-O OR GREATER, UNLESS SHOWN
- 3. APPLY CONTINUOUS BEAD OF GLUE ON JOISTS AND GROOVE OF TONGUE-AND-GROOVE PANELS.
- 4. BUILDING ENVELOPE AIR TIGHTNESS AND INSULATION INSTALLATION SHALL BE DEMONSTRATED TO COMPLY WITH ONE TESTING OPTION: TESTED AIR LEAKAGE WITH A BLOWER DOOR TEST
- 5. FRAMING LUMBER IN CONTACT WITH CONCRETE OR MASONRY, OR EXPOSED TO THE EXTERIOR SHALL BE PRESERVATIVE PRESSURE TREATED.

B. VISUAL INSPECTION OPTION: INSPECTION OF ITEMS LISTED IN TABLE 1102.4.2.

(SEE MECHANICAL DRAWINGS FOR ADDITIONAL INFORMATION)

- 6. ANY WOOD, INCLUDING EXTERIOR SHEATHING, WITHIN 6" OF FINISHED GRADE SHALL BE PRESERVATIVE-PRESSURE
- 7. WALL COVERINGS, BACKING MATERIALS, AND THEIR ATTACHMENTS SHALL BE CAPABLE OF RESISTING WIND LOADS IN ACCORDANCE WITH THE FOLLOWING TABLES: A. SEISMIC DESIGN CATEGORIES
 - B. WEATHERING PROBABILITY MAP FOR CONCRETE
- 7. AN APPROVED WATER-RESISTIVE BARRIER SHALL BE APPLIED OVER SHEATHING OF ALL EXTERIOR WALLS. SUCH MATERIAL SHALL BE APPLIED HORIZONTALLY, WITH THE UPPER LAYER LAPPED OVER THE LOWER LAYER NOT LESS THAN 2". WHERE JOINTS OCCUR, BARRIER SHALL BE LAPPED NOT LESS THAN 6". THE BARRIER SHALL BE CONTINUOUS TO THE TOP OF THE WALL, AND TERMINATED AT PENETRATIONS AND BUILDING APPENDAGES IN A MANNER TO MEET THE REQUIREMENTS OF THE EXTERIOR WALL ENVELOPE.

- I. ANCHOR BOLTS AND OTHER BOLTS EXCEPT AS MAY BE NOTED: ASTM A307.
- 2. STRUCTURAL STEEL TO BE ASTM A36 WITH A SHOP COAT OF RUST-INHIBITIVE PAINT, EXCEPT FOR CORROSION-RESISTANT STEEL, AND STEEL TREATED WITH COATINGS TO PROVIDE CORROSION RESISTANCE.
- 3. STEEL BELOW GRADE TO BE PROTECTED BY A MINIMUM OF 3" OF CONCRETE OR 4" OF MASONRY
- 4. COLUMNS SHALL BE RESTRAINED TO PREVENT LATERAL DISPLACEMENT AT THE BOTTOM END. COLUMNS SHALL NOT BE LESS THAN 3" DIAMETER, SCHEDULE 40 PIPE, MANUFACTURED IN ACCORDANCE WITH ASTM A 53 GRADE B, OR APPROVED EQUIVALENT.
- 5. STEEL LINTELS SHALL BE SHOP COATED WITH A RUST-INHIBITIVE PAINT, EXCEPT FOR LINTELS MADE OF CORROSION-RESISTANT STEEL, OR STEEL TREATED WITH COATINGS TO PROVIDE CORROSION RESISTANCE. THE ALLOMABLE SPAN SHALL NOT EXCEED THE FOLLOWING VALUES, WITH THE LONG LEG OF THE ANGLE IN THE VERTICAL

ANGLE SIZE	NO STORY ABOVE	ONE STORY ABOV
3" X 3" X I/4"	6'-0"	4'-6"
4" X 3" X I/4"	8'-0"	6'-0"
5" X 3-1/2" X 5/16"	10'-0"	8'-0"
6" X 3-1/2" X 5/16"	l4"-0"	9'-6"

- CONNECTIONS & FASTENERS JOISTS TO BEAMS OR JOISTS TO TRUSSES - 16 GA. STD. JOIST HANGERS, UNLESS SHOWN OTHERWISE - AS MANUFACTURED BY SIMPSON STRONG TIE.
- 2. ROOF TRUSSES TO SUPPORTING TOP PLATES OR BEAMS USE HURRICANE TIES, EQUAL TO SIMPSON H3, WITH ALL NAIL HOLES FILLED; ONE PER TRUSS END.
- 3. ROOF SHEATHING TO JOISTS/TRUSSES:- USE &D NAILS AT 6" O/C AT PANEL EDGES AND 12" O/C AT INTERMEDIATE
- 4. FASTENERS AND CONNECTORS IN CONTACT WITH PRESERVATIVE-TREATED WOOD AND FIRE-RETARDANT-TREATED MOOD SHALL BE OF: HOT DIPPED ZING-COATED GALVANIZED STEEL
- STAINLESS STEEL SILICON BRONZE COPPER


DEAD LOAD:

- I. LUMBER AS REQUIRED BY THE TRUSS MANUFACTURER, MINIMUM GRADE TO BE SYP NO. 2, KD 15 PERCENT MC.
- 2. CONNECTIONS: ALL INTERNAL TRUSS CONNECTIONS ARE TO BE DESIGNED BY THE TRUSS MANUFACTURER. CONNECTORS SHALL BE DEFORMED PLATE TYPE, OF MINIMUM 20 GAUGE GALVANIZED STEEL SHEET. ALL JOINTS ARE TO BE DESIGNED USING METHODS AS SET FORTH IN TPI STANDARDS 1976.
- 3. HANGERS: ALL TRUSS TO TRUSS HANGERS ARE TO BE DESIGNED AND SUPPLIED BY THE TRUSS SUPPLIER.
- 4. SPECIFICATIONS AND REFERENCE STANDARDS: UNLESS SPECIFICALLY SHOWN OTHERWISE, DESIGN, FABRICATION, ERECTION, HANDLING AND BRAGING REQUIREMENTS ARE TO BE GOVERNED BY THE LATEST REVISIONS OF: NATIONAL DESIGN SPECIFICATIONS FOR STRESS-GRADE LUMBER AND ITS FASTENINGS TIMBER CONSTRUCTION STANDARDS DESIGN SPECIFICATIONS FOR LIGHT METAL PLATE CONNECTED WOOD TRUSSES
- COMMENTARY AND RECOMMENDATIONS 5. ALL TRUSSES ARE TO BE DESIGNED BY THE TRUSS MANUFACTURER FOR THE FOLLOWING LOADS: TOP CHORD LIVE LOAD: 25 PSF (GROUND SNOW)

TRUSS PLATE INSTITUTE PUBLICATION-BTW BRACING WOOD TRUSSES:


TRUSS DESIGN DRAWINGS SHALL BE STAMPED BY A REGISTERED ENGINEER


- BOTTOM CHORD LIVE LOAD: 10 PSF 6. WHERE TRUSSES ARE REQUIRED TO FRAME INTO OTHER TRUSSES, THE DESIGN OF THE HANGERS SHALL BE THE RESPONSIBILITY OF THE TRUSS SUPPLIER. THIS IS TO INCLUDE THE DESIGN OF THE HANGERS AND PROVISION IN THE
- SUPPORTING TRUSS TO ACCEPT THE TYPE OF HANGER PROVIDED. 7. TRUSS DESIGNS ARE TO BE SUBMITTED FOR REVIEW PRIOR TO FABRICATION. TRUSS SUBMITTAL SHALL INCLUDE THE FOLLOWING INFORMATION: DESIGN INFORMATION FOR EACH TYPE OF TRUSS SUPPLIED TRUSS HANGER TYPE AND LOCATION, FOR ALL TRUSSES FRAMING INTO TRUSSES
- 8. ALL MEMBERS OF MULTIPLE TRUSSES ARE TO BE NAILED TOGETHER WITH IOD COMMON NAILS AT 8" O.C., FOR DOUBLE TRUSSES, OR WITH 16D COMMON NAILS AT 8" O.C. FROM EACH SIDE, FOR TRIPLE TRUSSES.

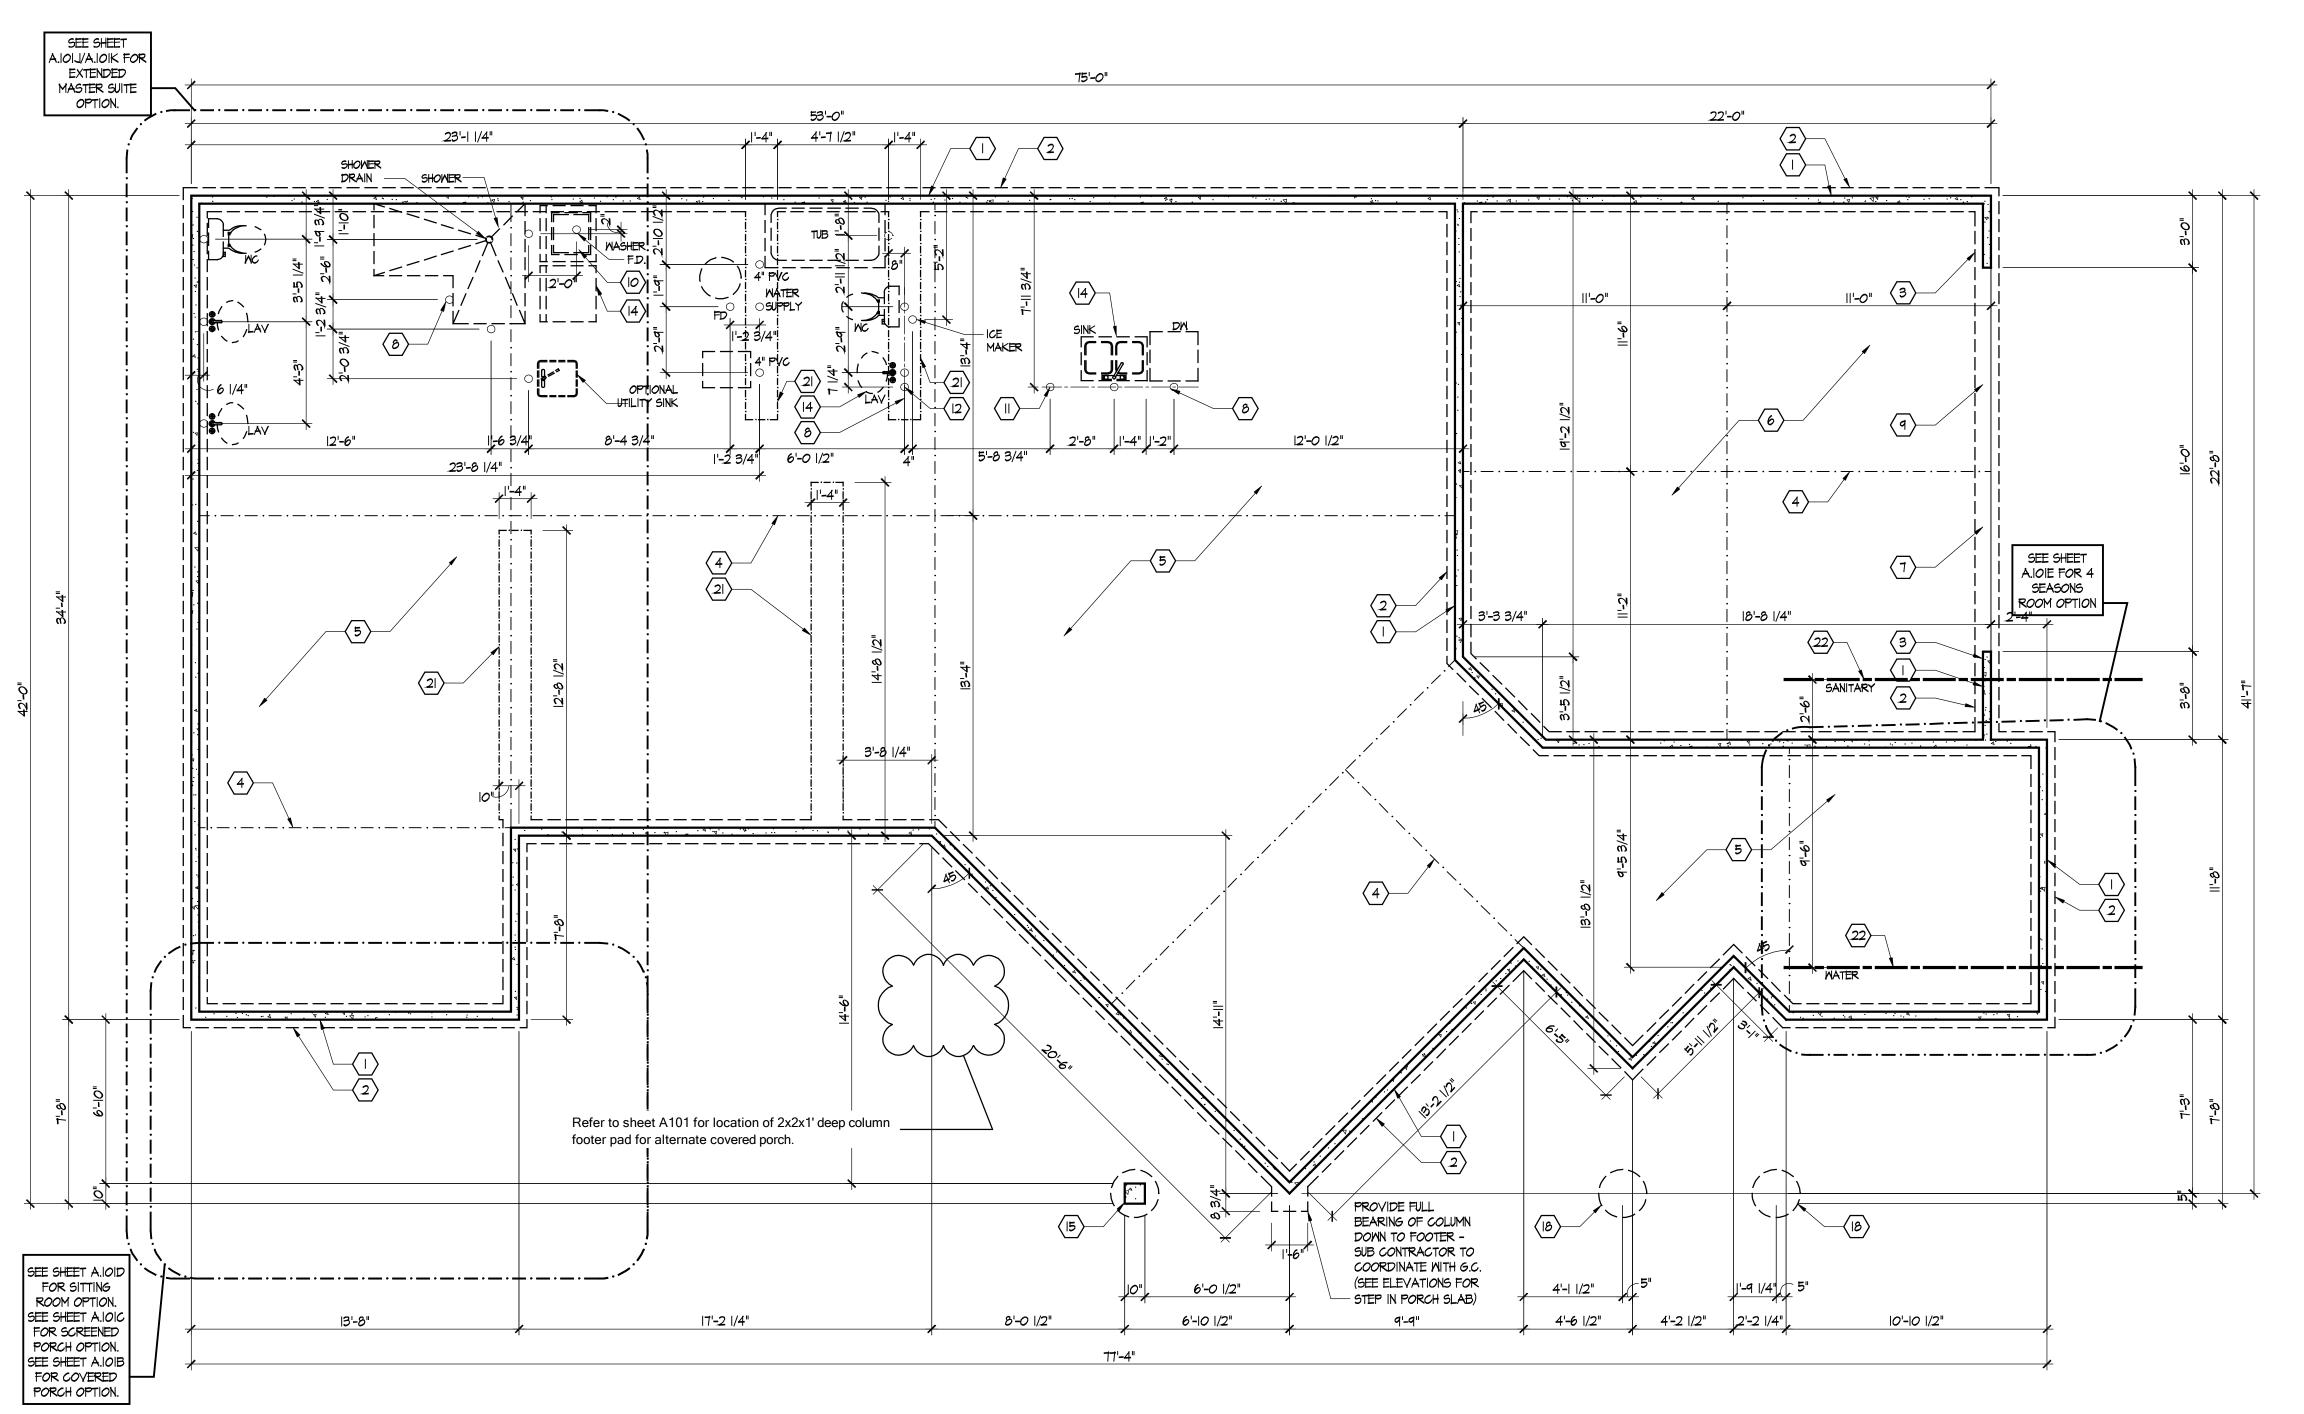

Foundation Plan

Scale: 1/4" = 1'-0"

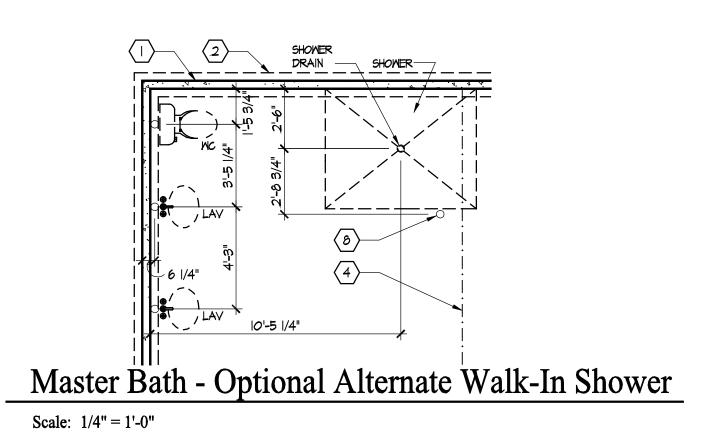

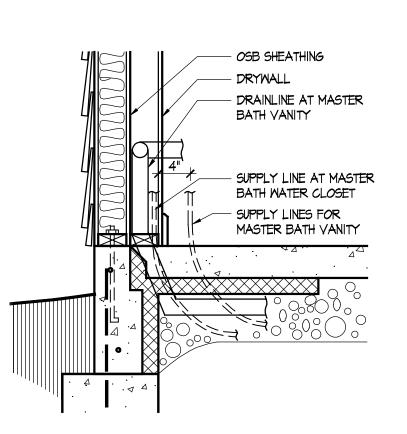

Master Bath Plumbing Detail - Vanity/W.C.

Scale: 1/4" = 1'-0"

FOUNDATION CODED NOTES (FOUNDATION PLAN ONLY)

(ALL NOTES NOT APPLICABLE TO ALL SHEETS)

- POURED CONCRETE FOUNDATION STEM WALL (TYPICAL) SEE WALL SECTIONS SHEETS.
- 2. I2" WIDE CONCRETE FOOTING WITH STEEL BAR REINFORCING AS REQUIRED BY SOILS ENGINEER MAINTAIN BOTTOM OF FOOTING A MINIMUM 30" BELOW FINISH GRADE AND TOP OF FOOTING SET I2" BELOW FINISHED FLOOR TYPICAL.
- 3. PROVIDE MIN. 2 ANCHOR BOLTS EACH SIDE OF GARAGE DOORS.
- 4. SAW CUT CONTROL JOINT IN CONCRETE SLAB, 1/8" WIDE \times 1/4 DEEP TYPICAL.
- 5. 4" POURED CONCRETE FLOOR SLAB OVER 4 MIL.
 POLYETHYLENE VAPOR BARRIER AND 4" GRAVEL BASE TYPICAL.
- 4" GLASS FIBER REINFORCED CONCRETE FLOOR SLAB OVER
 4" GRAVEL BASE TYPICAL IN GARAGES.
- 7. PROVIDE WEATHERLIP @ GARAGE DOOR OPENING SEE DETAIL D, SHEET A.301.
- 8. PIPE LOCATION CENTERED ON WALL ABOVE.
- 9. NO STEM WALL AT GARAGE DOOR OPENINGS.
- IO. WASHER ALWAYS LOCATED LEFT OF DRYER.
- II. ELECTRICAL CONDUIT UNDER SLAB FOR ELECTRICAL OUTLET AT KITCHEN ISLAND.
- 12. ELECTRICAL CONDUIT SLAB PENETRATION.
- 13. NOT USED.
- 14. DASHED LINES INDICATE LOCATION OF PLUMBING FIXTURES ABOVE - SHOWN FOR REFERENCE ONLY.
- 15. IO" WIDE \times IO" DEEP CONCRETE PIER WITH 24" DIA. FOOTING. MAINTAIN BOTTOM OF FOOTING A MINIMUM 30" BELOW FINISH GRADE AND TOP OF PIER SET 6" BELOW FINISHED FLOOR.
- 16. DOTTED LINE INDICATES WALL LINE OF BASE UNIT.
- 17. 8" DEEP X 16" WIDE THICKENED SLAB WITH (2) NO. 4 REBAR CONTINUOUS.
- 18. 24" DIA. FOOTING MAINTAIN BOTTOM OF FOOTING A MINIMUM 30" BELOW FINISH GRADE.
- 19. 12" DEEP CONCRETE FOOTING WITH (2) NO. 5 REBAR EACH WAY - SEE PLANS FOR SIZE - MAINTAIN BOTTOM OF FOOTING A MINIMUM 30" BELOW FINISH GRADE. 12" THICKENED SLAB EDGE TO CONTINUE DOWN TO FOOTING.
- 20. 24" WIDE CONCRETE FOOTING WITH STEEL BAR REINFORCING AS REQUIRED BY SOILS ENGINEER MAINTAIN BOTTOM OF FOOTING A MINIMUM 30" BELOW FINISH GRADE AND TOP OF FOOTING SET 12" BELOW FINISHED FLOOR.
- 21. 12" DEEP \times 16" WIDE THICKENED SLAB WITH (2) NO. 4 REBAR CONTINUOUS. TYPICAL UNDER ALL INTERIOR SHEAR WALLS.
- 22. PLUMBER TO PROVIDE 4" PVC SLEEVE FOR WATER AND 4" SANITARY LINE FOR INSTALLATION BY FOOTER CONTRACTOR.

GENERAL FOUNDATION NOTES

I. SOIL BEARING CAPACITY ASSUMED TO BE 2500 PSF AND SHALL BE VERIFIED BY SOILS ENGINEER PRIOR TO PLACEMENT OF BUILDING FOUNDATION. CONSULT ARCHITECT WHEN INADEQUATE SOIL CAPACITIES ARE FOUND.

2. ALL DIMENSIONS ARE TO FACE OF FOUNDATION / BASEMENT WALL UNLESS NOTED OTHERWISE.

3. HOLD DOWN TOP OF FOUNDATION WALL 8" AT ALL ENTRY DOORS TO ALLOW FOR EXTENSION OF FLOOR SLAB UNDER THE DOOR THRESHOLDS.

4. PLUMBING CONTRACTOR TO USE ROUND BUCKETS FOR FORMED SLAB PENETRATIONS.

5. CONCRETE CONTRACTOR TO INSTALL 1/2" EXP. JT. AROUND THE PERIMETER OF GARAGES.

6. CONCRETE CONTRACTOR COORDINATE WITH PLUMBING FOR LOCATION OF BLOCKOUTS FOR UNDERSLAB LINES.

7. CONCRETE CONTRACTOR - SEE FIRST FLOOR PLAN FOR SIDEWALKS AND PATIOS.

8. CONCRETE CONTRACTOR TO VERIFY SLAB PENETRATION AT TUB/SHOWER OPTIONS.

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THESE DRAWINGS SHALL BE USED IN CONFORMANCE WITH ALL LOCAL BUILDING, MECHANICAL, PLUMBING AND ELECTRICAL CODES AND SHALL MEET THE REQUIREMENTS OF THE HEALTH DEPARTMENT, FIRE MARSHALL, AMERICANS WITH DISABILITIES ACT ACCESSIBILITY GUIDELINES (ADAAG), THE FAIR HOUSING ACT ACCESSIBILITY GUIDELINES (FHAAG), AND SHALL BE CONSTRUCTED IN CONFORMANCE WITH STATE AND LOCAL ENERGY REQUIREMENTS.

Prototype	Interim Pag	e Revisions
Disk No.	Revision	Date
		8/1/10

Architect Project Number 2010-005


Community Dates & Revisions
Date Originated 1 FEB 2015
Bid
Permit
Construction
Revisions

Drawing Title

Foundation Plan

Architectural Style
European Country

A.100 D3M - 2010

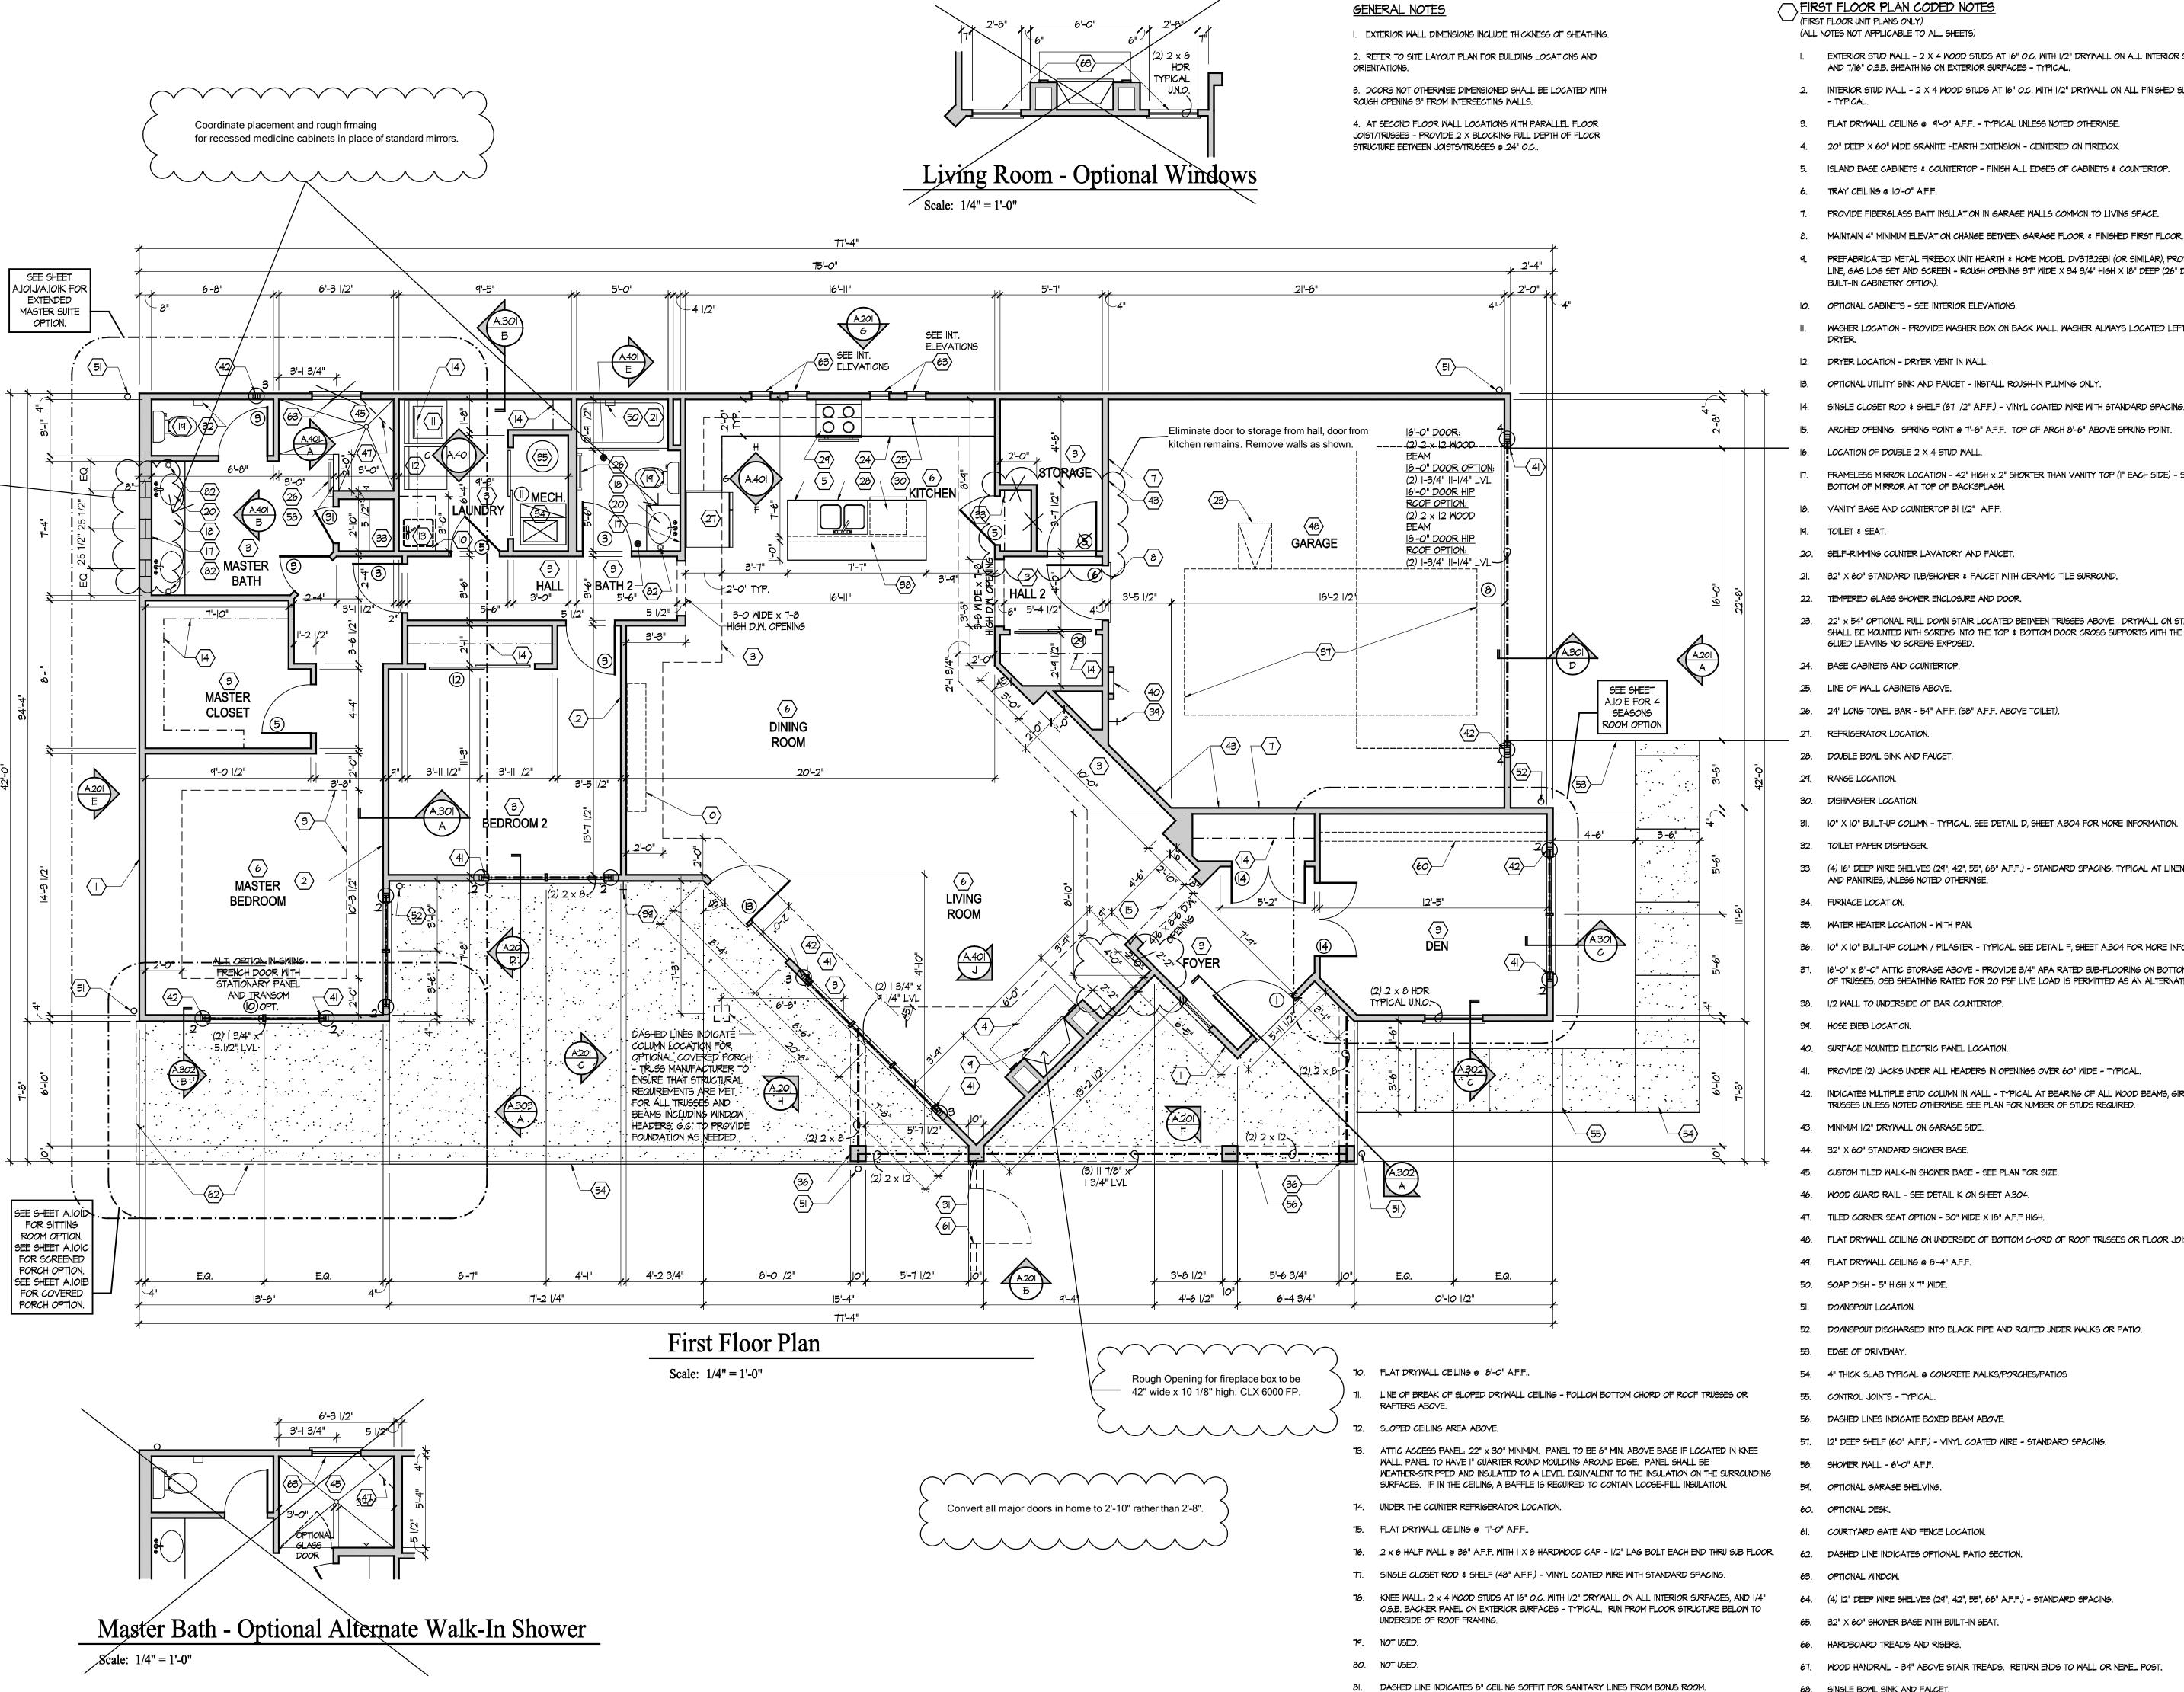

<u>, FIRST FLOOR PLAN CODED NOTES</u>

(ALL NOTES NOT APPLICABLE TO ALL SHEETS)

- 1. EXTERIOR STUD WALL 2 X 4 MOOD STUDS AT 16" O.C. WITH 1/2" DRYWALL ON ALL INTERIOR SURFACES AND 7/16" O.S.B. SHEATHING ON EXTERIOR SURFACES - TYPICAL.
- 2. INTERIOR STUD WALL 2 X 4 WOOD STUDS AT 16" O.C. WITH 1/2" DRYWALL ON ALL FINISHED SURFACES
- 3. FLAT DRYWALL CEILING @ 9'-0" A.F.F. TYPICAL UNLESS NOTED OTHERWISE.

- PROVIDE FIBERGLASS BATT INSULATION IN GARAGE WALLS COMMON TO LIVING SPACE.
- MAINTAIN 4" MINIMUM ELEVATION CHANGE BETWEEN GARAGE FLOOR & FINISHED FIRST FLOOR.
- PREFABRICATED METAL FIREBOX UNIT HEARTH & HOME MODEL DV3T329BI (OR SIMILAR), PROVIDE GAS LINE, GAS LOG SET AND SCREEN - ROUGH OPENING 37" WIDE X 34 3/4" HIGH X 18" DEEP (26" DEEP WITH
- 10. OPTIONAL CABINETS SEE INTERIOR ELEVATIONS.
- WASHER LOCATION PROVIDE WASHER BOX ON BACK WALL. WASHER ALWAYS LOCATED LEFT OF

- 15. ARCHED OPENING. SPRING POINT @ 7'-8" A.F.F. TOP OF ARCH 8'-6" ABOVE SPRING POINT.
- 16. LOCATION OF DOUBLE 2 X 4 STUD WALL.
 - FRAMELESS MIRROR LOCATION 42" HIGH \times 2" SHORTER THAN VANITY TOP (I" EACH SIDE) SET

- 20. SELF-RIMMING COUNTER LAVATORY AND FAUCET.
- 21. 32" X 60" STANDARD TUB/SHOWER & FAUCET WITH CERAMIC TILE SURROUND.
- 22. TEMPERED GLASS SHOWER ENCLOSURE AND DOOR.
- 23. 22" x 54" OPTIONAL PULL DOWN STAIR LOCATED BETWEEN TRUSSES ABOVE. DRYWALL ON STAIR SHALL BE MOUNTED WITH SCREWS INTO THE TOP & BOTTOM DOOR CROSS SUPPORTS WITH THE CENTER GLUED LEAVING NO SCREMS EXPOSED.
- 24. BASE CABINETS AND COUNTERTOP
- 26. 24" LONG TOWEL BAR 54" A.F.F. (58" A.F.F. ABOVE TOILET)

- 31. IO" X IO" BUILT-UP COLUMN TYPICAL. SEE DETAIL D, SHEET A.304 FOR MORE INFORMATION.
- 33. (4) 16" DEEP WIRE SHELVES (29", 42", 55", 68" A.F.F.) STANDARD SPACING. TYPICAL AT LINEN CLOSETS
- 35. WATER HEATER LOCATION WITH PAN.
- 36. IO" X IO" BUILT-UP COLUMN / PILASTER TYPICAL. SEE DETAIL F, SHEET A.304 FOR MORE INFORMATION.
- 37. I6'-O" x 8"-O" ATTIC STORAGE ABOVE PROVIDE 3/4" APA RATED SUB-FLOORING ON BOTTOM CHORD OF TRUSSES. OSB SHEATHING RATED FOR 20 PSF LIVE LOAD IS PERMITTED AS AN ALTERNATE.
- 38. I/2 WALL TO UNDERSIDE OF BAR COUNTERTOP.
- 40. SURFACE MOUNTED ELECTRIC PANEL LOCATION.
- 41. PROVIDE (2) JACKS UNDER ALL HEADERS IN OPENINGS OVER 60" WIDE TYPICAL.
- 42. INDICATES MULTIPLE STUD COLUMN IN WALL TYPICAL AT BEARING OF ALL WOOD BEAMS, GIRDER TRUSSES UNLESS NOTED OTHERWISE. SEE PLAN FOR NUMBER OF STUDS REQUIRED.
- 43. MINIMUM 1/2" DRYWALL ON GARAGE SIDE.
- 45. CUSTOM TILED WALK-IN SHOWER BASE SEE PLAN FOR SIZE.
- 46. WOOD GUARD RAIL SEE DETAIL K ON SHEET A.304.
- 47. TILED CORNER SEAT OPTION 30" WIDE X 18" A.F.F HIGH.
- 48. FLAT DRYWALL CEILING ON UNDERSIDE OF BOTTOM CHORD OF ROOF TRUSSES OR FLOOR JOISTS.
- 49. FLAT DRYWALL CEILING @ 8'-4" A.F.F.
- 50. SOAP DISH 5" HIGH X 7" WIDE.
- 52. DOWNSPOUT DISCHARGED INTO BLACK PIPE AND ROUTED UNDER WALKS OR PATIO.
- 54. 4" THICK SLAB TYPICAL @ CONCRETE WALKS/PORCHES/PATIOS
- 55. CONTROL JOINTS TYPICAL.
- 56. DASHED LINES INDICATE BOXED BEAM ABOVE.
- 57. I2" DEEP SHELF (60" A.F.F.) VINYL COATED WIRE STANDARD SPACING.
- 58. SHOWER WALL 6'-0" A.F.F.
- 59. OPTIONAL GARAGE SHELVING.
- 61. COURTYARD GATE AND FENCE LOCATION.

- 64. (4) 12" DEEP WIRE SHELVES (29", 42", 55", 68" A.F.F.) STANDARD SPACING.
- 65. 32" X 60" SHOWER BASE WITH BUILT-IN SEAT.
- 66. HARDBOARD TREADS AND RISERS.
- 67. WOOD HANDRAIL 34" ABOVE STAIR TREADS. RETURN ENDS TO WALL OR NEWEL POST.
- 68. SINGLE BOWL SINK AND FAUCET.
- 69. 20" RANGE LOCATION.

82. TOWEL RING.

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EPCON

Communities

Where Life Comes Together

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Prototype	Interim Page Revisions			
Disk No.	Revision	Date		
		2/17/12		

Architect Project Number 2010-005


Community Dates & Revisions Date Originated 1 FEB 2015 Permit


Construction Revisions

Drawing Title First Floor Plan

Architectural Style **European Country**


Sheet Number A.101 D3M - 2010

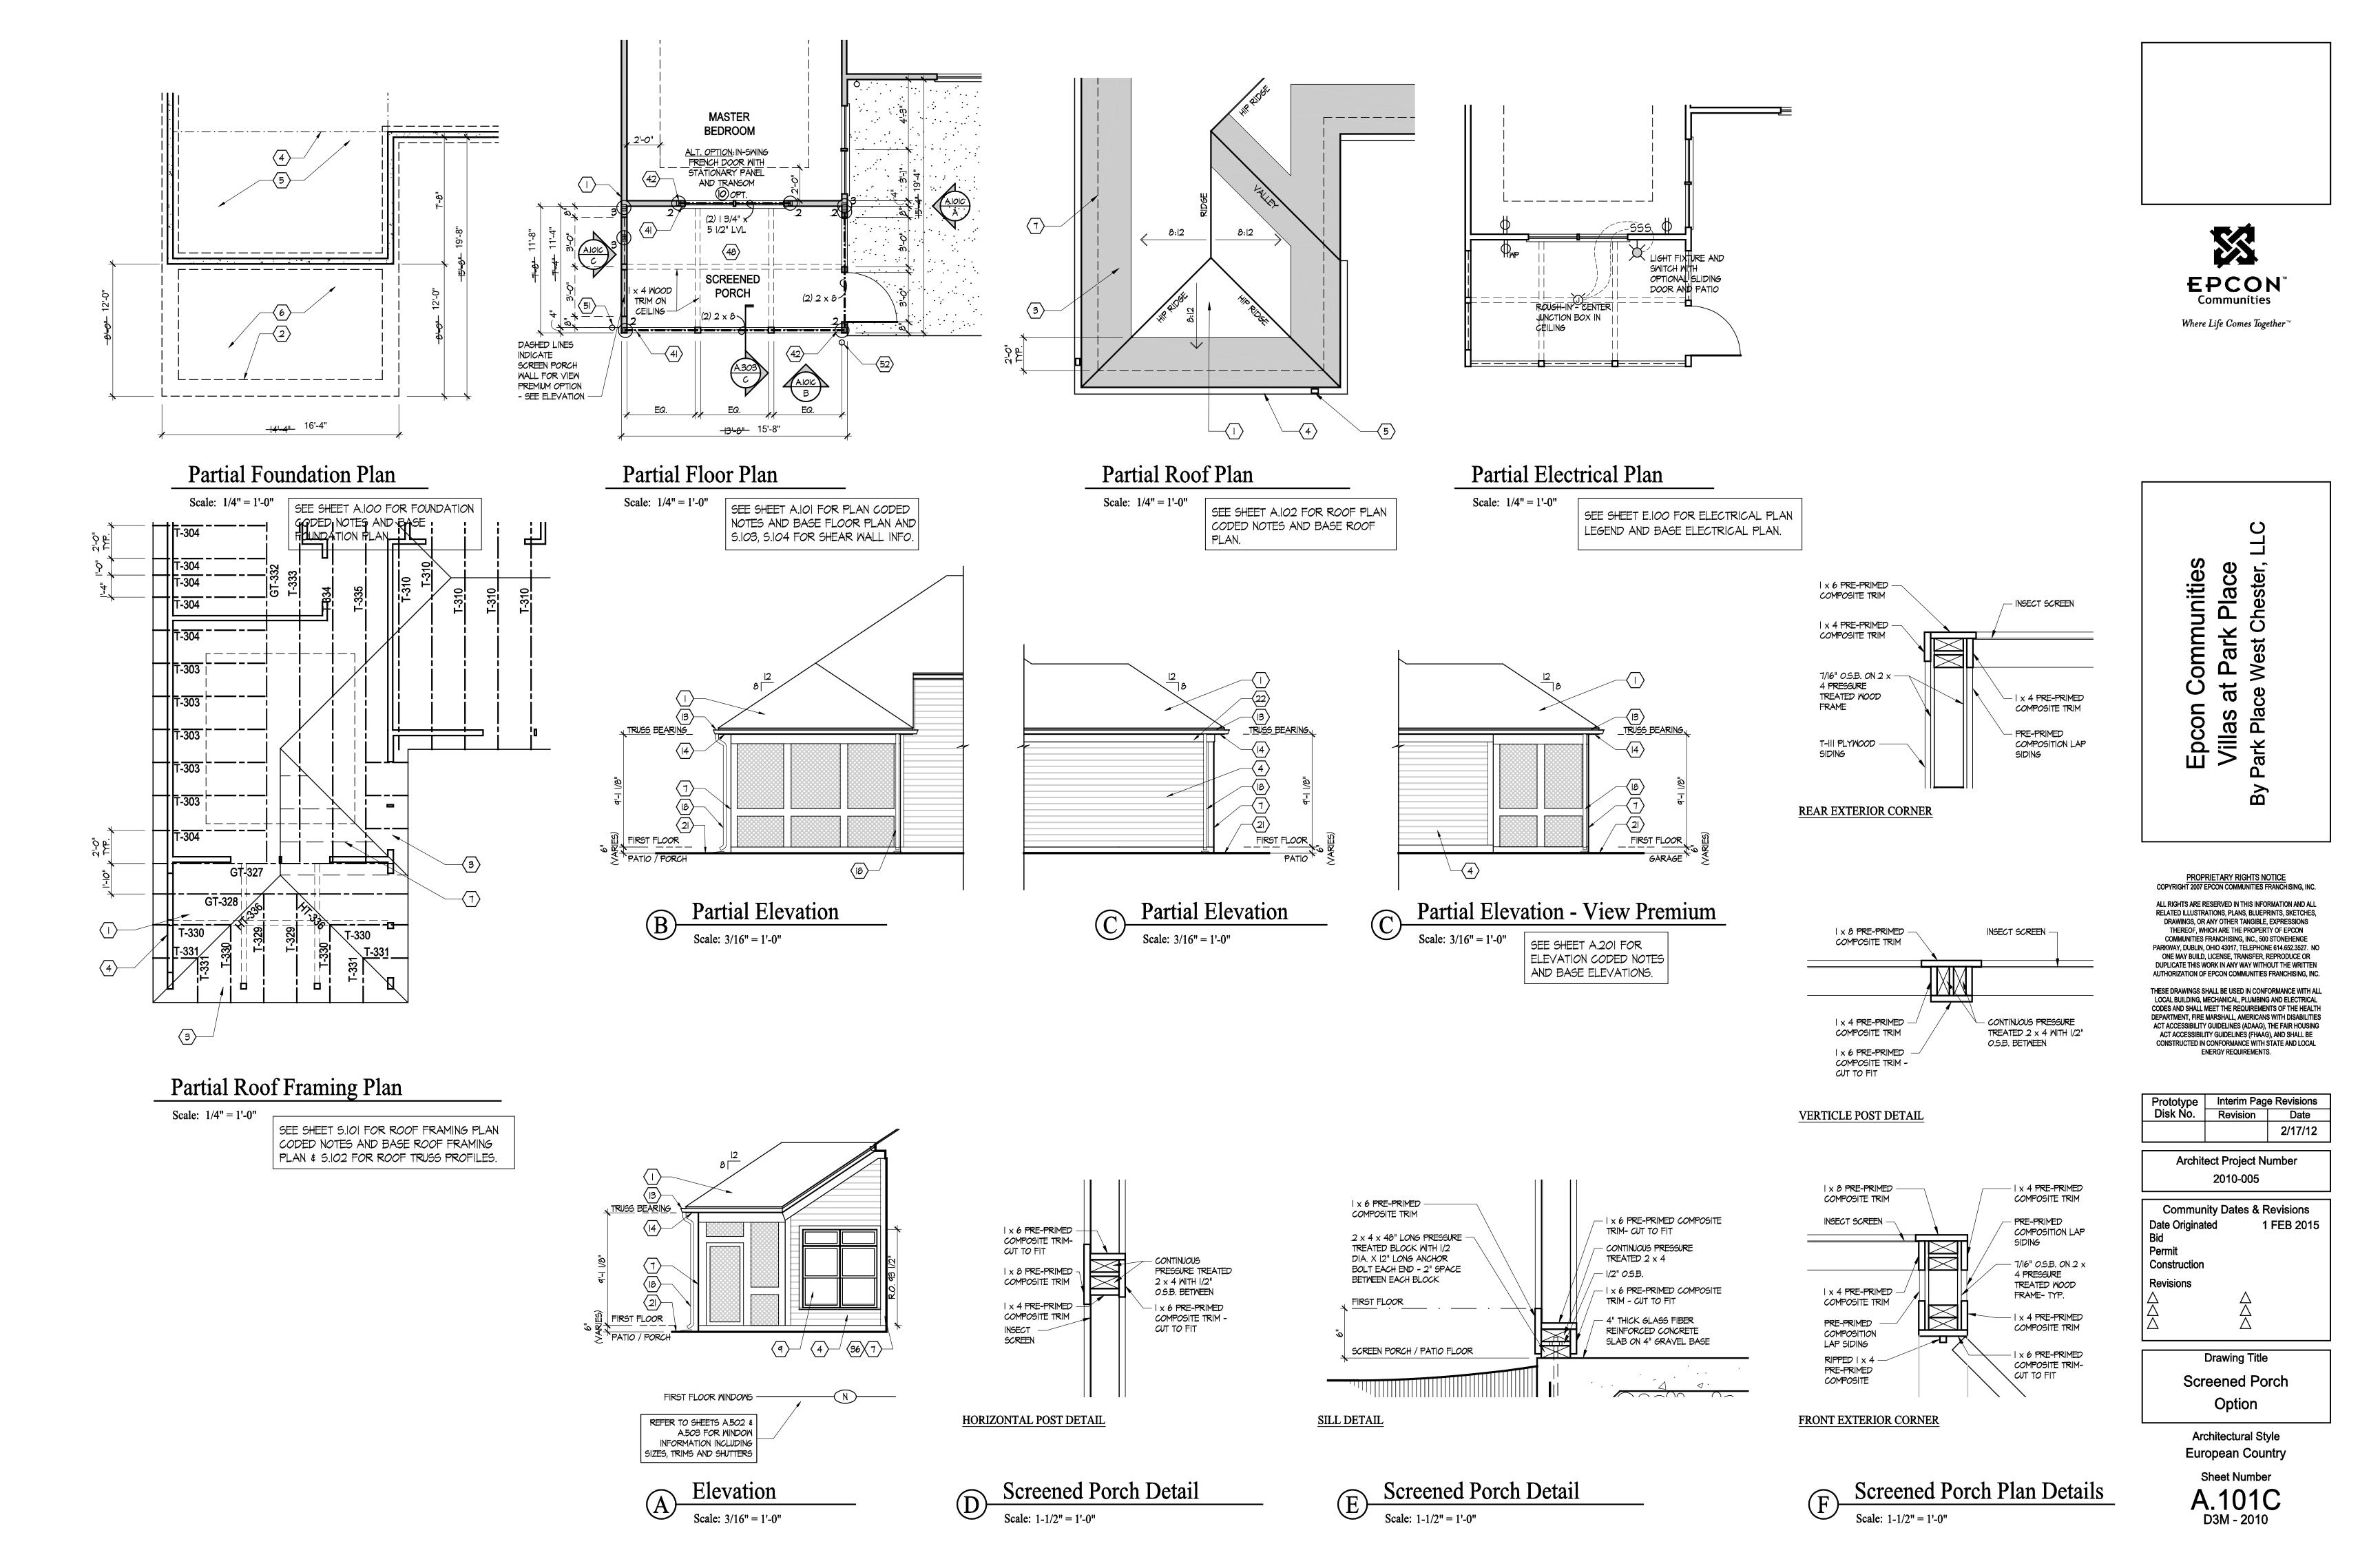

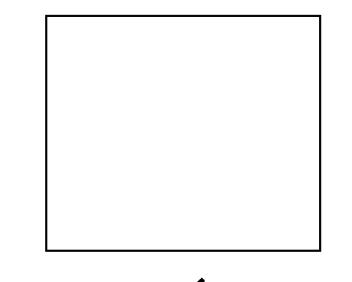



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Roof Plan

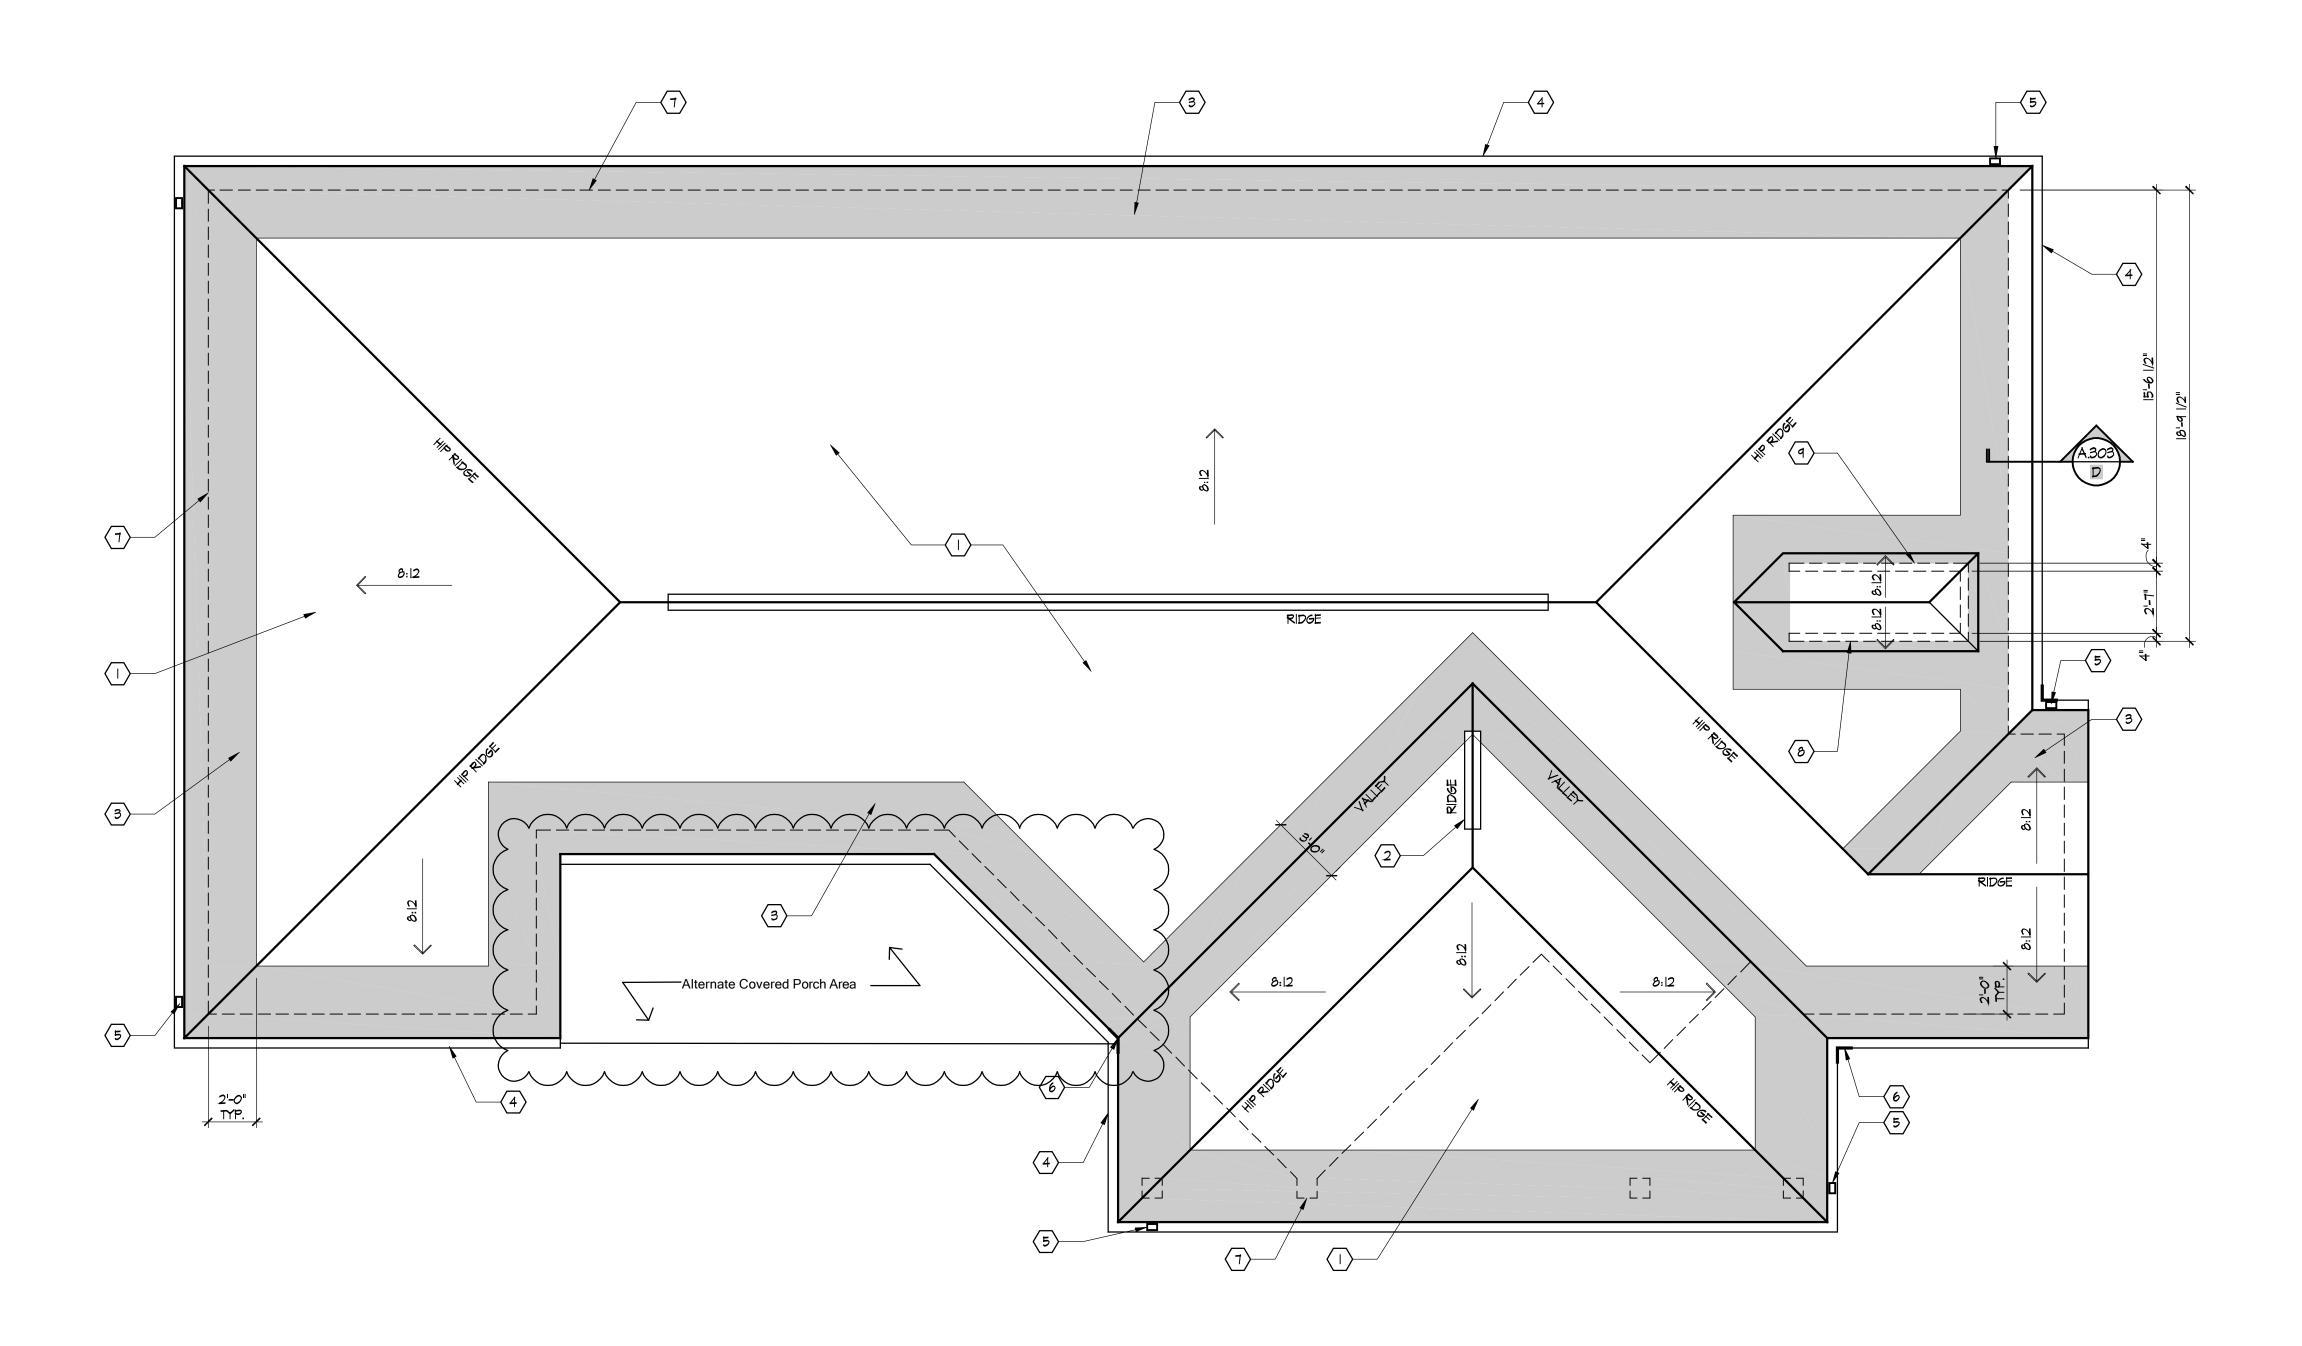Scale: 1/4" = 1'-0"

SEE SHEET A.IO2 FOR ROOF PLAN
CODED NOTES AND BASE ROOF
PLAN.

Epcon Communities Villas at Park Place By Park Place West Chester, LLC

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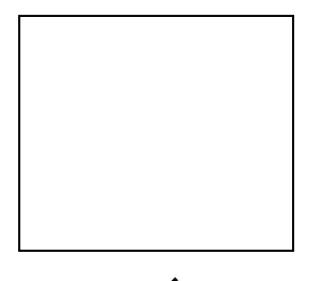
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Roof Plan

Alternate


Architectural Style
European Country

Sheet Number
A.101F







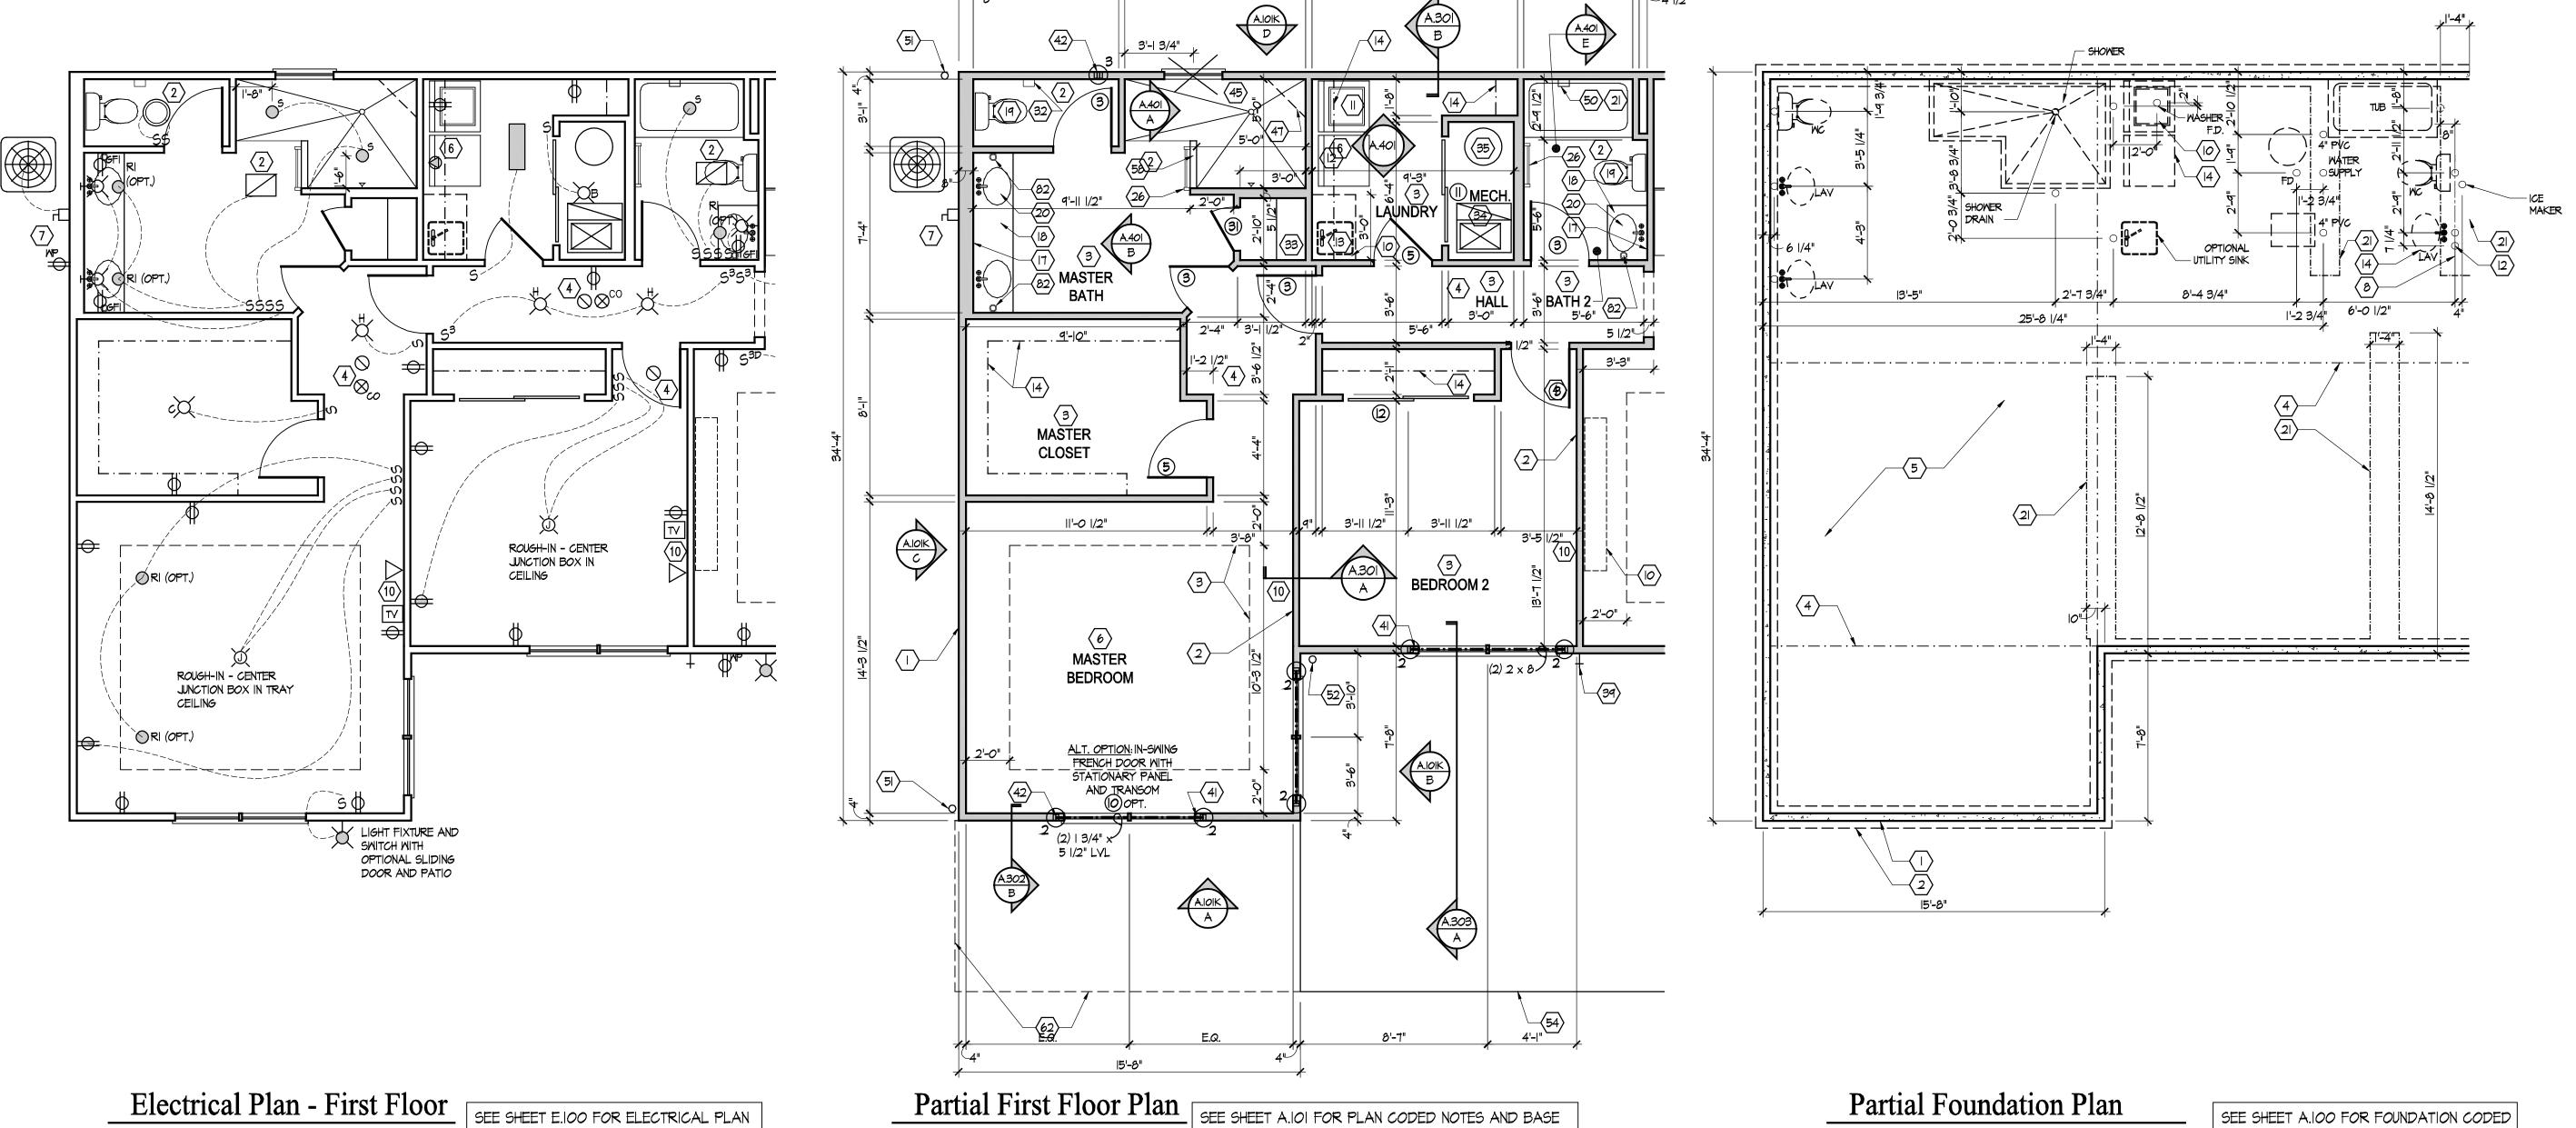

FLOOR PLAN AND S.103, S.104 FOR SHEAR WALL INFO.

LEGEND AND BASE ELECTRICAL PLAN.

Scale: 1/4'' = 1'-0''

Scale: 1/4" = 1'-0"

Communities Place West Chester, at Park Place Villas

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Architect Project Number 2010-005

Community Dates & Revisions Date Originated 1 FEB 2015 Permit Construction Revisions

> Drawing Title **Deluxe Master Suite** Plans and Electrical


Architectural Style **European Country**


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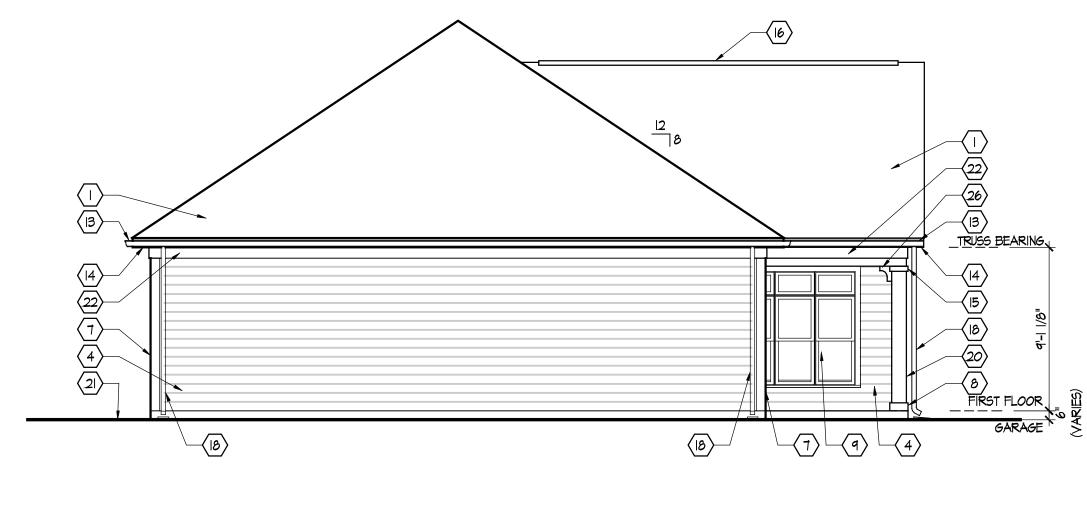
SEE SHEET A.100 FOR FOUNDATION CODED


NOTES AND BASE FOUNDATION PLAN.

Scale: 1/4" = 1'-0"



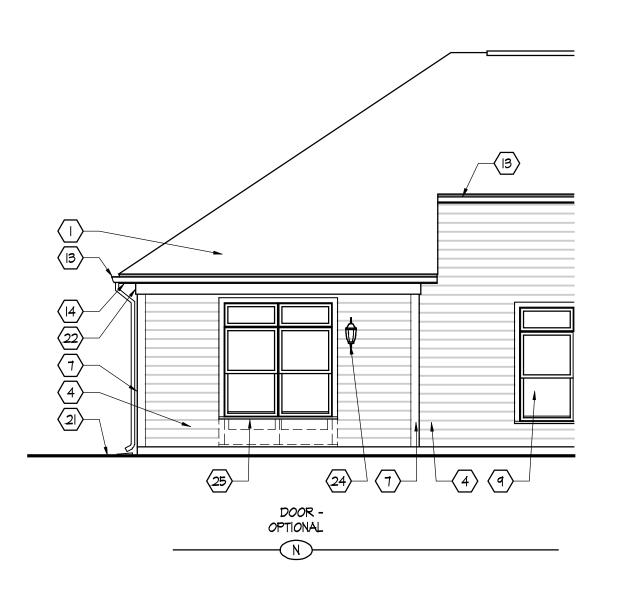

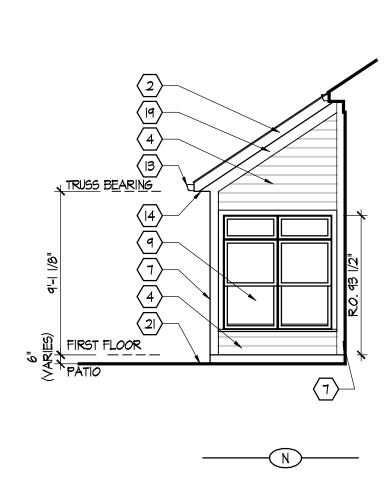

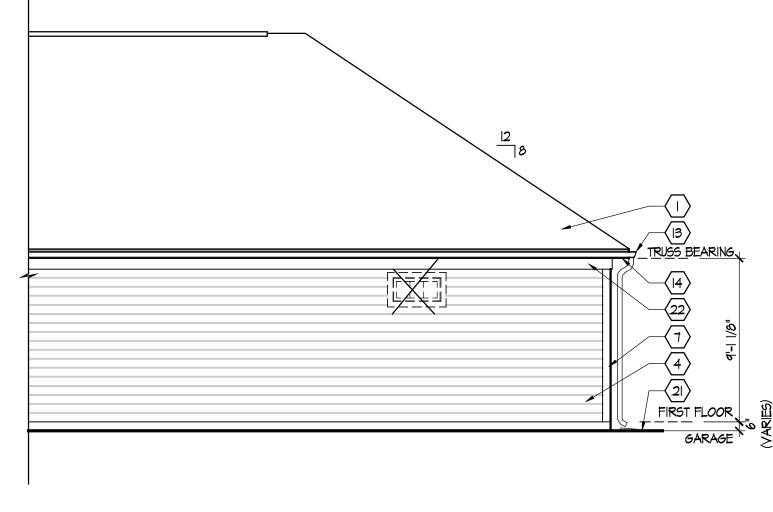

B WINDOW - OPTIONAL


Partial Extended Master




Scale: 3/16" = 1'-0" Suite Elevation


Partial Extended Master Scale: 3/16" = 1'-0" Suite Elevation

SEE SHEET A.201 FOR ELEVATION CODED NOTES AND BASE ELEVATIONS. SEE BASE FLOOR PLAN FOR ELEVATION DESIGNATION MARKERS.

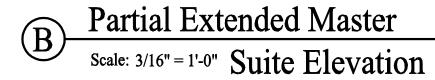

Extended Master Scale: 3/16" = 1'-0" Suite Elevation

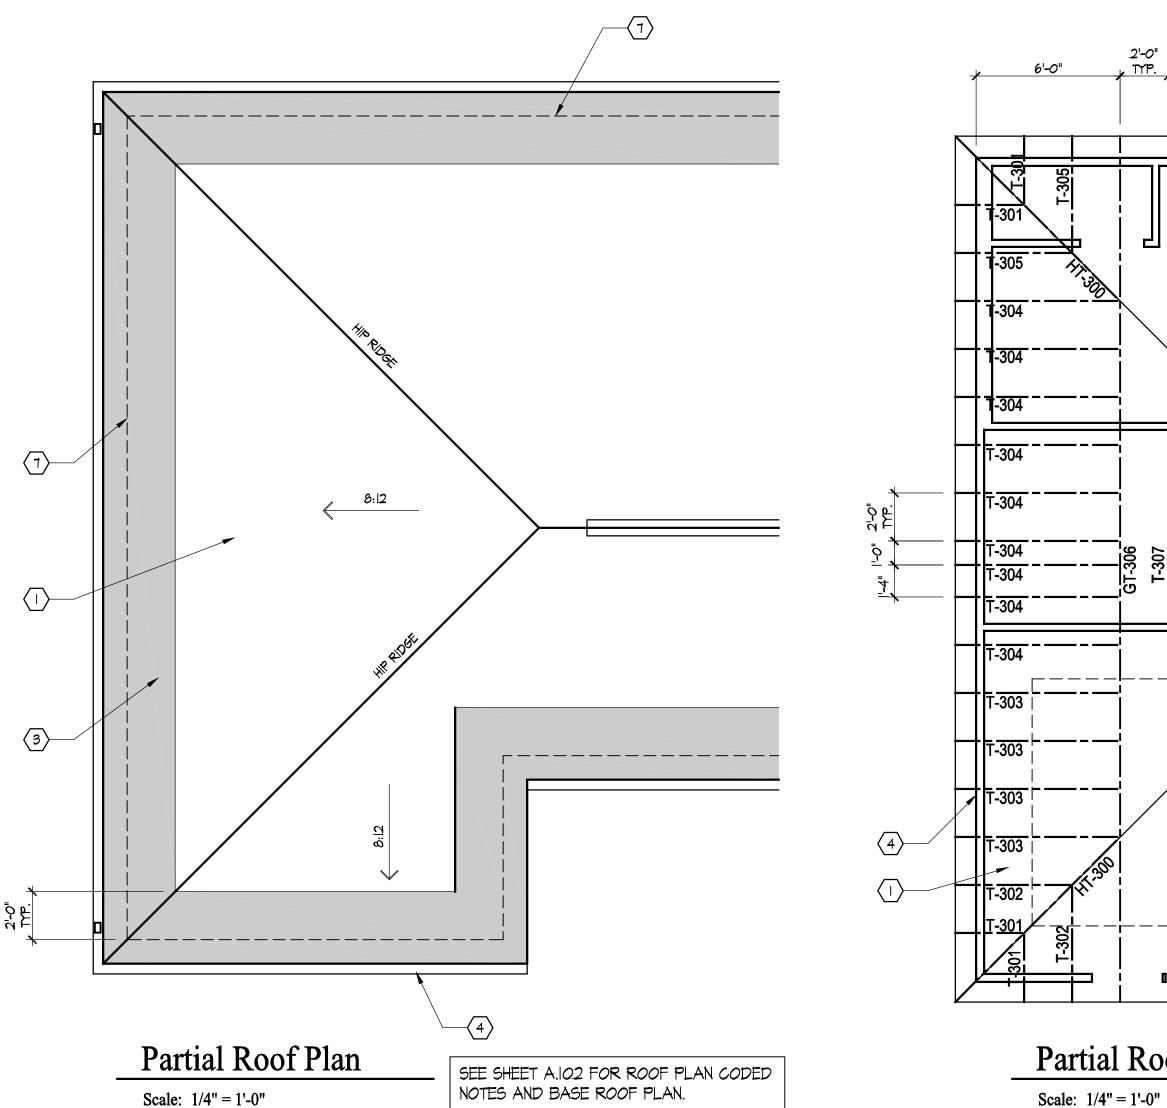

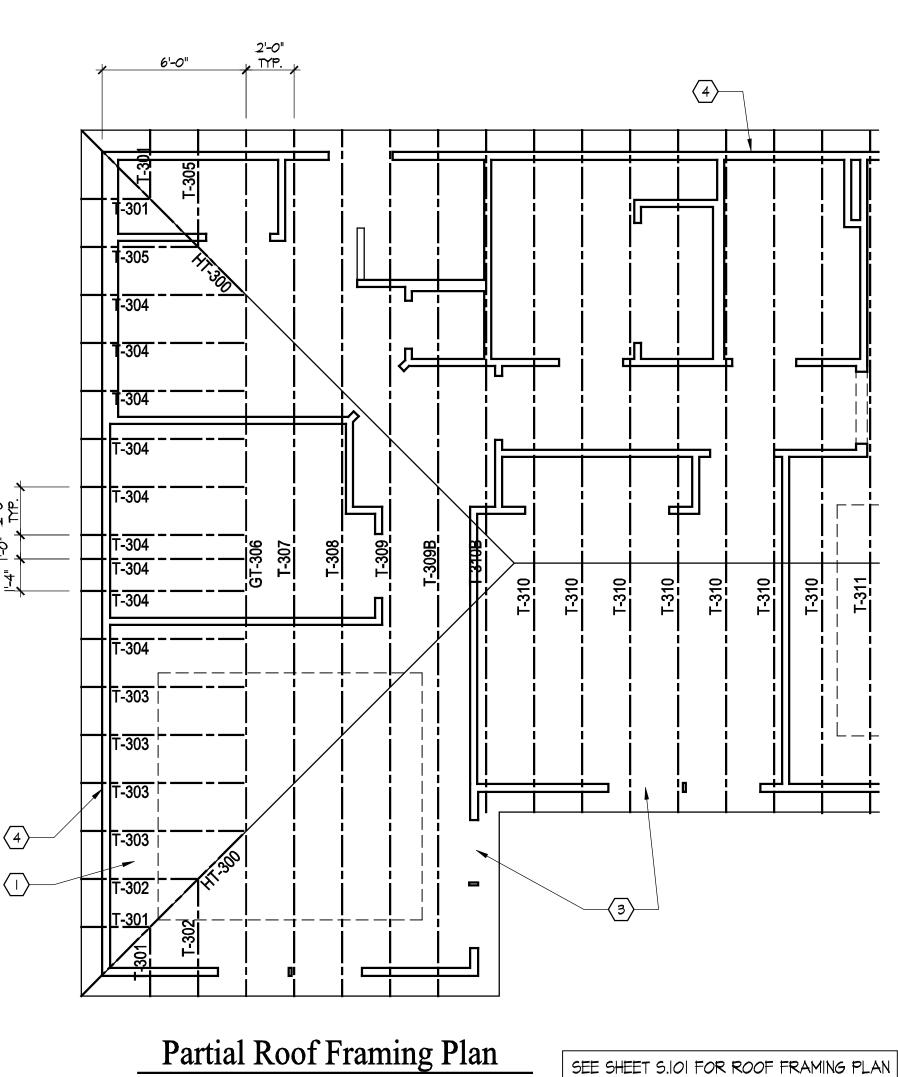

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Epcon Communities
Villas at Park Place
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Deluxe Master Suite Elevations & Roof Plans


Drawing Title

Architectural Style **European Country**

Sheet Number A.101K D3M - 2010

CODED NOTES AND BASE ROOF FRAMING

PLAN \$ 5.102 FOR ROOF TRUSS PROFILES.

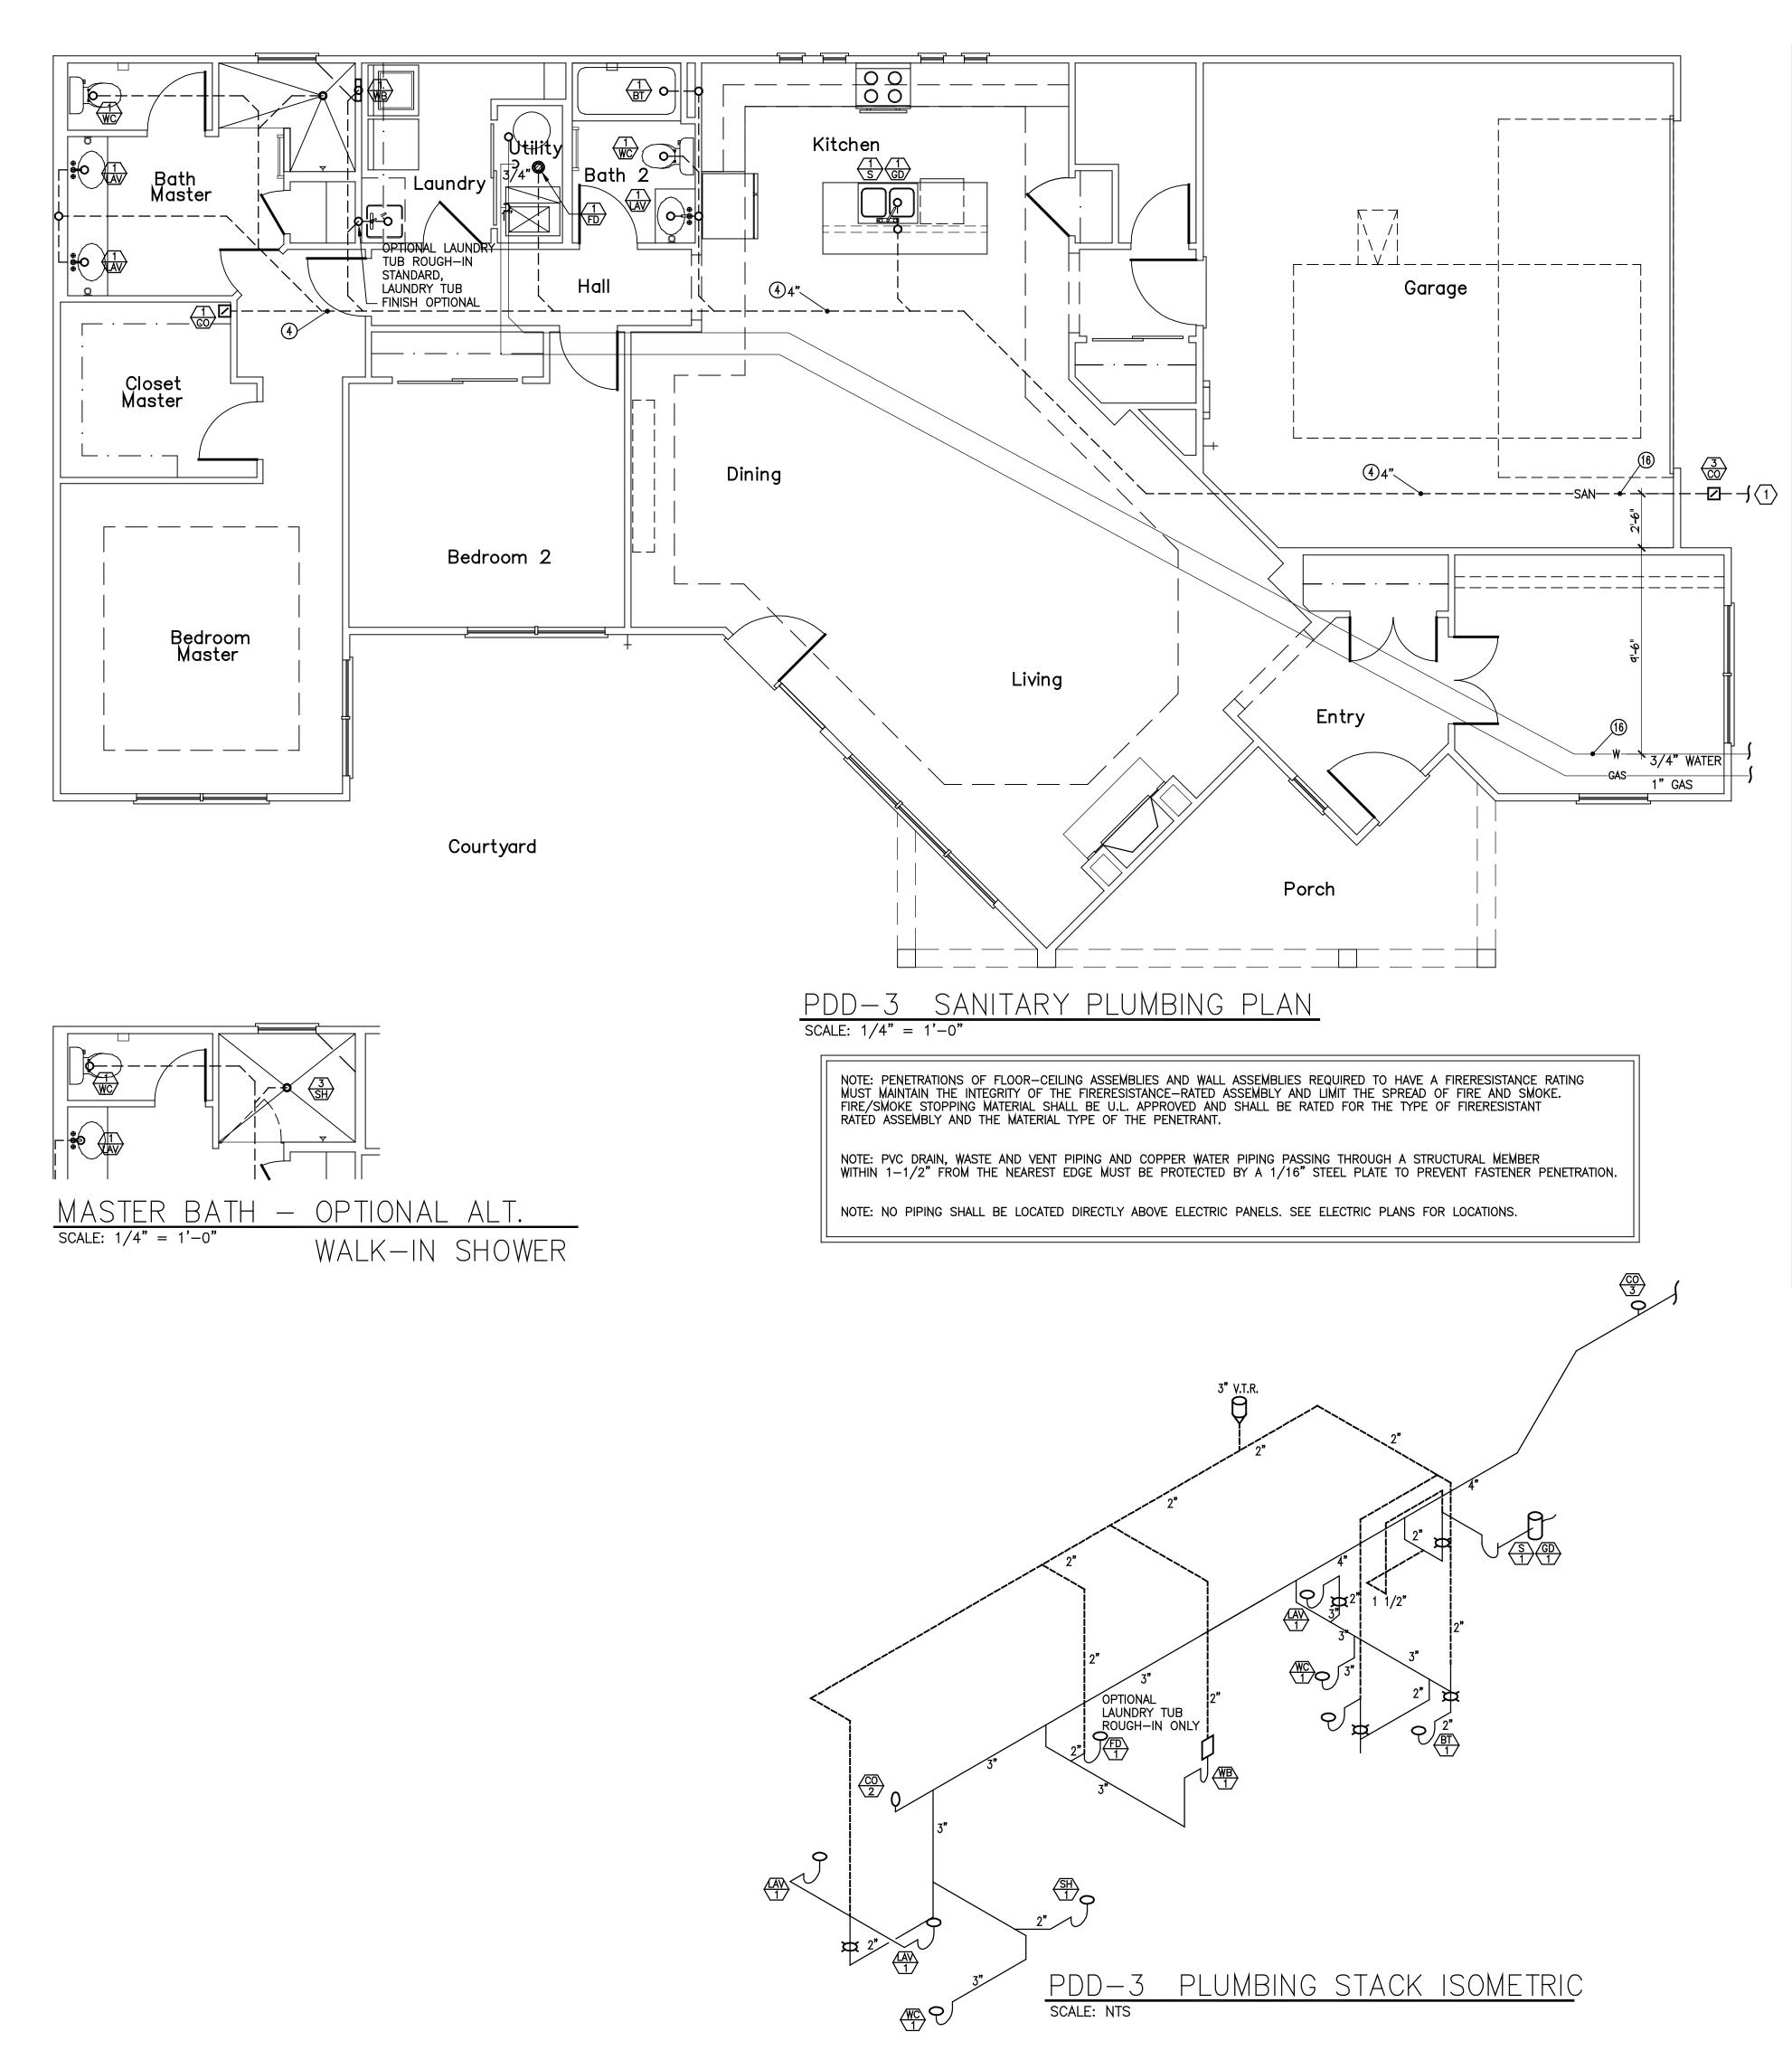

PLUMBING DESIGN CRITERIA

-SANITARY BUILDING SERVICES SHALL BE SDR-35 AND AS APPROVED FOR USE BY LOCAL UTILITY.

-SANITARY DRAIN WASTE AND VENT PIPING SHALL BE SCHEDULE #40 PVC SOLVENT WELD PIPE AND FITTINGS. PIPING SHALL BE SLOPED AS FOLLOWS: 3" AND SMALLER: 1/4" PER FT. 4" AND LARGER: 1/8" PER FT.

-WATER SERVICE SUPPLY PIPING SHALL BE POLYTHYLENE TUBING OR TYPE 'K' SOFT COPPER AND AS APPROVED FOR USE BY LOCAL UTILITY.

-PROVIDE 3/4" WATER SERVICE TO EACH BUILDING. COORDINATE WITH LOCAL WATER UTILITY.

-PROVIDE WATTS NO. 7D BACKFLOW DEVICE ON WATER SERVICE TO EACH INDIVIDUAL UNIT.

-PROVIDE MINIMUM 1/2" WATER SUPPLY PIPE TO EACH PLUMBING FIXTURE, PIPING TO BE INSTALLED BELOW FLOOR SLAB, (NO FITTINGS PERMITTED BELOW SLAB). WATER SUPPLY PIPING SHALL BE AS FOLLOWS: o TYPE 'K' SOFT COPPER TUBING - BELOW SLAB.

o TYPE 'L' HARD COPPER TUBING - ABOVE SLAB. o CPVC COILED PLASTIC TUBING - BELOW SLAB. o CPVC RIGID PLASTIC TUBING - ABOVE SLAB.

-GAS SERVICE SUPPLY PIPING SHALL BE AS REQUIRED BY LOCAL GAS UTILITY,

-PROVIDE GAS METER AND RISER ASSEMBLY FOR EACH UNIT PER LOCAL GAS UTILITY REQUIREMENTS.

-PROVIDE MINIMUM 1/2" GAS SUPPLY PIPE TO EACH DESIGNATED PIECE OF EQUIPMENT. PIPING TO BE INSTALLED IN VENTILATED ATTIC. GAS SUPPLY PIPING SHALL BE AS FOLLOWS: o SCHEDULE #40 BLACK STEEL PIPE. o CSST TUBING.

-PROVIDE GAS SUPPLY PIPE TO THE FOLLOWING EQUIPMENT: o FURNACE o WATER HEATER

o FIREPLACE o FIRE PIT

-ALL PIPING SYSTEMS SHALL COMPLY WITH STATE AND LOCAL CODE REQUIREMENTS.

-ALL MATERIALS AND INSTALLATION OF PLUMBING SYSTEMS SHALL COMPLY WITH STATE AND LOCAL BUILDING CODE REQUIREMENTS. -WATER HEATER SHALL BE 40 GALLON GAS FIRED WITH 35,000 BTUH GAS INPUT.

o INSTALL CODE APPROVED, SELF CLOSING TEMPERATURE AND PRESSURE RELIEF VALVE AND DISCHARGE INDIRECTLY INTO HUB DRAIN. o INSTALL HEAT TRAPS ON CW AND HW SUPPLY PIPES.

O INSTALL THERMAL EXPANSION TANK ON CW SUPPLY PIPE

TO WATER HEATER. -WATER HEATER SHALL BE ADJUSTED TO DELIVER NO MORE THAN

-SHOWER VALVES SHALL BE THERMOSTATIC/PRESSURE BALANCE TYPE MIXING VALVES WITH MAXIMUM WATER TEMPERATURE ADJUSTED TO

-EACH FIXTURE OR PIECE OF EQUIPMENT SHALL BE INSTALLED WITH INDIVIDUAL SHUT-OFF VALVES. -SHOCK ARRESTORS SHALL BE INSTALLED ON WATER SUPPLY PIPING

(I.E. DISHWASHER/WASHING MACHINE). -PROVIDE 1/2" CW SUPPLY PIPE WITH 1/4 TURN BALL VALVE PVC VALVE BOX FOR ICE MAKER.

WHERE QUICK CLOSING VALVES ARE CONNECTED TO THE SYSTEM.

-PROVIDE 1/2" HW SUPPLY PIPE WITH 1/4 TURN BALL VALVE PROVIDE 5/8" DRAIN LINE FROM DISHWASHER TO GARBAGE DISPOSAL. -INSTALL 1/3 H.P. GARBAGE DISPOSAL IN SINK COMPARTMENT CLOSEST TO DISHWASHER.

EXCEPTION: ON SINK UPGRADE, G.D. TO BE INSTALLED IN VEGTABLE BOWL.

-PROVIDE 1/2"CW/HW SUPPLY PIPES WITH 1/4 TURN VALVES, 2" DRAIN LINE AND PVC BOX FOR WASHING MACHINE. -NO WATER PIPING TO BE LOCATED IN EXTERIOR WALL. PIPE ROUGH-INS SHALL BE LOCATED IN BASE CABINET BELOW FIXTURE. -INSTALL CLEANOUTS ON BUILDING SANITARY DRAINS AT MAXIMUM

100FT. O.C. AND CHANGES GREATER THAN 45. -INSTALL FLOOR DRAIN IN WATER HEATER CLOSET.

-PROVIDE TRAP PRIMER VALVE FOR ALL FLOOR DRAINS AND


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- 4" SANITARY BUILDING DRAIN LOCATED BELOW FLOOR SLAB. SLOPE MINIMUM 1/8" PER FT.
- 2 3/4" WATER SUPPLY PIPING LOCATED BELOW FLOOR SLAB. INSTALL MINIMUM 48" BELOW GRADE.
- 3 1/2" (2LB.) CSST GAS SUPPLY PIPE FROM METER SET TO MANIFOLD. INSTALL IN VENTILATED ATTIC.

PLUMBING PLAN NOTES

- 4 SANITARY BRANCH PIPING FOR 1st FLOOR FIXTURES TO BE LOCATED BELOW FIRST FLOOR SLAB.
- 5 HOT AND COLD WATER PIPING FOR 1st FLOOR FIXTURES TO BE LOCATED BELOW FIRST FLOOR SLAB. (NO FITTINGS BELOW SLAB).
- 6 GAS PIPING FOR 1st FLOOR EQUIPMENT TO BE LOCATED IN VENTILATED ATTIC.

 EXTEND INDIVIDUAL "CSST" GAS SUPPLY PIPES FROM MANIFOLD TO EACH INDIVIDUAL PIECE OF EQUIPMENT. (NO FITTINGS).
- 7 DISHWASHER.
 PROVIDE 1/2" VALVED HW WITH FLEX HOSE TO DW.
 PROVIDE 5/8" FLEX DRAIN LINE FROM D.W. TO G.D.
- 8 ICE MAKER VALVE BOX. PROVIDE 1/2" VALVED CW WITH 3/8" FLEX HOSE TO ICE MAKER.
- 9 FURNACE.
 PROVIDE 3/4" CSST WARD FLEX GAS SUPPLY PIPE
 TO FURNACE. INSTALL GAS VALVE AT CONNECTION TO EQUIPMENT. WATER HEATER,
 PROVIDE 3/4" CSST WARD FLEX GAS SUPPLY PIPE
- TO WATER HEATER. INSTALL GAS VALVE AT CONNECTION TO EQUIPMENT. RANGE. (OPTIONAL)
 PROVIDE 1/2" CSST WARD FLEX GAS SUPPLY PIPE
 TO RANGE. INSTALL GAS VALVE AT CONNECTION TO EQUIPMENT.
- FIREPLACE.
 PROVIDE 1/2" CSST WARDFLEX GAS SUPPLY PIPE
 TO VENTED FIREPLACE, INSTALL BRASS SHUT-OFF VALVE AND KEY.
- FIRE PIT. (OPTIONAL)
 PROVIDE 1/2" CSST WARDFLEX GAS SUPPLY PIPE
 TO FIRE PIT. INSTALL BRASS SHUT-OFF VALVE
 AND KEY AT 18" ABOVE GRADE. (VERIFY EXACT LOCATION WITH G.C.).
- 1/2" TYPE "K" FLEX COPPER GAS SUPPLY PIPE. INSTALL IN PVC CONDUIT 12 "-18" BELOW GRADE. COORDINATE INSTALLATION WITH G.C.
- (15) 4" SANITARY DOWN IN CHASE TO TIE INTO FIRST FLOOR SANITARY.
- 16 PLUMBER TO PROVIDE 4" PVC SLEEVE FOR WATER AND 4" SANITARY LINE FOR INSTALLATION BY FOOTER CONTRACTOR.



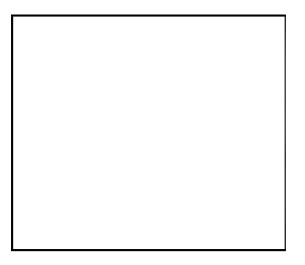

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Place ommunities Chester, ark West Δ at Ge pcon Villas Pla B ark By

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Disk No.	Revision	Date
		2/17/12

ENERGY REQUIREMENTS.

Architect Project Number 2010-005


Community Dates & Revisions **Date Originated** 1 FEB 2015 Permit Construction Revisions


Drawing Title

Plumbing Plans

Architectural Style **European Country**

> **Sheet Number** D3M - 2010

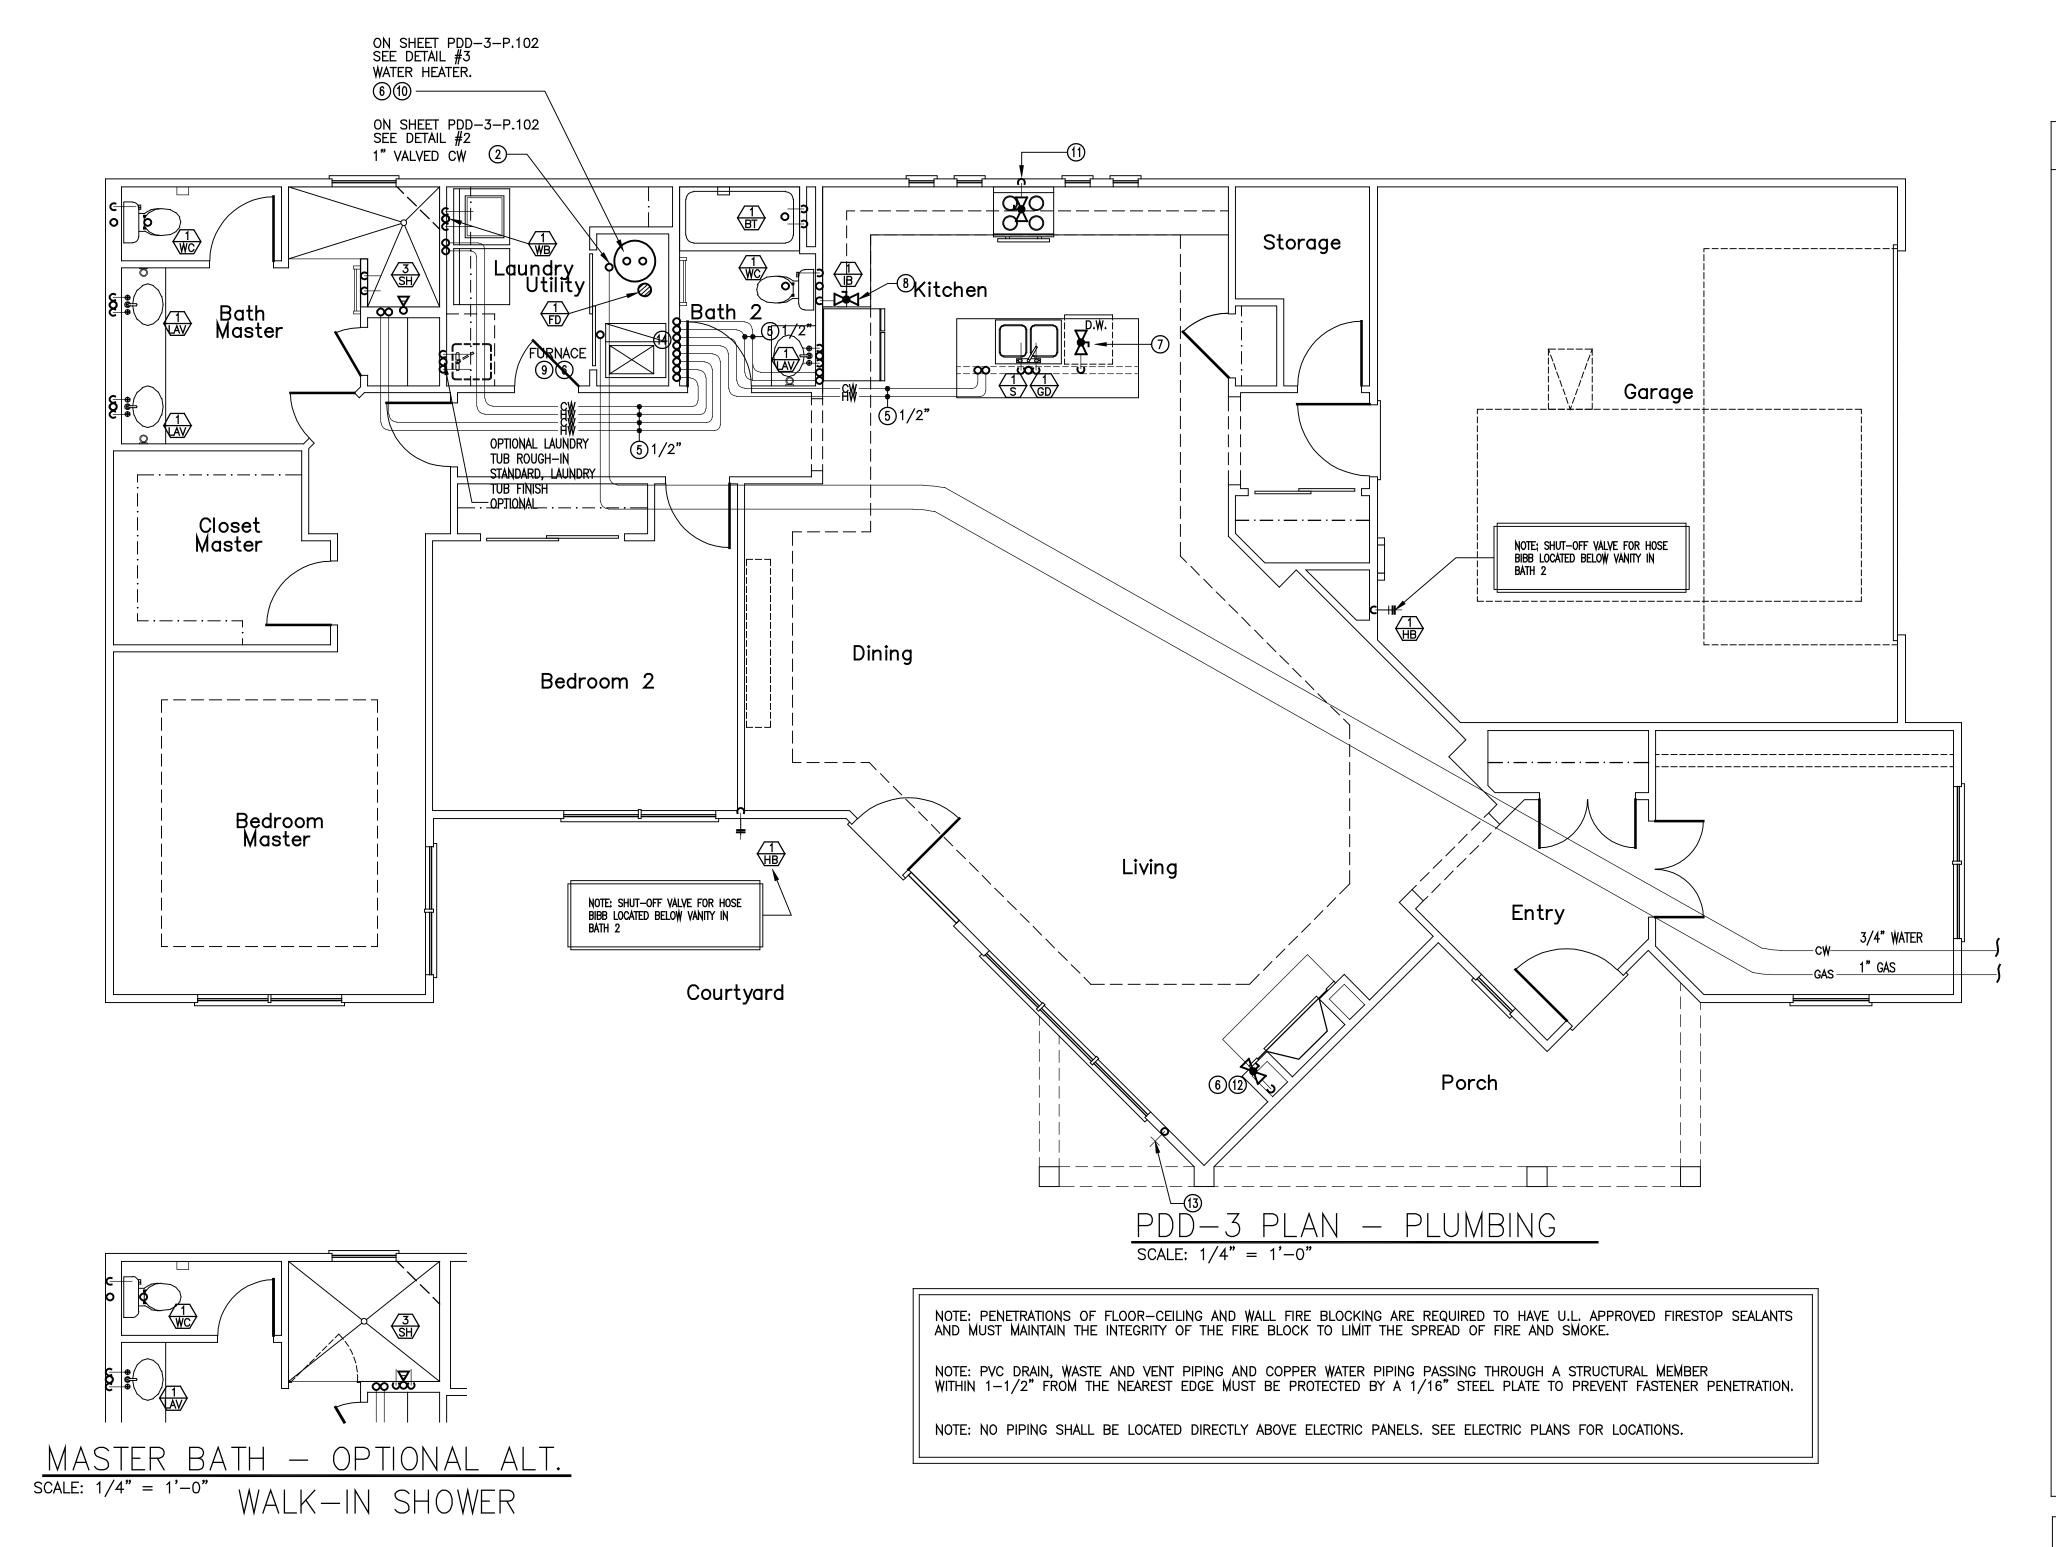

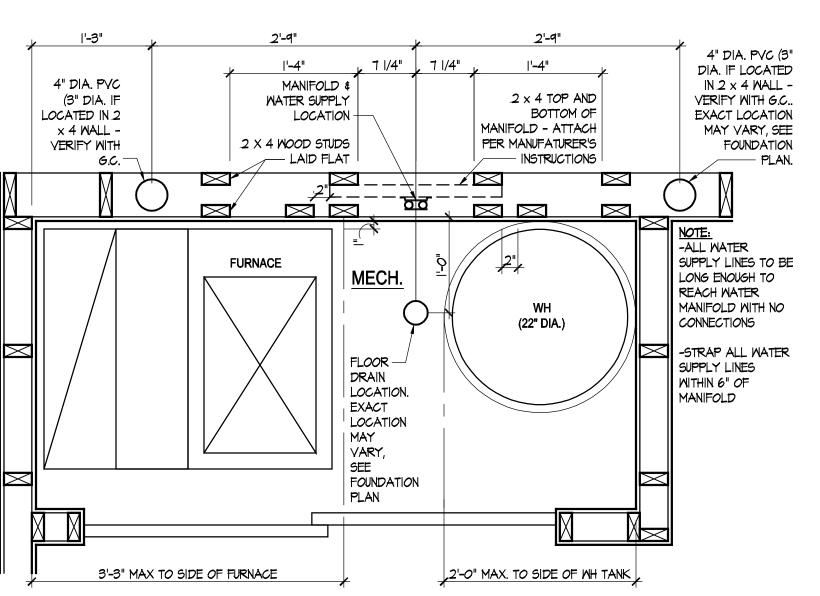

MANIFOLD DETAIL

PLUMBING DESIGN CRITERIA

-SANITARY BUILDING SERVICES SHALL BE SDR-35 AND AS APPROVED FOR USE BY LOCAL UTILITY.

-SANITARY DRAIN WASTE AND VENT PIPING SHALL BE SCHEDULE #40 PVC SOLVENT WELD PIPE AND FITTINGS. PIPING SHALL BE SLOPED AS FOLLOWS: 3" AND SMALLER: 1/4" PER FT. 4" AND LARGER: 1/8" PER FT.

-WATER SERVICE SUPPLY PIPING SHALL BE POLYTHYLENE TUBING OR TYPE 'K' SOFT COPPER AND AS APPROVED FOR USE BY LOCAL UTILITY.

-PROVIDE 3/4" WATER SERVICE TO EACH BUILDING. COORDINATE WITH LOCAL WATER UTILITY.

-PROVIDE WATTS NO. 7D BACKFLOW DEVICE ON WATER SERVICE TO EACH INDIVIDUAL UNIT.

-PROVIDE MINIMUM 1/2" WATER SUPPLY PIPE TO EACH PLUMBING FIXTURE. PIPING TO BE INSTALLED BELOW FLOOR SLAB. (NO FITTINGS PERMITTED BELOW SLAB). WATER SUPPLY PIPING SHALL BE AS FOLLOWS:

o TYPE 'K' SOFT COPPER TUBING - BELOW SLAB o TYPE 'L' HARD COPPER TUBING - ABOVE SLAB. o CPVC COILED PLASTIC TUBING - BELOW SLAB. o CPVC RIGID PLASTIC TUBING - ABOVE SLAB.

-GAS SERVICE SUPPLY PIPING SHALL BE AS REQUIRED BY LOCAL GAS UTILITY.

-PROVIDE GAS METER AND RISER ASSEMBLY FOR EACH UNIT PER LOCAL GAS UTILITY REQUIREMENTS.

-PROVIDE MINIMUM 1/2" GAS SUPPLY PIPE TO EACH DESIGNATED PIECE OF EQUIPMENT. PIPING TO BE INSTALLED IN VENTILATED ATTIC. GAS SUPPLY PIPING SHALL BE AS FOLLOWS: o SCHEDULE #40 BLACK STEEL PIPE. o CSST TUBING.

-PROVIDE GAS SUPPLY PIPE TO THE FOLLOWING EQUIPMENT: o FURNACE o WATER HEATER o FIREPLACE o RANGE o FIRE PIT

-ALL PIPING SYSTEMS SHALL COMPLY WITH STATE AND LOCAL CODE REQUIREMENTS.

-ALL MATERIALS AND INSTALLATION OF PLUMBING SYSTEMS SHALL COMPLY WITH STATE AND LOCAL BUILDING CODE REQUIREMENTS.

-WATER HEATER SHALL BE 40 GALLON GAS FIRED WITH 35,000 BTUH GAS INPUT. o INSTALL CODE APPROVED, SELF CLOSING TEMPERATURE AND PRESSURE RELIEF VALVE AND DISCHARGE INDIRECTLY INTO

O INSTALL HEAT TRAPS ON CW AND HW SUPPLY PIPES. O INSTALL THERMAL EXPANSION TANK ON CW SUPPLY PIPE TO WATER HEATER.

-WATER HEATER SHALL BE ADJUSTED TO DELIVER NO MORE THAN

-SHOWER VALVES SHALL BE THERMOSTATIC/PRESSURE BALANCE TYPE MIXING VALVES WITH MAXIMUM WATER TEMPERATURE ADJUSTED TO DELIVER NO MORE THAN 110' F HW.

-EACH FIXTURE OR PIECE OF EQUIPMENT SHALL BE INSTALLED WITH INDIVIDUAL SHUT-OFF VALVES.

-SHOCK ARRESTORS SHALL BE INSTALLED ON WATER SUPPLY PIPING WHERE QUICK CLOSING VALVES ARE CONNECTED TO THE SYSTEM. (I.E. DISHWASHER/WASHING MACHINE).

-PROVIDE 1/2" CW SUPPLY PIPE WITH 1/4 TURN BALL VALVE PVC VALVE BOX FOR ICE MAKER.

-PROVIDE 1/2" HW SUPPLY PIPE WITH 1/4 TURN BALL VALVE FOR DISHWASHER. PROVIDE 5/8" DRAIN LINE FROM DISHWASHER TO GARBAGE DISPOSAL.

-INSTALL 1/3 H.P. GARBAGE DISPOSAL IN SINK COMPARTMENT CLOSEST TO DISHWASHER.

EXCEPTION: ON SINK UPGRADE, G.D. TO BE INSTALLED IN VEGTABLE BOWL.

-PROVIDE 1/2"CW/HW SUPPLY PIPES WITH 1/4 TURN VALVES, 2" DRAIN LINE AND PVC BOX FOR WASHING MACHINE.

-NO WATER PIPING TO BE LOCATED IN EXTERIOR WALL. PIPE ROUGH-INS SHALL BE LOCATED IN BASE CABINET BELOW FIXTURE,

-INSTALL CLEANOUTS ON BUILDING SANITARY DRAINS AT MAXIMUM 100FT. O.C. AND CHANGES GREATER THAN 45.

-INSTALL FLOOR DRAIN IN WATER HEATER CLOSET.

-PROVIDE TRAP PRIMER VALVE FOR ALL FLOOR DRAINS AND HUB DRAINS.

PLUMBING PLAN NOTES

- 4" SANITARY BUILDING DRAIN LOCATED BELOW FLOOR SLAB. SLOPE MINIMUM 1/8" PER FT.
- 2 1" WATER SUPPLY PIPING LOCATED BELOW FLOOR SLAB, INSTALL MINIMUM 48" BELOW GRADE.
- 3 1/2" (2LB.) CSST GAS SUPPLY PIPE FROM METER SET TO MANIFOLD. INSTALL IN VENTILATED ATTIC.
- 4 SANITARY BRANCH PIPING FOR 1st FLOOR FIXTURES TO BE LOCATED BELOW FIRST FLOOR SLAB.
- HOT AND COLD WATER PIPING FOR 1st FLOOR FIXTURES TO BE LOCATED BELOW FIRST FLOOR SLAB. (NO FITTINGS BELOW SLAB).
- GAS PIPING FOR 1st FLOOR EQUIPMENT TO BE LOCATED IN VENTILATED ATTIC.
 EXTEND INDIVIDUAL "CSST" GAS SUPPLY PIPES FROM MANIFOLD TO EACH INDIVIDUAL PIECE OF EQUIPMENT. (NO FITTINGS).
- DISHWASHER.
 PROVIDE 1/2" VALVED HW WITH FLEX HOSE TO DW.
 PROVIDE 5/8" FLEX DRAIN LINE FROM D.W. TO G.D.
- 8 ICE MAKER VALVE BOX. PROVIDE 1/2" VALVED CW WITH 3/8" FLEX HOSE TO ICE MAKER.
- 9 FURNACE.
 PROVIDE 3/4" CSST WARD FLEX GAS SUPPLY PIPE
 TO FURNACE. INSTALL GAS VALVE AT CONNECTION TO EQUIPMENT.
- WATER HEATER.
 PROVIDE 3/4" CSST WARD FLEX GAS SUPPLY PIPE
 TO WATER HEATER. INSTALL GAS VALVE AT CONNECTION TO EQUIPMENT.
- RANGE. (OPTIONAL)
 PROVIDE 1/2" CSST WARD FLEX GAS SUPPLY PIPE
 TO RANGE. INSTALL GAS VALVE AT CONNECTION TO EQUIPMENT.
- 12 FIREPLACE.

PROVIDE 1/2" CSST WARDFLEX GAS SUPPLY PIPE

- TO VENTED FIREPLACE. INSTALL BRASS SHUT-OFF VALVE AND KEY. OPTIONAL GAS BIB - PROVIDE 1/2" CSST WARDFLEX GAS SUPPLY PIPE. INSTALL PER ALL APPLICABLE CODES.
- (14) SEE DETAIL THIS SHEET FOR EXACT MANIFOLD LOCATION.

(VERIFY EXACT LOCATION WITH G.C.).

HOT AND COLD WATER PIPING FOR 2nd FLOOR FIXTURES TO BE ROUTED UP TO 2nd FLOOR JOIST SPACE.





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Place ommunities Park con Villas \mathbf{B}

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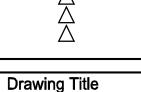
ENERGY REQUIREMENTS.

Prototype	Interim Page Revisions			
Disk No.	Revision	Date		
		2/17/12		

Architect Project Number 2010-005

Community Dates & Revisions Date Originated 1 FEB 2015 Permit

Construction Revisions



Supply Plumbing Plan

Architectural Style European Country

> **Sheet Number** P.101 D3M - 2010

DESCRIPTION WATER CLOSET LAVATORY	WASTE	PIP VENT 1-1/2"	нот	COLD	ACCESSORIES
LAVATORY				1/2*	SEAT: BEMIS NO. 60
LAVATORY	l				
	1-1/2"	1-1/2"	1/2*	1/2*	
DATIJI	1 1/0*	1-1/2"	1/2*	1/2*	LEET OR DIGHT HAVID OUTLET (CEE DIANIC)
BATHTUB	1-1/2	1-1/2	1/2	1/2	LEFT OR RIGHT HAND OUTLET (SEE PLANS)
SHOWER	2"	1-1/2"	1/2*	1/2*	LEFT OR RIGHT HAND OUTLET (SEE PLANS)
SHOWER W/ BUILT-IN SEAT	2"	1-1/2"	1/2"	1/2*	LEFT OR RIGHT HAND OUTLET (SEE PLANS)
CUSTOM TILED SHOWER	2"	1-1/2"	1/2"	1/2"	
SINK	1-1/2"	1-1/2"	1/2"	1/2"	
GARBAGE DISPOSAL	1-1/2"				
ICE MAKER BOX				1/2"	
WASHER BOX	2"	1-1/2"	1/2"	1/2"	
FROST FREE HOSE BIBB				3/4"	INSTALL IN EACH GARAGE. MOUNT 18" A.F.F
FLOOR DRAIN	3"				FURNISH WITH TRAP PRIMER
CLEANOUT	4"				NICKALOY ACCESS COVER
CLEANOUT	4"				STAINLESS STEEL ACCESS COVER
	CUSTOM TILED SHOWER SINK GARBAGE DISPOSAL ICE MAKER BOX WASHER BOX FROST FREE HOSE BIBB FLOOR DRAIN CLEANOUT	CUSTOM TILED SHOWER 2" SINK 1-1/2" GARBAGE DISPOSAL 1-1/2" ICE MAKER BOX WASHER BOX 2" FROST FREE HOSE BIBB FLOOR DRAIN 3" CLEANOUT 4" CLEANOUT 4"	HOWER W/ BUILT—IN SEAT 2" 1-1/2" CUSTOM TILED SHOWER 2" 1-1/2" SINK 1-1/2" 1-1/2" GARBAGE DISPOSAL 1-1/2" ICE MAKER BOX WASHER BOX 2" 1-1/2" FROST FREE HOSE BIBB CLEANOUT 4"	CUSTOM TILED SHOWER 2" 1-1/2" 1/2" 1/2"	HOWER W/ BUILT—IN SEAT 2" 1-1/2" 1/2" 1/2" 1/2" 1/2" 1/2" 1/2" 1/2"

NOTE: MOUNT SHOWER HEADS AT 92" A.F.F.

- 1/2" OR 3/4" A.G.A CORRUGATED STAINLESS STEEL SERVICE TUBE

— 1/2" OR 3/4" #40 BLACK STEEL

- 1/2" OR 3/4" SCHEDULE #40

BLACK STEÉL PIPE

└── UNION

GAS PIPE

4 CONNECTION DETAIL

— GAS VALVE

— 6" DIRT LEG

- PIPE HANGER

PLUMBING GENERAL NOTES

- 1. Refer to scope of work letter for plumbing specifications and and related work items.
- 2. Pressure test all piping systems:
- A. Sanitary and vent per State Plumbing Code. B. Building water 125 P.S.I. water for 24 hr., no drop. C. Building gas 50 P.S.I. nitrogen for 24 hr., no drop.
- 3. Sanitary service pipe shall be as required by local utility.
- 4. Water service pipe shall be as required by local utility. 5. Gas service pipe shall be as required by local utility.
- Sanitary waste and vent piping shall be Schedule #40 (PVC) and as approved for use by Local Code.
- Water distribution piping shall be Shedule #40 CPVC piping with solvent weld joints. Threaded connection to be brass.
- Gas distribution piping shall be code approved "CSST" plastic coated flexible stainless steel tubing with threaded fittings.
- Gas pipe rough—ins at equipment shall be schedule #40 black steel piping with threaded fittings.
- 10. Provide pipe hangers for all piping systems installed. Support at intervals not to exceed 4'-0". Support all piping at fittings, valves and unions. Locate all supports to allow for proper pitch and expansion of pipes.
- Pitch 3" and smaller sanitary pipe 1/4" per foot. Pitch 4" and larger sanitary pipe 1/8" per foot. Pitch vent piping for drainage.
- 12. Provide blocking for all plumbing rough—in.

at each water closet, lavatory and sink.

____ w ____

—— c**w** ——

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—— G——

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○ co

A.A.V.

V.T.R.

- All piping for plumbing fixture rough—ins to be located in wall unless otherwise noted.
- 14. Chrome escutcheon plate shall be provided where pipe rough-in
- penetrates wall. 15. Provide chrome plated brass shut-off valve with chrome supply pipe

FLOOR DRAIN

CLEANOUT PLUG

OUTSIDE CLEANOUT

SHOCK ARRESTOR

VENT THRU ROOF

W.H. NOMENCLATURE

A STANDARD
GAS WATER HEATER
A.O. SMITH NO. FSG-40

(B) EXPANSION TANK

© BALL VALVE

D DRAIN VALVE

G NOT USED

H) UNION

40 GALLON STORAGE 35 G.P.H. @ 90F RISE 35 CU. FT. NATURAL GAS.

E TEMPERATURE AND PRESSURE

J PROVIDE 24"x24"x2" GALVANIZED SHEET METAL DRIP PAN BELOW WATER HEATER. EXTEND 3/4" DRAIN LINE TO FLOOR DRAIN.

RELIEF VALVE


F) 3/4" DRAIN PIPE. EXTEND TO HUB DRAIN

AUTOMATIC AIR VENT

HOSE BIBB (INSTALL 18" ABOVE FIN. GRADE)

CLEANOUT

- 16. Bathtub and shower valves shall be equipped with integral

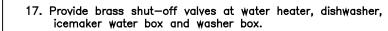

ommunities Place ark PLUMBING LEGEND <u>a</u> WATER SERVICE PIPING at COLD WATER SUPPLY PIPING Epcon HOT WATER SUPPLY PIPING . Villas ark Plac SANITARY PIPNG VENT PIPING LOW PRESSURE GAS PIPING GATE VALVE (LINE SIZE) BALL VALVE (LINE SIZE) CHECK VALVE (LINE SIZE) LUBRICATED PLUG VALVE (LINE SIZE) THERMOMETER NOTE DESIGNATION UNIT NUMBER DESIGNATION

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ENERGY REQUIREMENTS.

Prototype	Interim Page Revisions			
Disk No.	Revision	Date		
		4/28/10		

Architect Project Number 2010-005


Community Dates & Revisions Date Originated 1 FEB 2015 **Permit** Construction Revisions


Drawing Title Plumbing Specifications

& Schedules


Architectural Style **European Country**

> Sheet Number P.102 D3M - 2010

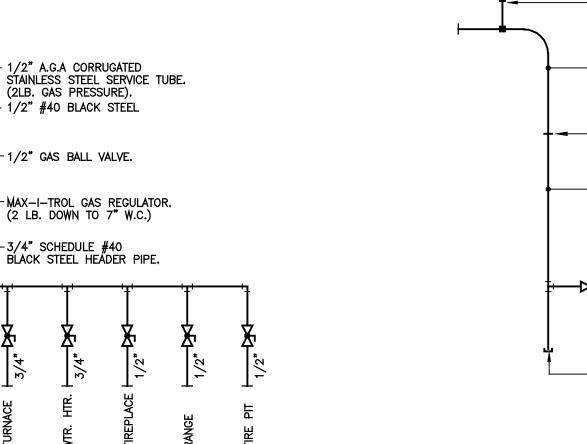


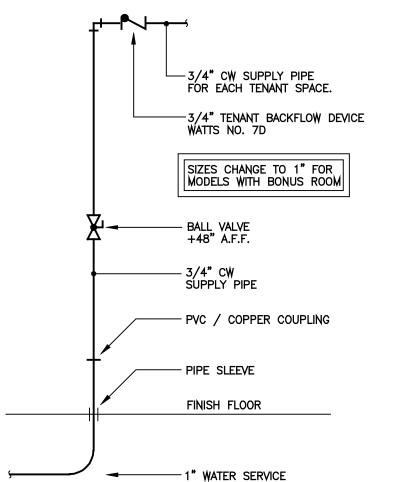


2 WATER SERVICE RISER DETAIL P.102/ N.T.S.

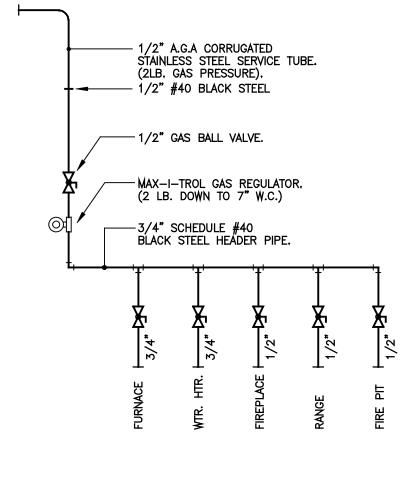





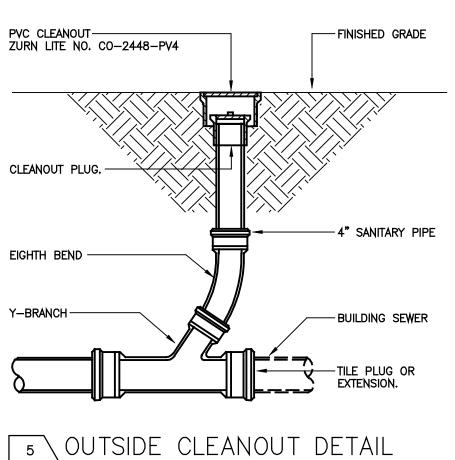

P.102 NTS

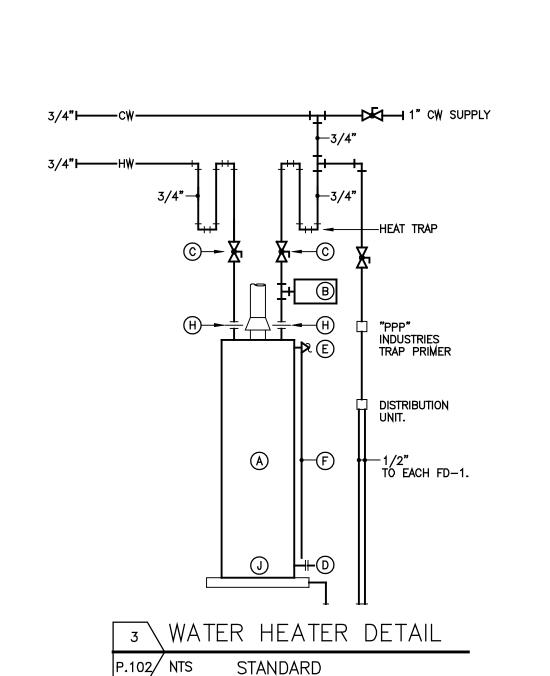

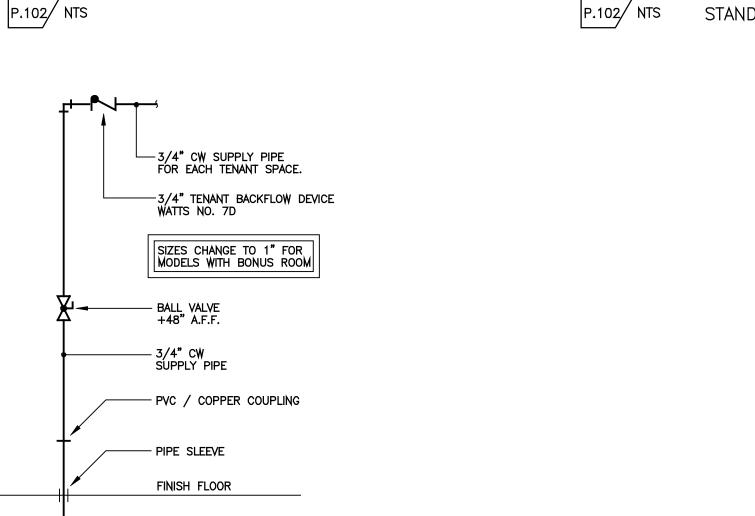

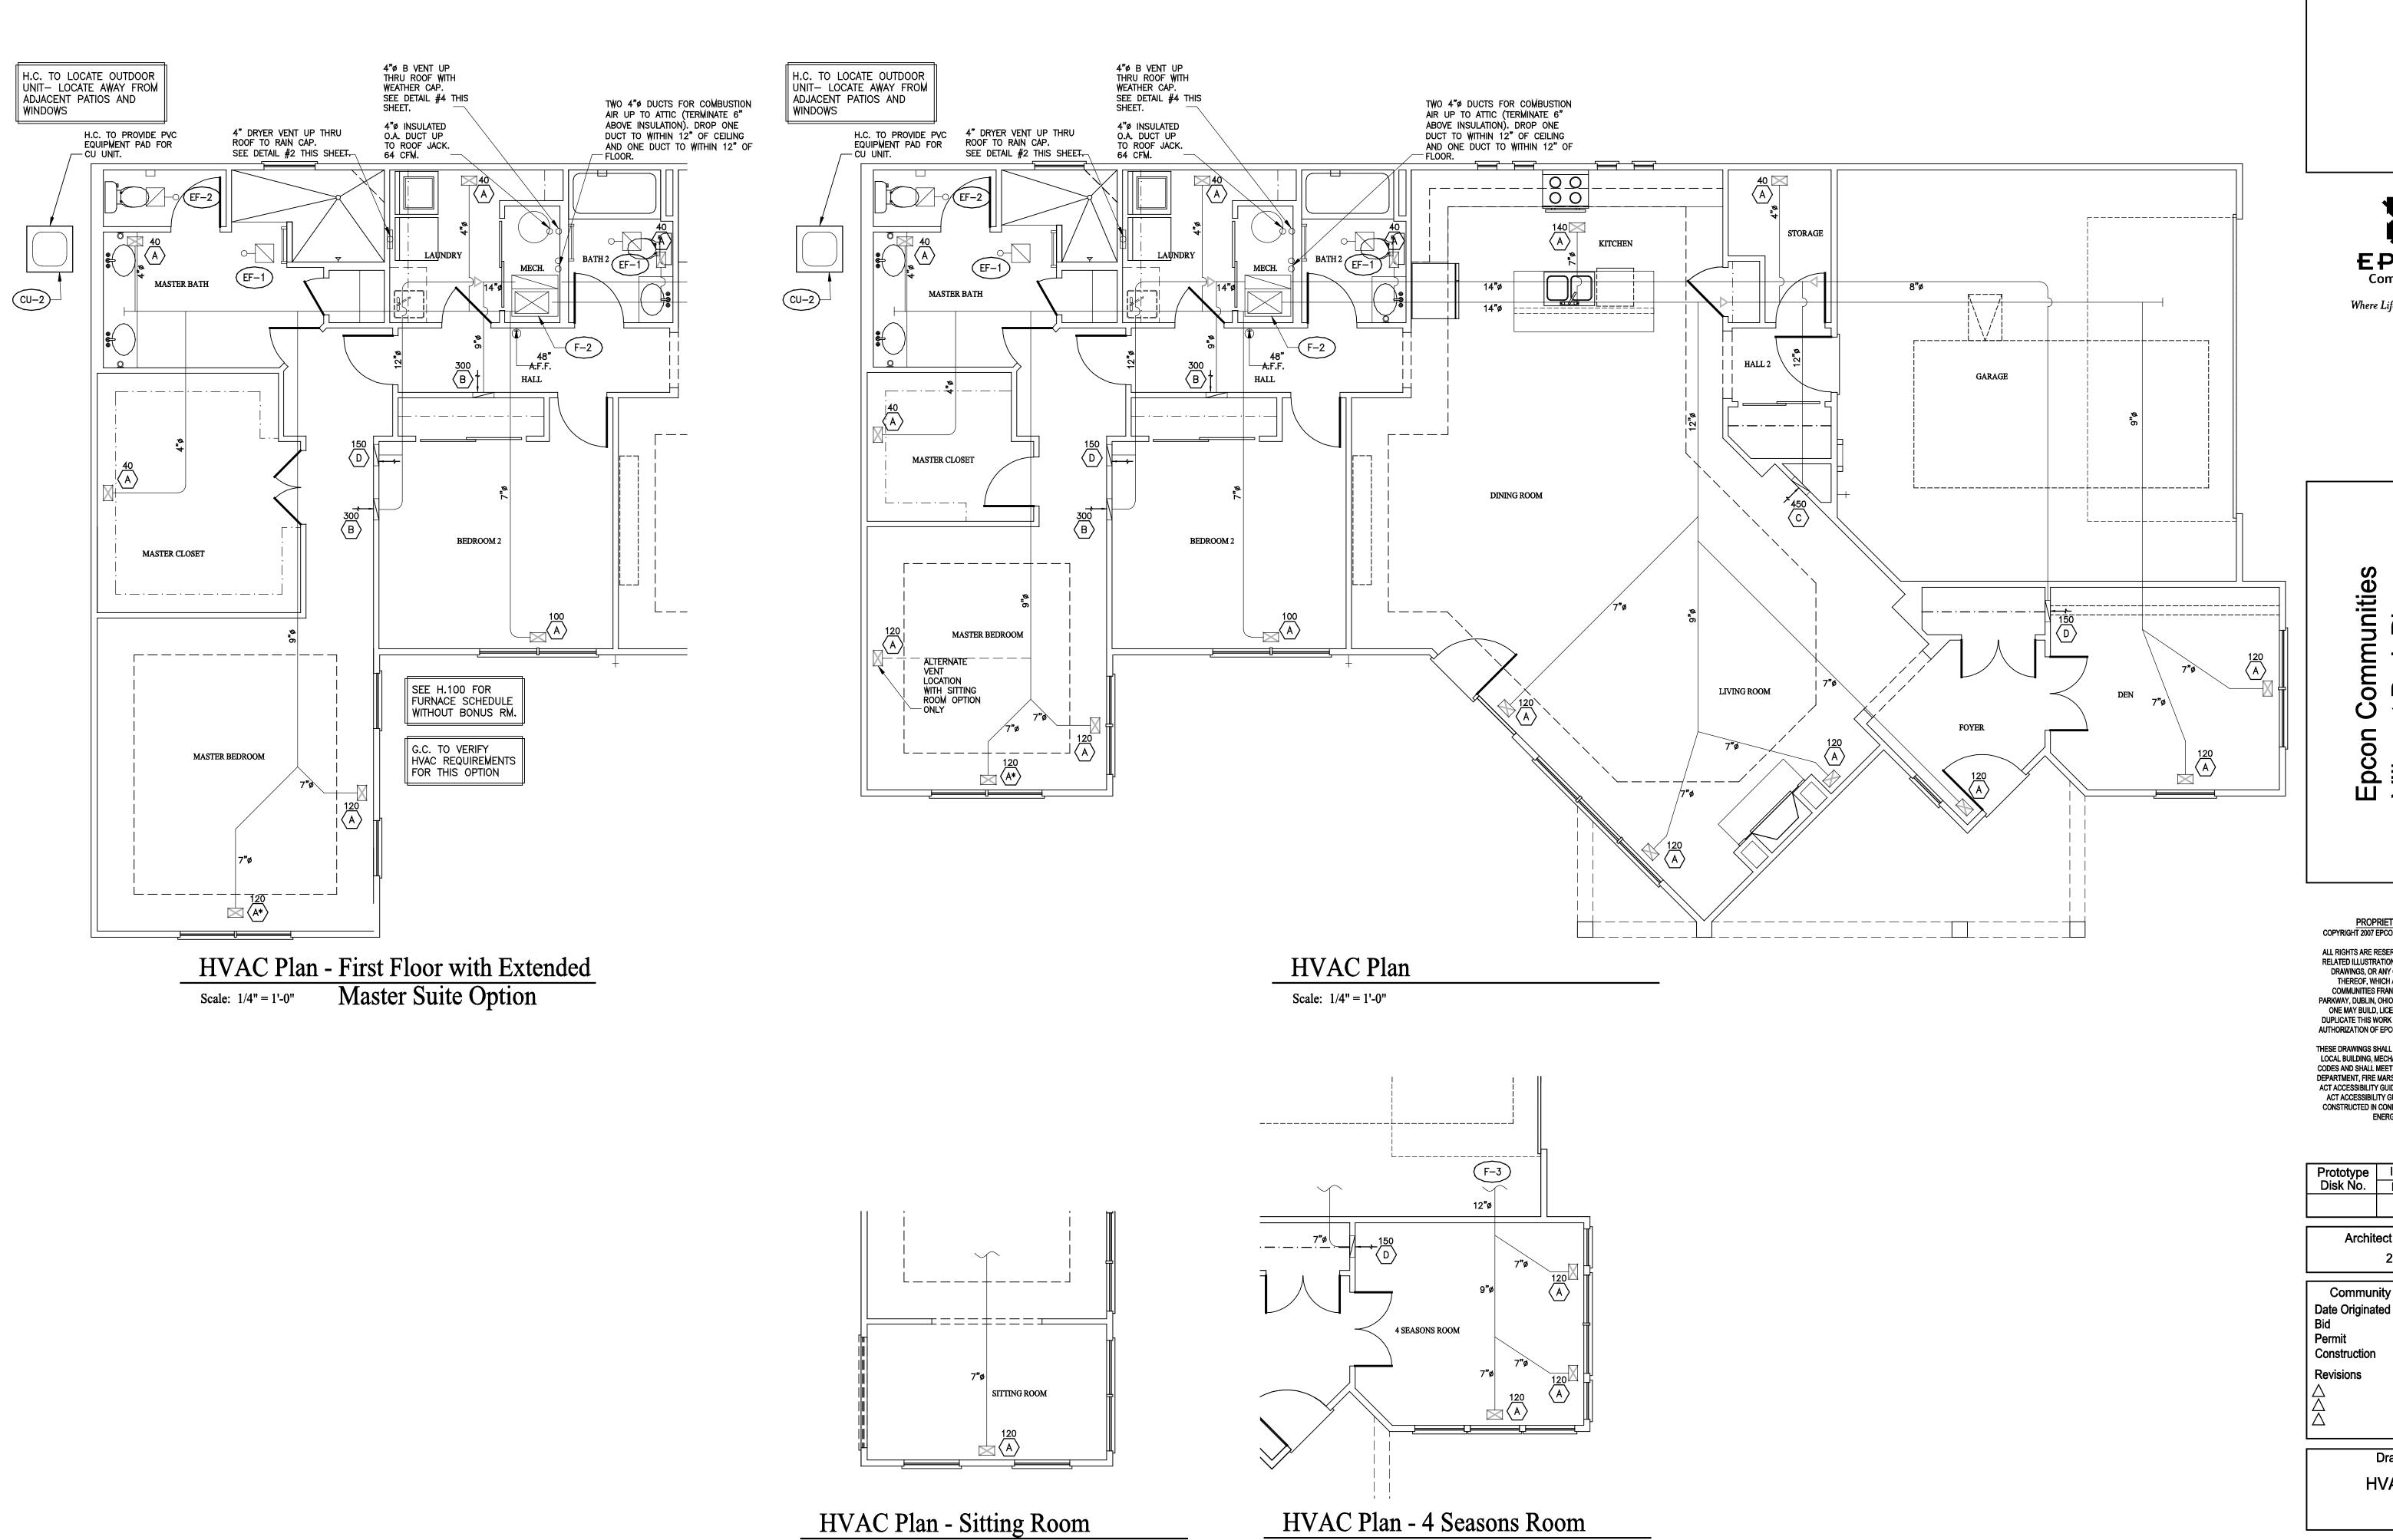

Scale: 1/4" = 1'-0"

Scale: 1/4" = 1'-0"

EPCON[™]
Communities

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Epcon Communities Villas at Park Place By Park Place West Chester, LLC

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Prototype	Interim Page Revisions			
Disk Ńo.	Revision	Date		
		2/17/12		

Architect Project Number 2010-005

Community I	Dates & Revisions
Date Originated Bid Permit Construction	1 FEB 2015
Revisions	
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Drawing Title
HVAC Plans

Architectural Style
European Country

Sheet Number H.100 D3M - 2010

			FUR	RNACE							LING DIL				CON	DENSIN	IG UNI	Т			
CA/IDOL	CARRIER	CFM	ESP	BLOWER	HEA	T. CAP.	Мвн	ELECT	RICAL	CARRIER	C.D.	TVDE	ext/poi	CARRIER	COOL. C	AP. MBH		ELECTRIC	;AL	CEED	NOTES
SYMBOL	MODEL #	CFM	ESP	HP		OUTPUT	AFUE	ν./φ	FLA.	MODEL #	S.P.	TYPE	SYMBOL	MODEL #	TOTAL	SENS.	٧/φ	M.C.A.	HACR. BKR	SEER	NOTES
F-2	58MCB100-1-16	1570	0.5	場	100	93	92.3	120	7.9	CNRVP4221 W/ TXV EXP. VALVE			CU-2	24ABR342			240/1	25.4	40	13	1,2,3,4,5,
1) 2) 3) 4)	FURNISH & INSTA SET. (SIZE PER M FURNISH & INSTA FURNISH CLEAN F FURNISH & INSTA CONCENTRIC VENT	(ANUFAC LL DIGIT ILTER, 1 LL 2" P	TURER I TAL PROD 16"x25" PVC COM	REQUIREM GRAMMABI AND SIDE (BUSTION	ENTS). .E THERM FILTER AND VEN	NOSTAT.		ANT LINE		5) FURNISH (·	,	, ,	DRAIN PIPE.							

			. ,	, 0011	EDULE		
SYMBOL	MODEL #	CFM	DRIVE	ELECTRICAL	DUTY	DAMPER	NOTES
EF-1	BROAN #670	50	DIRECT	120V	TOILET	GRAVITY	1,2, FAN ONLY
EF-2	BROAN #678 OR NUTONE 763 RLN	50	DIRECT	120V	TOILET	GRAVITY	1,2, FAN AND LIGHT COMBO

	AIR DEVICE SCHEDULE								
SYMBOL	FACE SIZE	NECK SIZE	LIMA (OR EQUAL) MODEL NO.	MAX CFM	MOUNTING SURFACE	AIR PATTERN	NOTES		
A	12"x6"	10"x4"	10V	200	GYP. BD.	2-WAY	1,2,3,4		
В	32"x8"	30"x6"	19H	260	GYP. BD.	RETURN	1,3,7		
С	32"x12"	30"x10"	19H	560	GYP. BD.	RETURN	1,3,5		
D	16 " x8"	14 " x6"	19H	130	GYP. BD.	RETURN	1,3,6		

- FINISH TO BE STANDARD OFF-WHITE.
 FURNISH NECK MOUNTED OPP. BLADE DAMPER.
 FRAME TO BE COMPATIBLE WITH PLASTER, DRYWALL, OR OTHER SURFACE MOUNTINGS.
- *SEE OPTIONAL FLOOR PLANS FOR VARYING VENT LOCATIONS
- LOW SIDEWALL DUCT OPENING ® 8" AFF.

 CONNECT TO TWO 14-1/2" X 5-1/2" R.A. RISERS.

 LOW SIDEWALL DUCT OPENING ® 8" AFF.

 CONNECT TO ONE 14-1/2" X 3-1/2" R.A. RISERS.

 LOW SIDEWALL DUCT OPENING ® 8" AFF.

 CONNECT TO TWO 14-1/2" X 3-1/2" R.A. RISERS.

SHEET METAL AND DUCTWORK HVAC WORK SHALL BE LAID OUT WITH DUE CONSIDERATION FOR THE WORK OF OTHER TRADES. ANY CONFLICTS WHICH OCCUR DUE TO LACK OF

(CONTRACTORS) SHALL BE CORRECTED BY THE HVAC CONTRACTOR WITH NO ADDITIONAL COST TO THE OWNER. 2. INSULATE ALL DUCTWORK IN ATTIC WITH FIBERGLASS DUCT WRAP INSULATION:

COORDINATION BY THE HVAC CONTRACTOR WITH THE OTHER TRADES

R-8 MINIMUM.ALL OTHER DUCTS SHALL BE INSULATED TO A MINIMUM OF R-8. 3. FURNISH AND INSTALL UL LISTED TYPE B-VENT FROM OUTLET ON DOMESTIC WATER HEATER AND EXTEND THRU ROOF WITH TERMINATIONS AS REQUIRED BY

CODE. FURNISH AND INSTALL UL LISTED WEATHER CAP AND CONE FLASHING.

4. DUCTWORK SHALL MEET THE REQUIREMENTS OF SMACNA, NFPA 90A, OBC MECHANICAL CODE, ARTICLE 3. RECTANGULAR DUCTS SHALL BE CONSTRUCTED AND REINFORCED PER SMACNA DUCT CONSTRUCTION STANDARDS, SECTION I. ALL DUCTWORK SHALL BE SEALED IN ACCORDANCE WITH S.M.A.C.N.A. COORDINATE ALL EQUIPMENT AND DUCT RUNS WITH STRUCTURE, LIGHTS,

CEILING, CONDUIT, PIPING, AND OTHER EQUIPMENT.

MIN. 3'-0" ABOVE STRUCTURE.

FLUE SUPPORT-

SEE PLAN FOR SIZE AND

CONTINUATION.

Scale: N.T.S.

Flue Through Roof Detail

- 5. FLEXIBLE DUCTS SHALL BE 4" THRU 8" SUPPLY AIR BRANCH DUCTS AND 8" THRU 16" RETURN AIR DUCTS ONLY, AND COMPLY WITH NFPA REQUIREMENTS, PAMPHLET 90A AND SHALL BE UL LISTED WITH FLAME SPREAD RATING OF 25 OR LESS AND SMOKE DEVELOPED RATING OF 50 OR LESS. DUCT SHALL BE RATED FOR MINIMUM 10" W.G. INTERNAL WORKING PRESSURE, FOR ALL DUCT
- 6. BALANCING DAMPERS SHALL BE GALVANIZED STEEL DAMPERS WITH LOCKING QUADRANT OPERATORS,
- DUCTS, AIR HANDLERS, FILTER BOXES, AND BUILDING CAVITIES USED AS RETURN DUCTS SHALL BE SEALED, JOINTS AND SEAMS SHALL COMPLY WITH CURRENT MECHANICAL CODES, DUCT TIGHTNESS SHALL BE VERIFIED BY EITHER OF THE FOLLOWING: 7.1. POST—C
- POST-CONSTRUCTION TEST ROUGH-IN TEST EXCEPTION: DUCT TIGHTNESS TEST IS NOT REQUIRED IF THE AIR HANDLER AND ALL DUCTS ARE LOCATED WITHIN THE CONDITIONED SPACE.

----- UL LISTED VENT CAP


TALL CONE FLASHING

ROOF STRUCTURE (SEE ARCHITECTURAL)

- 1" CLEAR (MIN.)


HVAC LEGEND

DUCTWORK-INSIDE DIMENSIONS SHOWN MANUAL BALANCING DAMPER BELLMOUTH FITTING WITH DAMPER FLEXIBLE DUCTWORK SUPPLY AIR RETURN AIR / EXHAUST AIR REFRIGERANT LINE SET CONDENSATE DRAIN PIPING DIAMETER (ROUND) PROGRAMMABLE THERMOSTAT (A) 150 AIR DEVICE SYMBOL WITH CFM \bigcirc PLAN NOTE SYMBOL EQUIPMENT NOTE SYMBOL; SEE SCHEDULES AND/OR NOTES. ABOVE FINISHED FLOOR A.F.F. ABOVE CLG, CEILING FLOOR G.C. GENERAL CONTRACTOR P.C. PLUMBING CONTRACTOR H.C. HVAC CONTRACTOR F.P.C. FIRE PROTECTION CONTRACTOR E.C. ELECTRICAL CONTRACTOR S.A. SUPPLY AIR R.A. RETURN AIR OUTSIDE AIR EXH. EXHAUST

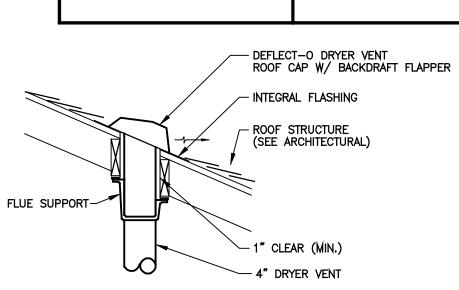

Dryer Vent Roof Cap Detail

Scale: N.T.S.

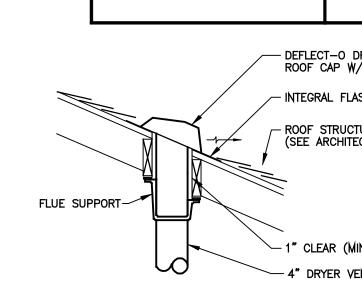



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Place Communities West Chester, Park Epcon Villas By

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Prototype	Interim Pag	e Revisions
Disk Ńo.	Revision	Date
		2/17/12

Architect Project Number 2010-005

Community Dates & Revisions 1 FEB 2015 Date Originated Permit Construction Revisions

> Drawing Title **HVAC** Schedules & Details

Architectural Style **European Country**

Sheet Number H.101 D3M - 2010

LINE. SLOPE 1/8" PER FOOT TO NEAREST DRAIN. Typical Upflow Furnace Detail Scale: N.T.S.

UPFLOW FURNACE

SEE PLAN FOR

CONTINUATION.

R.A. DUCT SIZE ON PLAN.

OPEN VENT

GAS PIPE

BY P.C.

SIDE FILTER

RACK-

FLOOR-

CONDENSATE DRAIN

-PVC EXHAUST AND

INTAKE PIPES UP TO

CONCENTRIC VENT KIT.

- REFRIGERATION LINES.

-SUPPLY AIR DUCT SIZE

-TRANSITION AS REQUIRED.

ON PLAN,


DX COIL


-OPEN VENT

— LEVELING BLOCKS

- DRAIN PAN WITH

OVERFLOW TO FD

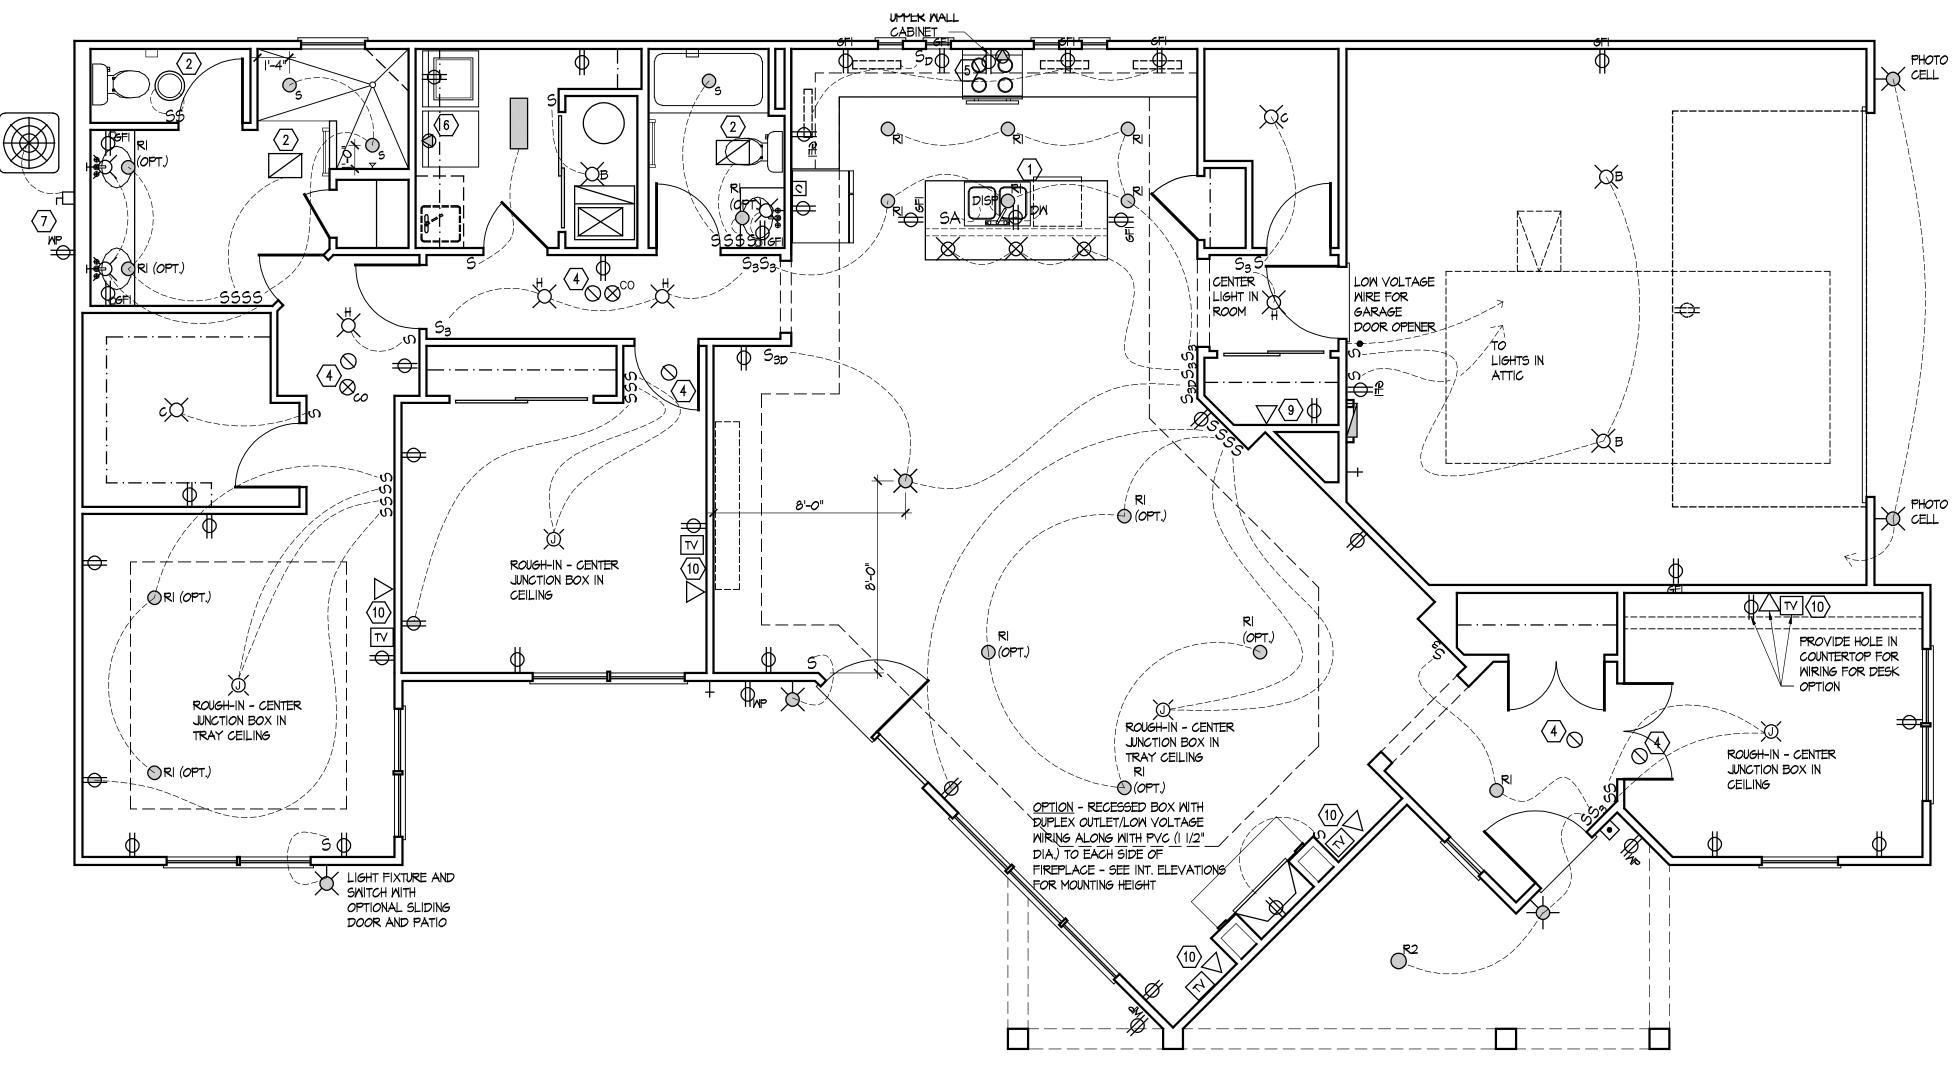

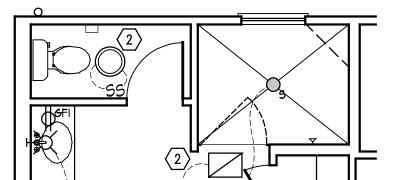

Master Bath - Optional Alternate Walk-in Shower

Scale: 1/4" = 1'-0"

Electrical Plan

Scale: 1/4" = 1'-0"

SMOKE ALARMS NOTE:

Smoke alarms must comply with Section 314 Smoke Alarms: All smoke alarms shall be listed in accordance with UL 217 and installed in accordance with the provision of this code and the household fire warning equipment provisions of NFPA 72. On each level within each dwelling unit smoke alarms utilizing photoelectric and ionization technologies shall be installed. Separate or dual-sensing smoke alarms may be used. A smoke alarm located in accordance with section 314.3(2) shall include photoelectric technology.

PLAN NOTES:

Scale: NTS

- PROVIDE #6 CU TO GROUND ROD. SERVICE PROVIDED BY UTILITY COMPANY. EC SHALL CONFIRM REQUIREMENTS WITH UTILITY
- COMPANY PRIOR TO BID. 3. I25A FUSIBLE DISCONNECT. BUILDING STEEL FOOTER REINFORCING STEEL _ -(125-30) (1) #6 CU < 120/240\ IPH 3M 125A ML*O* M (3) #1/0 AL \$ (1) #6 CU GND. IN 1-1/2" CONDUIT OR 125A SER CABLE Electrical Riser Diagram

PLAN NOTES:

- PROVIDE DUPLEX RECEPTACLE LOCATED BELOW KITCHEN SINK FOR CONNECTION OF GARBAGE DISPOSAL AND DISHMASHER, ELECTRICAL CONTRACTOR SHALL PROVIDE CORD KIT FOR GARBAGE DISPOSAL AND DISHMASHER. THE TOP HALF OF THIS RECEPTACLE SHALL BE CONTROLLED BY AN AIR BUTTON SWITCH LOCATED ON ISLAND COUNTERTOP FOR OPERATION OF THE GARBAGE DISPOSAL (BY PLIMBER). LABEL COVER PLATE SO THAT THE TOP HALF OF THE RECEPTACLE IS LABELED FOR GARBAGE DISPOSAL CONNECTION AND THE BOTTOM HALF OF THE RECEPTACLE IS LABELED FOR DISHMASHER CONNECTION.
- VERIFY EXACT LOCATIONS OF BATHROOM EXHAUST FANS WITH MECHANICAL DRAWINGS. HVAC CONTRACTOR SHALL SUPPLY AND INSTALL EXHAUST FAN AND DUCTING, WIRING BY ELECTRICAL CONTRACTOR.
- PROVIDE ELECTRICAL CONNECTION AND SAFETY SWITCH FOR FURNACE. VERIFY EXACT REQUIREMENTS WITH MANUFACTURERS NAMEPLATE.
- PROVIDE 120 VOLT SMOKE ALARM WITH 9 VOLT BATTERY BACK-UP. SMOKE ALARMS SHALL BE CONNECTED TOGETHER SO THAT WHEN ONE SMOKE ALARM WITHIN A RESIDENCE SOUNDS, ALL SMOKE ALARMS WITHIN THAT RESIDENCE
- 5. PROVIDE 120/240 VOLT RANGE RECEPTACLE. THIS RECEPTACLE MUST BE PROVIDED WITH A GROUNDED CONDUCTOR AND AN EQUIPMENT GROUNDING CONDUCTOR PER THE NATIONAL ELECTRICAL CODE.
- PROVIDE 120/240 YOLT DRYER RECEPTACLE FOR DRYER UNIT. THIS RECEPTACLE MUST BE PROVIDED WITH A GROUNDED CONDUCTOR AND AN EQUIPMENT GROUNDING CONDUCTOR PER THE NATIONAL ELECTRICAL CODE. PROVIDE A DUPLEX RECEPTACLE FOR WASHER.
- PROVIDE ELECTRICAL CONNECTION AND DISCONNECT SMITCH FOR HEAT PUMP. VERIFY EXACT REQUIREMENTS WITH MANUFACTURERS NAMEPLATE.
- PROVIDE ELECTRICAL CONNECTION AND SAFETY SWITCH FOR WATER HEATER. VERIFY EXACT REQUIREMENTS WITH MANUFACTURERS NAMEPLATE.
- 9. COAX/CATY HOME RUN LOCATION (75" A.F.F.).
- IO. ALL TV LOCATIONS TO RECEIVE A SINGLE GANG BOX WITH COAX/CATV

GENERAL NOTES:

- A. ALL WORK SHALL MEET OR EXCEED THE MOST CURRENT EDITION OF THE NATIONAL ELECTRICAL CODE, STATE CODE(S) AND LOCAL CODE(S). ELECTRICAL CONTRACTOR SHALL FURNISH ALL LABOR, MATERIALS, APPLIANCES, EQUIPMENT, TOOLS, SUPERINTENDENCE, AND SERVICES AS REQUIRED TO PROVIDE ELECTRICAL WORK AS SPECIFIED OR AS INTENDED ON
- ELECTRICAL CONTRACTOR SHALL VISIT THE SITE TO FAMILIARIZE THEMSELVES WITH THE SCOPE OF THE PROJECT PRIOR TO BID.
- ELECTRICAL CONTRACTOR MUST VERIFY THE MOUNTING HEIGHTS OF ALL DEVICES WITH ARCHITECTURAL DRAWINGS PRIOR TO ROUGH-IN. ALL SWITCHES, RECEPTACLES, ETC. AND COVER PLATES SHALL BE WHITE IN COLOR.
- ELECTRICAL CONTRACTOR SHALL INSTALL ALL WIRING IN ACCORDANCE WITH THE CURRENT EDITIONS OF THE NATIONAL AND LOCAL ELECTRICAL CODES.
- ALL RECEPTACLES LOCATED OUTSIDE SHALL BE GFCI TYPE AND SHALL HAVE
- IN ALL AREAS SPECIFIED IN NEC 210.52, ALL 15 AND 20 AMP, 120 VOLT RECEPTACLES SHALL BE LISTED TAMPER-RESISTANT RECEPTACLES.

WEATHERPROOF IN-USE COVERS.

- ELECTRICAL CONTRACTOR SHALL PROVIDE SAFETY SWITCHES FOR ALL HVAC AND PLUMBING EQUIPMENT IN ACCORDANCE WITH THE NATIONAL ELECTRICAL
- DEVICES INSTALLED IN FIRE SEPARATION WALLS/CEILINGS SHALL BE INSTALLED IN ACCORDANCE WITH THE LISTING AND LABELING OF THE RATED ASSEMBLY. DO NOT INSTALL OUTLET BOXES WITHIN THE SAME STUD SPACE.
- SMOKE ALARMS SHALL BE CONNECTED TOGETHER SO THAT WHEN ONE SMOKE ALARM WITHIN A RESIDENCE SOUNDS, ALL SMOKE ALARMS WITHIN THAT RESIDENCE SOUND. SMOKE ALARMS SHALL NOT BE INSTALELD CLOSER THAN 3' IN FRONT OF HVAC SUPPLY GRILLES.
- LIGHT FIXTURES INSTALLED IN CLOSETS SHALL CONFORM TO NEC ARTICLE
- KITCHEN COUNTERTOP RECEPTACLES AND BATHROOM RECEPTACLES SHALL BE GFCI PROTECTED VIA CLASS A GFCI TYPE CIRCUIT BREAKER. PROVIDE CLASS A GFCI CIRCUIT BREAKERS EACH TELEPHONE OUTLET LOCATION SHALL BE PROVIDED WITH (1) CATEGORY
- DEMANCATION LOCATION. EACH CABLE TY OUTLET LOCATION SHALL BE PROVIDED WITH (I) RG6 VIDEO

5E CABLE. PROVIDE FACEPLATE WITH (2) RJ-45 PORTS, ROUTE CABLES TO

- CABLE. PROVIDE FACEPLATE WITH (I) MALE PORT. ROUTE CABLES TO
- ALL SERVICE MAINS SHALL BE IDENTIFIED IN FIELD.
- EQUIPMENT, PANELS, SPECIAL DEVICE PLATES, AND SIMILAR MATERIAL SHALL BE CLEARLY MARKED. SIZE OF LETTERING AND WORDING SHALL BE APPROVED BY THE OWNERS REPRESENTATIVE. PROVIDE TYPEWRITTEN DIRECTORIES IN PANELS, AND WHERE OTHERWISE REQUIRED, WITH CLEAR PLASTIC PROTECTION SHEILDS AND MOUNTED IN CARD HOLDERS.
- PROPERLY GROUND ALL ELECTRICAL SYSTEMS AND EQUIPMENT IN ACCORDANCE WITH NEC REQUIREMENTS. ALL SPECIAL SYSTEMS TO BE GROUNDED PER NEC 800.100(D).
- SWITCHES SHALL BE SPECIFICATION GRADE, MIN. 15A, #1221, 120/277V, MANUFACTURERED BY HUBBELL, BRYANT, SLATER, LEVITON OR EQUAL.
- DUPLEX CONVENIENCE RECEPTACLES SHALL BE SPECIFICATION GRADE, MIN. 15A, 125Y, 2P, 3W, GROUNDING TYPE #5362, NEMA 5-20R, MANUFACTURED BY HUBBELL, BRYANT, SLATER, LEVITON, OR EQUAL.
- ELECTRICAL CONTRACTOR SHALL ROUGH-IN APPROPRIATE WIRING, ETC. TO RETROFIT THIS HOME WITH SMOKE DETECTORS WITH HORN AND STROBE, TTY TELEPHONES, AND DOORBELL WITH CHIME AND FLASHING LIGHT. THE ANNULAR SPACE AROUND ALL PENETRATIONS IN GYPSUM BOARDS,
- ALL LIGHTING FIXTURES SHALL BE SUPPLIED BY THE OWNER AND INSTALLED BY THE ELECTRICAL CONTRACTOR.

INCLUDING WIRING AND ELECTRICAL BOXES, SHALL BE SEALED TIGHT.

- ALL BEDROOM OUTLETS TO HAVE "COMBINATION-TYPE" ARC FAULT
- A MINIMUM OF 50% OF THE LAMPS IN PERMANENTLY INSTALLED LIGHTING FIXTURES SHALL BE HIGH EFFICACY LAMPS.
- A CARBON MONOXIDE DETECTOR SHALL BE PLACED OUTSIDE EACH SLEEPING AREA, IN THE IMMEDIATE VICINITY OF THE BEDROOMS.

	ELECTRICAL LEGE	ND / LIGI	HT FIXTURE SCHEDULE
ф	DUPLEX RECEPTACLE OUTLET	•	DOOR PUSH BUTTON
#	QUADRUPLEX RECEPTACLE OUTLET	<u></u>	DIRECT WIRE APPLIANCE
$\phi_{\scriptscriptstyle{\!\mathcal{G}\!F\!I}}$	DUPLEX RECEPTACLE OUTLET WITH GROUND FAULT INTERRUPTER (GFI)		RECESSED MINI INCANDESCENT DOWN LIGHT FIXTURE
Ж.	DUPLEX RECEPTACLE OUTLET WITH	Os	SHOWER LIGHT
WMP	WATERPROOF COVER \$ GFI	O_{RI}	RECESSED INCANDESCENT DOWN LIGHT FIXTURE
ф	DUPLEX RECEPTACLE OUTLET - SMITCH TOP OUTLET	\bigcirc_{R2}	RECESSED INCANDESCENT EXTERIOR DOWN LIGHT FIXTURE
ф	DUPLEX RECEPTACLE OUTLET- SPECIAL	O _{sc}	RECESSED INCANDESCENT FIXTURE (SLOPED CEILING)
\triangle	TELEPHONE OUTLET (CATEGORY 5 WIRE TO ALL PHONE LOCATIONS)	Φ	RECESSED INCANDESCENT EYEBALL FIXTURE
\triangle	DATA COMMUNICATIONS OUTLET	χc	SURFACE MOUNTED INCANDESCENT FIXTURE - CLOSETS
<i>─</i>	SMOKE DETECTOR	ЖH	SURFACE MOUNTED INCANDESCENT FIXTURE - HALLWAYS
s	SINGLE POLE SMITCH	$\not\longmapsto\!$	EXTERIOR INCANDESCENT WALL BRACKET FIXTURE
s ₃	THREE-WAY SMITCH	$\not\!$	INTERIOR INCANDESCENT WALL SCONCE
s ₄	FOUR-MAY SMITCH	Дв	KEYLESS PORCELAIN LAMP HOLDER
SD	DIMMER SMITCH	\bowtie	PENDANT FIXTURE - OPTIONAL
s _R	REMOTE SMITCH FOR LIGHT \$ 3-SPEED FAN CONTROL	X	CHANDELIER FIXTURE
SA	SINGLE POLE AIR BUTTON SWITCH FOR ALL KITCHEN SINK DISPOSALS (PLUMBER TO LOCATE ON ISLAND)		SURFACE MOUNTED FLUORESCENT FIXTURE
TV	CABLE TY OUTLET		SURFACE MOUNTED FLUORESCENT FIXTURE
<u> </u>	120/240 VOLT RECEPTACLE- SEE		EXHAUST FAN
_	ELECTRICAL PLAN NOTES JUNDER-CABINET LIGHTING -		EXHAUST FAN - LIGHT
	STANDARD (OPTIONAL LED	Ŏ	JUNCTION BOX FOR CEILING FAN

Panel "A"					
	СКТ	СКТ	СКТ	СКТ	
LOAD SERVED	#	BKR	BKR	#	LOAD SERVED
* MSTR BEDROOM	1	15	15	2	REFRIGERATOR
* BEDROOM 2	3	15	15	4	DISPOSAL
BATHROOMS	5	20	20	6	DISHWASHER
* GENERAL LTG	7	15		8	
* KITCHEN LTG	9	15	50	10	RANGE
GARAGE REC	11	15	20	12	KITCHEN REC
EXTERIOR REC	13	20	20	14	KITCHEN REC
WATER HTR	15	15	20	16	KITCHEN REC
FURNACE	17	15	15	18	* GENERAL REC
DDVED	19		15	20	* SITTING RM
DRYER	21	30	π	22	CONDENGOD
WASHER	23	20	40	24	CONDENSOR
* 4 SEASONS RM/DEN	25	15	15	26	SMOKE DETECTORS
SPARE	27	15		28	
	29			30	
	31			32	
	33			34	
	35			36	
	37			38	
	39			40	
	41			42	
	125A	MAIN	LUG	ONLY	,

CARBON MONOXIDE DETECTOR

* PROVIDE ARC FAULT BREAKER

TAPE/TRANSFORMERS).

DOOR CHIME

** PROVIDE BREAKER TIE FOR THESE TWO CIRCUITS

F	Panel "A" LOAD CALCS	3	
.IGHTING:	LOAD SERVED		
2103 SQUARE FEET	6309	VA	
APPLIANCES:			
(2) APPLIANCE CC1	S @ 1500VA EACH	3000	VA
DISHWASHER	-	1200	VA
DISPOSAL		750	VA
WASHER		1500	VA
DRYER		5000	VA
RANGE		8800	VA
WATER HEATER		180	
REFRIGERATOR		750	
FURNACE	_	500	
	FIXED LOAD + LIGHTS	27989	VA
IRST 10KW @ 100%		10000	VA
EMAINING KW @ 40%		7195.6	VA
	TOTAL WITHOUT HVAC	17195.6	VA
IVAC LOAD:			
AC		5914	VA
	LARGEST LOAD	5914	VA
	TOTAL DEMAND LOAD	23109.6	VA
120/240V 1PH 3W			AMPS
	UTILIZE 125AMP SERVICE		

Where Life Comes Together Place ommunitie ark

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at

Villa

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THESE DRAWINGS SHALL BE USED IN CONFORMANCE WITH ALL LOCAL BUILDING, MECHANICAL, PLUMBING AND ELECTRICAL CODES AND SHALL MEET THE REQUIREMENTS OF THE HEALTH DEPARTMENT, FIRE MARSHALL, AMERICANS WITH DISABILITIES ACT ACCESSIBILITY GUIDELINES (ADAAG), THE FAIR HOUSING ACT ACCESSIBILITY GUIDELINES (FHAAG), AND SHALL BE CONSTRUCTED IN CONFORMANCE WITH STATE AND LOCAL

Prototype	Interim Pag	e Revisions
Disk Ńo.	Revision	Date
		3/12/12

ENERGY REQUIREMENTS.


Architect Project Number 2010-005

Community Dates & Revisions Date Originated 1 FEB 2015 Permit Construction Revisions

> **Drawing Title Electrical Plan**

Architectural Style **European Country**

> **Sheet Number** D3M - 2010

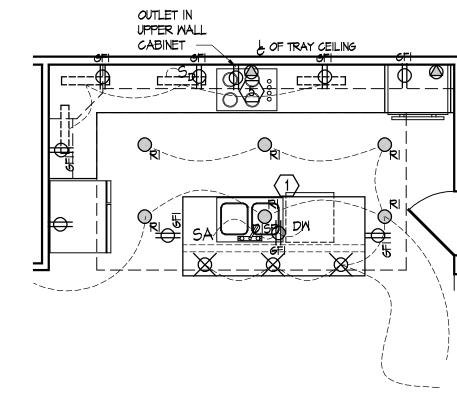

Electrical Plan - Deluxe Kitchen

Scale: 1/4" = 1'-0"

Panel "A"							
	СКТ	СКТ	СКТ	СКТ			
LOAD SERVED	#	BKR	BKR	#	LOAD SERVED		
* MSTR BEDROOM	1	45	45	2	REFRIGERATOR		
	1	15	15	-		_	**
* BEDROOM 2	3	15	15	4	DISPOSAL		**
BATHROOMS	5	20	20	6	DISHWASHER		
* GENERAL LTG	7	15	50	8	DOUBLE OVENS		
* KITCHEN LTG	9	15		10	DOODLE OVENO		
GARAGE REC	11	15	50	12	СООКТОР		
EXTERIOR REC	13	20	انا	14	COOKTOP		
WATER HTR	15	15	20	16	KITCHEN REC		
FURNACE	17	15	20	18	KITCHEN REC		
DDVED	19	20	20	KITCHEN REC			
DRYER	21	30	15	22	* GENERAL REC		
WASHER	23	20	15	24	* SITTING RM		
* 4 SEASONS RM/DEN	25	15	40	26	CONDENSOR		
SPARE	27	15	40	28	CONDENSOR		
	29		15	30	SMOKE DETECTORS		
	31			32			
	33			34			
	35			36			
	37			38			
	39			40			
	41			42			
	125A	ΜΔΙΝ	HIG	ONI ∨	,		
SERVICE FEEDER SIZE	120/1	IAINZIIA	1	CITE	SEE RISER		

- * PROVIDE ARC FAULT BREAKER
- ** PROVIDE BREAKER TIE FOR THESE TWO CIRCUITS

GHTING:		LOAD SERVED				
2103 SQUARE FEE	2103 SQUARE FEET @ 3VA EACH					
PPLIANCES:						
(2) APPLIANCE CC	ΓS @ 1500VA EACH	3000	VA			
DISHWASHER		1200	VA			
DISPOSAL		750	VA			
WASHER		1500				
DRYER		5000				
OVENS / COOKTOF)	11000				
WATER HEATER		180				
REFRIGERATOR		750				
FURNACE	FIXED LOAD + LIGHTS	500 30189				
		33.00	•••			
RST 10KW @ 100%		10000	VA			
MAINING KW @ 40%		8075.6	VA			
	TOTAL WITHOUT HVAC	18075.6	VA			
AC LOAD:						
AC		5914	VA			
	LARGEST LOAD	5914	VA			
	TOTAL DEMAND LOAD	23989.6	VA			
120/240V 1PH 3W		100	AMPS			
	UTILIZE 125AMP SERVICE					

PLAN NOTES:

- PROVIDE DUPLEX RECEPTACLE LOCATED BELOW KITCHEN SINK FOR CONNECTION OF GARBAGE DISPOSAL AND DISHWASHER. ELECTRICAL CONTRACTOR SHALL PROVIDE CORD KIT FOR GARBAGE DISPOSAL AND DISHWASHER. THE TOP HALF OF THIS RECEPTACLE SHALL BE CONTROLLED ! AN AIR BUTTON SWITCH LOCATED ON ISLAND COUNTERTOP FOR OPERATION (THE GARBAGE DISPOSAL (BY PLUMBER). LABEL COVER PLATE SO THAT THE TOP HALF OF THE RECEPTACLE IS LABELED FOR GARBAGE DISPOSAL CONNECTION AND THE BOTTOM HALF OF THE RECEPTACLE IS LABELED FOR DISHMASHER CONNECTION.
- VERIFY EXACT LOCATIONS OF BATHROOM EXHAUST FANS WITH MECHANICAL DRAWINGS. HVAC CONTRACTOR SHALL SUPPLY AND INSTALL EXHAUST FAN AND DUCTING, WIRING BY ELECTRICAL CONTRACTOR.
- 3. PROVIDE ELECTRICAL CONNECTION AND SAFETY SMITCH FOR FURNACE. VERIFY EXACT REQUIREMENTS WITH MANUFACTURERS NAMEPLATE.
- 4. PROVIDE 120 VOLT SMOKE ALARM WITH 9 VOLT BATTERY BACK-UP. SMOKE ALARMS SHALL BE CONNECTED TOGETHER SO THAT WHEN ONE SMOKE ALAR WITHIN A RESIDENCE SOUNDS, ALL SMOKE ALARMS WITHIN THAT RESIDENCE
- PROVIDE 120/240 VOLT RANGE RECEPTACLE. THIS RECEPTACLE MUST BE PROVIDED WITH A GROUNDED CONDUCTOR AND AN EQUIPMENT GROUNDING CONDUCTOR PER THE NATIONAL ELECTRICAL CODE.
- 6. PROVIDE 120/240 VOLT DRYER RECEPTACLE FOR DRYER UNIT. THIS RECEPTACLE MUST BE PROVIDED WITH A GROUNDED CONDUCTOR AND AN EQUIPMENT GROUNDING CONDUCTOR PER THE NATIONAL ELECTRICAL CODE. PROVIDE A DUPLEX RECEPTACLE FOR WASHER.
- PROVIDE ELECTRICAL CONNECTION AND DISCONNECT SWITCH FOR HEAT PUMP VERIFY EXACT REQUIREMENTS WITH MANUFACTURERS NAMEPLATE.
- PROVIDE ELECTRICAL CONNECTION AND SAFETY SWITCH FOR MATER HEATER VERIFY EXACT REQUIREMENTS WITH MANUFACTURERS NAMEPLATE.
- 9. COAX/CATY HOME RUN LOCATION (75" A.F.F.).
- IO. ALL TY LOCATIONS TO RECEIVE A SINGLE GANG BOX WITH COAX/CATY

GENERAL NOTES:


- A. ALL WORK SHALL MEET OR EXCEED THE MOST CURRENT EDITION OF THE NATIONAL ELECTRICAL CODE, STATE CODE(S) AND LOCAL CODE(S). ELECTRICAL CONTRACTOR SHALL FURNISH ALL LABOR, MATERIALS, APPLIANCES, EQUIPMENT, TOOLS, SUPERINTENDENCE, AND SERVICES AS REQUIRED TO PROVIDE ELECTRICAL WORK AS SPECIFIED OR AS INTENDED O THESE DRAWINGS.
- ELECTRICAL CONTRACTOR SHALL VISIT THE SITE TO FAMILIARIZE THEMSELVI WITH THE SCOPE OF THE PROJECT PRIOR TO BID.
- ELECTRICAL CONTRACTOR MUST VERIFY THE MOUNTING HEIGHTS OF ALL DEVICES WITH ARCHITECTURAL DRAWINGS PRIOR TO ROUGH-IN. ALL SWITCHE RECEPTACLES, ETC. AND COVER PLATES SHALL BE WHITE IN COLOR.
- ELECTRICAL CONTRACTOR SHALL INSTALL ALL WIRING IN ACCORDANCE WITH THE CURRENT EDITIONS OF THE NATIONAL AND LOCAL ELECTRICAL CODES.
- E. ALL RECEPTACLES LOCATED OUTSIDE SHALL BE GFCI TYPE AND SHALL HAV
- WEATHERPROOF IN-USE COVERS. IN ALL AREAS SPECIFIED IN NEC 210.52, ALL 15 AND 20 AMP, 120 VOLT

RECEPTACLES SHALL BE LISTED TAMPER-RESISTANT RECEPTACLES.

- ELECTRICAL CONTRACTOR SHALL PROVIDE SAFETY SWITCHES FOR ALL HYA AND PLUMBING EQUIPMENT IN ACCORDANCE WITH THE NATIONAL ELECTRICAL
- H. DEVICES INSTALLED IN FIRE SEPARATION WALLS/CEILINGS SHALL BE INSTALLED IN ACCORDANCE WITH THE LISTING AND LABELING OF THE RATED
- ASSEMBLY. DO NOT INSTALL OUTLET BOXES WITHIN THE SAME STUD SPACE. SMOKE ALARMS SHALL BE CONNECTED TOGETHER SO THAT WHEN ONE SMOKE ALARM WITHIN A RESIDENCE SOUNDS, ALL SMOKE ALARMS WITHIN THAT RESIDENCE SOUND. SMOKE ALARMS SHALL NOT BE INSTALELD CLOSER THAN 3' IN FRONT OF HVAC SUPPLY GRILLES.
- LIGHT FIXTURES INSTALLED IN CLOSETS SHALL CONFORM TO NEC ARTICLE
- K. KITCHEN COUNTERTOP RECEPTACLES AND BATHROOM RECEPTACLES SHALL BE GFCI PROTECTED VIA CLASS A GFCI TYPE CIRCUIT BREAKER. PROVIDE CLASS A GFCI CIRCUIT BREAKERS
- EACH TELEPHONE OUTLET LOCATION SHALL BE PROVIDED WITH (I) CATEGORY 5E CABLE. PROVIDE FACEPLATE WITH (2) RJ-45 PORTS, ROUTE CABLES TO DEMANCATION LOCATION.
- M. EACH CABLE TY OUTLET LOCATION SHALL BE PROYIDED WITH (1) RG6 VIDEO CABLE. PROVIDE FACEPLATE WITH (I) MALE PORT. ROUTE CABLES TO
- N. ALL SERVICE MAINS SHALL BE IDENTIFIED IN FIELD.
- EQUIPMENT, PANELS, SPECIAL DEVICE PLATES, AND SIMILAR MATERIAL SHALL BE CLEARLY MARKED. SIZE OF LETTERING AND WORDING SHALL BE APPROVED BY THE OWNERS REPRESENTATIVE. PROVIDE TYPEWRITTEN DIRECTORIES IN PANELS, AND WHERE OTHERWISE REQUIRED, WITH CLEAR PLASTIC PROTECTION SHEILDS AND MOUNTED IN CARD HOLDERS.
- P. PROPERLY GROUND ALL ELECTRICAL SYSTEMS AND EQUIPMENT IN ACCORDANCE WITH NEC REQUIREMENTS. ALL SPECIAL SYSTEMS TO BE GROUNDED PER NEC 800.100(D).
- Q. SWITCHES SHALL BE SPECIFICATION GRADE, MIN. 15A, #1221, 120/277V, MANUFACTURERED BY HUBBELL, BRYANT, SLATER, LEVITON OR EQUAL.
- R. DUPLEX CONVENIENCE RECEPTACLES SHALL BE SPECIFICATION GRADE, MIN. 15A, 125V, 2P, 3M, GROUNDING TYPE #5362, NEMA 5-20R, MANUFACTURED BY HUBBELL, BRYANT, SLATER, LEVITON, OR EQUAL.
- ELECTRICAL CONTRACTOR SHALL ROUGH-IN APPROPRIATE WIRING, ETC. TO RETROFIT THIS HOME WITH SMOKE DETECTORS WITH HORN AND STROBE, TTY TELEPHONES, AND DOORBELL WITH CHIME AND FLASHING LIGHT.
- THE ANNULAR SPACE AROUND ALL PENETRATIONS IN GYPSUM BOARDS, INCLUDING WIRING AND ELECTRICAL BOXES, SHALL BE SEALED TIGHT.
- U. ALL LIGHTING FIXTURES SHALL BE SUPPLIED BY THE OWNER AND INSTALLED BY THE ELECTRICAL CONTRACTOR.
- ALL BEDROOM OUTLETS TO HAVE "COMBINATION-TYPE" ARC FAULT INTERRUPTING CIRCUITS.
- W. A MINIMUM OF 50% OF THE LAMPS IN PERMANENTLY INSTALLED LIGHTING FIXTURES SHALL BE HIGH EFFICACY LAMPS.
- A CARBON MONOXIDE DETECTOR SHALL BE PLACED OUTSIDE EACH SLEEPING AREA, IN THE IMMEDIATE VICINITY OF THE BEDROOMS.

ф	DUPLEX RECEPTACLE OUTLET	•	DOOR PUSH BUTTON
#	QUADRUPLEX RECEPTACLE OUTLET	0	DIRECT WIRE APPLIANCE
Φ _{σFI}	DUPLEX RECEPTACLE OUTLET WITH GROUND FAULT INTERRUPTER (GFI)		RECESSED MINI INCANDESCENT DOWN LIGHT FIXTUR
D _{MP}	DUPLEX RECEPTACLE OUTLET WITH	Os	SHOWER LIGHT
1 Mb	WATERPROOF COVER & GFI	\bigcirc_{RI}	RECESSED INCANDESCENT DOWN LIGHT FIXTURE
þ	DUPLEX RECEPTACLE OUTLET - SWITCH TOP OUTLET	O_{R2}	RECESSED INCANDESCENT EXTERIOR DOWN LIGHT FIXTURE
	DUPLEX RECEPTACLE OUTLET- SPECIAL	O _{sc}	RECESSED INCANDESCENT FIXTURE (SLOPED CEILIN
\triangle	TELEPHONE OUTLET (CATEGORY 5 WIRE TO ALL PHONE LOCATIONS)	Ф	RECESSED INCANDESCENT EYEBALL FIXTURE
\triangle	DATA COMMUNICATIONS OUTLET	χc	SURFACE MOUNTED INCANDESCENT FIXTURE - CLOSETS
2	SMOKE DETECTOR	ЖH	SURFACE MOUNTED INCANDESCENT FIXTURE - HALLWAYS
S	SINGLE POLE SMITCH	$\not\!$	EXTERIOR INCANDESCENT WALL BRACKET FIXTURE
5 3	THREE-WAY SMITCH	$\not\!$	INTERIOR INCANDESCENT WALL SCONCE
s ₄	FOUR-WAY SMITCH	Дв	KEYLESS PORCELAIN LAMP HOLDER
s _D	DIMMER SWITCH	\bowtie	PENDANT FIXTURE - OPTIONAL
SR	REMOTE SMITCH FOR LIGHT \$ 3-SPEED FAN CONTROL	X	CHANDELIER FIXTURE
SA	SINGLE POLE AIR BUTTON SWITCH FOR ALL KITCHEN SINK DISPOSALS (PLUMBER TO LOCATE ON ISLAND)		SURFACE MOUNTED FLUORESCENT FIXTURE
TV	CABLE TV OUTLET		SURFACE MOUNTED FLUORESCENT FIXTURE
— ⊘	120/240 VOLT RECEPTACLE- SEE		EXHAUST FAN
	ELECTRICAL PLAN NOTES JUNDER-CABINET LIGHTING -		EXHAUST FAN - LIGHT
	STANDARD (OPTIONAL LED TAPE/TRANSFORMERS).	Ø	JUNCTION BOX FOR CEILING FAN
	DOOR CHIME	$\overset{co}{\otimes}$	CARBON MONOXIDE DETECTOR

PLAN NOTES:

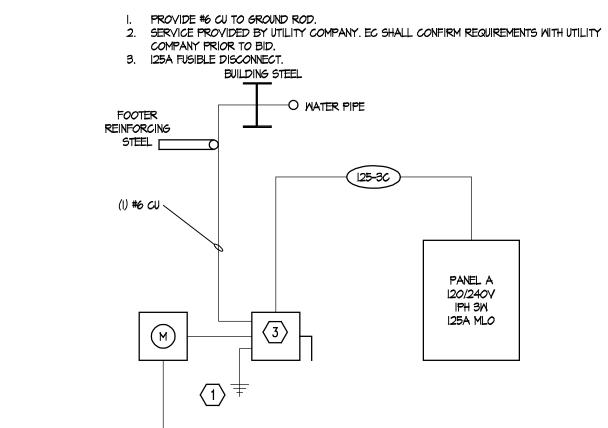

(3) #1/0 AL & (1) #6 CU GND. IN 1-1/2" CONDUIT OR 125A SER CABLE Electrical Riser Diagram

Scale: NTS



Where Life Comes Together

Place ommunities ark at Epcon Villas ark

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ENERGY REQUIREMENTS.

Prototype	Interim Pag	e Revisions
Disk No.	Revision	Date
		2/17/12

Architect Project Number

2010-005

Community Dates & Revisions Date Originated 1 FEB 2015 Permit Construction Revisions

Drawing Title

Electrical Plan Deluxe Kitchen

Architectural Style **European Country**

Sheet Number D3M - 2010