BUILDING TYPE Promenade (D3 - 2010)

8338 Park Place, West Chester, OH 45069 - Lot #171 Epcon Communities - Villas at Park Place

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BUILDING D-3

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GENERAL NOTES

1. ALL WORK, SHALL COMPLY WITH APPLICABLE STATE AND LOCAL BUILDING CODES AND THE BUILDING STANDARDS REFERENCED THEREIN.

2. ALL WORK SHALL CONFORM TO THE HIGHEST LEVELS OF THE APPROPRIATE INDUSTRY STANDARDS FOR CUSTOM WORK.

3. ALL WORK TO BE COORDINATED AND SCHEDULED BY THE OWNER.

4. FRAMING LUMBER IN CONTACT WITH CONCRETE OR MASONRY, OR EXPOSED TO THE EXTERIOR SHALL BE PRESERVATIVE PRESSURE TREATED.

5. PLAN DIMENSIONS ARE TO FACE OF ROUGH FRAMING OR MASONRY UNLESS NOTED OTHERWISE. DIMENSIONS TO EXTERIOR WALLS INCLUDE 7/16" EXT. SHEATHING, ROUNDED TO THE NEAREST 1/4".

6. FINISH FLOOR ELEV. @ FIRST FLOOR LEVEL IS SET AT 100'-0". SEE SITE PLAN FOR ACTUAL FIRST FLOOR ELEVATION @ EACH BUILDING.

7. ALL INTERIOR PARTITIONS SHALL BE 2 x 4 STUDS @ 16" O.C. WITH 1/2" DRYWALL EACH SIDE. PLAN DIMENSION IS ASSUMED TO BE 3 1/2" UNLESS NOTED OTHERWISE. PROVIDE SOLID LUMBER BLOCKING FOR ALL WALL MOUNTED ITEMS.

8. ALL DRYWALL IN WET AREAS, AND AS A SUBSTRATE FOR TILE, SHALL BE MOISTURE RESISTANT 1/2" WATERBOARD OR GREENBOARD.

9. ALL INTERIOR COLORS AND FINISHES, NOT SPECIFIED HEREIN, TO BE SELECTED BY THE OWNER.

Condominium



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Park Place West Chester, LLC (513) 868-9800

CODE REVIEW INFORMATION

GOVERNING BUILDING CODE: 2013 RESIDENTIAL CODE OF OHIO

WOOD FRAME CONSTRUCTION TYPE: NUMBER OF STORIES: 1 STORY

2,488 SF TOTAL AREA - FIRST FLOOR **BUILDING AREAS:**

GENERAL BUILDING INFORMATION

THIS BUILDING IS A $\,$ (1) UNIT SINGLE FAMILY DWELLING STRUCTURE. THE DWELLING UNIT CONTAINS:

1,995 SF OF LIVING SPACE AND 493 SF GARAGE IN EACH UNIT. TOTAL = 2,488 SF. THE TYPE D-3 UNIT IS A SINGLE STORY DESIGN.

THE "EXTENDED GARAGE" OPTION HAS 2,013 SF OF LIVING SPACE AND 561 SF GARAGE.

THE OPTIONS BELOW WILL EACH ADD THE FOLLOWING SQUARE **FOOTAGE:**

SITTING ROOM - 105 SF

EXTENDED MASTER SUITE - 189 SF

NOTES: 1. All Wall Insulation to be R-15, not R-13.

2. Drywall Ceiling area, except in garage, to be 1/2", not 5/8".

3. Builder may switch gas to Duke standard pressure (in lieu of 2 lb.), thereby increasing interior lines to 1" CSST and eliminating regulator.

GENERAL SPECIFICATIONS

THE STRUCTURE IS DESIGNED TO BE SELF-SUPPORTING AND STABLE AFTER THE BUILDING IS FULLY COMPLETE. IT IS SOLELY THE CONTRACTORS RESPONSIBILITY TO INSURE THE SAFETY OF THE BUILDING AND ITS COMPONENT PARTS DURING ERECTION. THIS INCLUDES THE ADDITION OF TEMPORARY BRACING OR GUYS THAT MIGHT BE NECESSARY.

2. IT IS SOLELY THE CONTRACTOR'S RESPONSIBILITY TO FOLLOW ALL APPLICABLE SAFETY CODES AND REGULATIONS DURING ALL PHASES OF CONSTRUCTION.

3. THIS STRUCTURE IS DESIGNED TO RESIST THE FOLLOWING MINIMUM UNIFORMLY DISTRIBUTED LIVE LOADS:

ATTICS WITHOUT STORAGE ATTICS WITH LIMITED STORAGE 20 PSF HABITABLE ATTICS 30 PSF ATTICS WITH FIXED STAIRS 30 PSF BALCONIES & DECKS 40 PSF ROOMS OTHER THAN SLEEPING ROOMS SLEEPING ROOMS STAIRS 25 PSF (GROUND SNOW LOAD) CEILING JOISTS (HIGH SLOPE RAFTERS)

CEILING JOISTS (LOW SLOPE/NO STORAGE) IO PSF

90 MPH (3 SECOND GUST), EXP. B

STRUCTURAL CONCRETE: FOOTINGS, INTERIOR SLABS F'C = 3000 PSI

EXPOSED WALLS, GARAGE SLABS AND EXTERIOR SLABS ON GRADE F'C = 4000 PSI (5%-7% ENTRAINED AIR) ALL DEFORMED REINFORCING BARS FY = 60,000 PSI

2. CONCRETE TO BE MIXED AND PLACED PER ACI SPECIFICATIONS.

MASONRY VENEER SHALL BE ANCHORED TO THE SUPPORTING WALL WITH CORROSION-RESISTANT METAL TIES EMBEDDED IN MORTAR OR GROUT, AND EXTENDING INTO THE VENEER A MINIMUM OF 1-1/2", WITH NOT LESS THAN 5/8"MORTAR OR GROUT COVER TO OUTSIDE FACE.

2. WHERE VENEER IS ANCHORED TO WOOD BACKINGS BY CORRUGATED SHEET METAL TIES, THE DISTANCE SEPARATING THE VENEER FROM THE SHEATHING MATERIAL SHALL BE A MAXIMUM OF I".

3. SHEET METAL TIES SHALL BE NOT LESS THAN NO. 22 U.S. GAGE BY 1/8" CORRUGATED. EACH TIE SHALL BE SPACED NOT MORE THAN 24" ON CENTER HORIZONTALLY AND VERTICALLY, AND SHALL SUPPORT NOT MORE THAN 2.67 SF OF

4. ADDITIONAL TIES SHALL BE PROVIDED AROUND ALL WALL OPENINGS GREATER THAN 16" IN EITHER DIMENSION. METAL TIES AROUND THE PERIMETER OF OPENINGS SHALL BE SPACED NOT MORE THAN 3'-O" O.C., AND PLACED WITHIN 12" OF THE WALL OPENING.

VINYL SIDING SHALL BE CERTIFIED AND LABELED AS CONFORMING TO THE REQUIREMENTS OF ASTM D 3679 BY AN APPROVED QUALITY CONTROL AGENCY. 2. VINYL SIDING, SOFFIT, AND ACCESSORIES SHALL BE INSTALLED IN ACCORDANCE WITH THE MANUFACTURER'S

3. SOFFIT PANELS SHALL BE INDIVIDUALLY FASTENED TO A SUPPORTING COMPONENT SUCH AS A NAILING STRIP, FASCIA, OR SUBFASCIA COMPONENT, OR AS SPECIFIED BY THE MANUFACTURER.

ASPHALT SHINGLES

INSTALLATION INSTRUCTIONS.

SHINGLE PACKAGING SHALL BEAR A LABEL TO INDICATE COMPLIANCE TO:

ASPHALT SHINGLES SHALL BE TESTED IN ACCORDANCE WITH ASTM D 7158. SHINGLES SHALL MEET THE CLASSIFICATION REQUIREMENTS FOR THE APPROPRIATE MAXIMUM BASIC WIND SPEED:

6 OR H

MAXIMUM BASIC WIND SPEED CLASSIFICATION REQUIREMENT PER ASTM D 1158 D, G OR H 100 MPH G OR H

JOISTS, BEAMS, RAFTERS, AND 2×6 STUDS ARE TO BE A MINIMUM GRADE OF SPRUCE-PINE-FIR (SOUTH) NO. 2, WITH THE FOLLOWING MINIMUM PROPERTIES:

> FB = 750 PSI FV = 70 PSI FC = 335 PSI (PERPENDICULAR)

FC = 975 PSI (PARALLEL)

E = 1,000,000 PSI

2. 2×4 STUDS, UNLESS NOTED OTHERWISE, ARE TO BE A MINIMUM GRADE OF HEM-FIR STUD GRADE, WITH THE

FOLLOWING MINIMUM PROPERTIES: FB = 675 PSI FT FV = 75 PSI

FC = 405 PSI (PERPENDICULAR)

FC = 800 PSI E = 1,200,000 PSI

E = 1,900,000 PSI

3. LAMINATED VENEER LUMBER (LYL) SHALL BE "I.9 E MICROLAM LYL" AS MANUFACTURED BY TRUS JOIST MACMILLAN

(OR EQUAL), WITH THE FOLLOWING DESIGN PROPERTIES: FB = 2,800 PSI (SINGLE I2" MEMBER)

FV = 285 PSI FC = 750 PSI (PERPENDICULAR) FC = 2000 PSI (PARALLEL TO GRAIN)

4. UNLESS SPECIFICALLY SHOWN OTHERWISE, DESIGN, FABRICATION AND ERECTION SHALL BE GOVERNED BY THE LATEST REVISIONS OF:

NATIONAL DESIGN SPECIFICATION FOR WOOD CONSTRUCTION PRODUCT STANDARD PS-I-83 FOR CONSTRUCTION AND INDUSTRIAL PLYWOOD APA PRP-108 FOR STRUCTURAL USE PANELS, OR PS 2-92 FOR WOOD-BASED STRUCTURAL USE PANELS APA RESIDENTIAL CONSTRUCTION GUIDE

5. TRUSSES, STRUCTURAL COMPOSITE LUMBER, STRUCTURAL GLUE-LAMINATED MEMBERS, AND I-JOISTS SHALL BE SUPPORTED LATERALLY AS REQUIRED BY THE MANUFACTURER.

6. ANY DRILLING OR NOTCHING OF THE WALL DOUBLE TOP PLATES SHALL BE IN COMPLIANCE WITH THE BUILDING CODE.

MISCELLANEOUS

. USE ONE LINE OF SOLID BLOCKING OR CROSS BRIDGING AT 8'-O" O/C FOR CEILING JOISTS. USE SOLID BLOCKING

2. USE ONE CRIPPLE STUD AND ONE FULL HEIGHT STUD UNDER BEAM AND HEADER BEARING LESS THAN 4'-O AND ONE CRIPPLE STUD AND TWO FULL HEIGHT STUDS UNDER BEAM AND HEADER BEARING 4'-O OR GREATER, UNLESS SHOWN

3. APPLY CONTINUOUS BEAD OF GLUE ON JOISTS AND GROOVE OF TONGUE-AND-GROOVE PANELS.

4. BUILDING ENVELOPE AIR TIGHTNESS AND INSULATION INSTALLATION SHALL BE DEMONSTRATED TO COMPLY WITH ONE OF THE FOLLOWING OPTIONS:

TESTING OPTION: TESTED AIR LEAKAGE WITH A BLOWER DOOR TEST B. VISUAL INSPECTION OPTION: INSPECTION OF ITEMS LISTED IN TABLE 1102.4.2. (SEE MECHANICAL DRAWINGS FOR ADDITIONAL INFORMATION)

5. FRAMING LUMBER IN CONTACT WITH CONCRETE OR MASONRY, OR EXPOSED TO THE EXTERIOR SHALL BE PRESERVATIVE PRESSURE TREATED.

6. ANY WOOD, INCLUDING EXTERIOR SHEATHING, WITHIN 6" OF FINISHED GRADE SHALL BE PRESERVATIVE-PRESSURE

7. WALL COVERINGS, BACKING MATERIALS, AND THEIR ATTACHMENTS SHALL BE CAPABLE OF RESISTING WIND LOADS IN ACCORDANCE WITH THE FOLLOWING TABLES: SEISMIC DESIGN CATEGORIES

B. WEATHERING PROBABILITY MAP FOR CONCRETE

7. AN APPROVED WATER-RESISTIVE BARRIER SHALL BE APPLIED OVER SHEATHING OF ALL EXTERIOR WALLS. SUCH MATERIAL SHALL BE APPLIED HORIZONTALLY, WITH THE UPPER LAYER LAPPED OVER THE LOWER LAYER NOT LESS THAN 2". WHERE JOINTS OCCUR, BARRIER SHALL BE LAPPED NOT LESS THAN 6". THE BARRIER SHALL BE CONTINUOUS TO THE TOP OF THE WALL, AND TERMINATED AT PENETRATIONS AND BUILDING APPENDAGES IN A MANNER TO MEET THE REQUIREMENTS OF THE EXTERIOR WALL ENVELOPE.

I. ANCHOR BOLTS AND OTHER BOLTS EXCEPT AS MAY BE NOTED: ASTM A307.

2. STRUCTURAL STEEL TO BE ASTM A36 WITH A SHOP COAT OF RUST-INHIBITIVE PAINT, EXCEPT FOR CORROSION-RESISTANT STEEL, AND STEEL TREATED WITH COATINGS TO PROVIDE CORROSION RESISTANCE.

3. STEEL BELOW GRADE TO BE PROTECTED BY A MINIMUM OF 3" OF CONCRETE OR 4" OF MASONRY

4. COLUMNS SHALL BE RESTRAINED TO PREVENT LATERAL DISPLACEMENT AT THE BOTTOM END. COLUMNS SHALL NOT BE LESS THAN 3" DIAMETER, SCHEDULE 40 PIPE, MANUFACTURED IN ACCORDANCE WITH ASTM A 53 GRADE B, OR

5. STEEL LINTELS SHALL BE SHOP COATED WITH A RUST-INHIBITIVE PAINT, EXCEPT FOR LINTELS MADE OF CORROSION-RESISTANT STEEL, OR STEEL TREATED WITH COATINGS TO PROVIDE CORROSION RESISTANCE. THE ALLOMABLE SPAN SHALL NOT EXCEED THE FOLLOWING VALUES, WITH THE LONG LEG OF THE ANGLE IN THE VERTICAL

ANGLE SIZE	NO STORY ABOVE	ONE STORY ABOV
3" X 3" X I/4"	6'-0"	4'-6"
4" × 3" × I/4"	8' - 0"	6'-0"
5" × 3-1/2" × 5/16"	10'-0"	8' - 0"
6" X 3-1/2" X 5/16"	14"-0"	9'-6"

CONNECTIONS & FASTENERS

JOISTS TO BEAMS OR JOISTS TO TRUSSES - 16 GA. STD. JOIST HANGERS, UNLESS SHOWN OTHERWISE - AS MANUFACTURED BY SIMPSON STRONG TIE.

2. ROOF TRUSSES TO SUPPORTING TOP PLATES OR BEAMS - USE HURRICANE TIES, EQUAL TO SIMPSON H3, WITH ALL NAIL HOLES FILLED; ONE PER TRUSS END.

3. ROOF SHEATHING TO JOISTS/TRUSSES:- USE 8D NAILS AT 6" O/C AT PANEL EDGES AND 12" O/C AT INTERMEDIATE

4. FASTENERS AND CONNECTORS IN CONTACT WITH PRESERVATIVE-TREATED WOOD AND FIRE-RETARDANT-TREATED WOOD SHALL BE OF: HOT DIPPED ZINC-COATED GALVANIZED STEEL

STAINLESS STEEL SILICON BRONZE COPPER

I. LUMBER AS REQUIRED BY THE TRUSS MANUFACTURER, MINIMUM GRADE TO BE SYP NO. 2, KD 15 PERCENT MC.

2. CONNECTIONS: ALL INTERNAL TRUSS CONNECTIONS ARE TO BE DESIGNED BY THE TRUSS MANUFACTURER. CONNECTORS SHALL BE DEFORMED PLATE TYPE, OF MINIMUM 20 GAUGE GALVANIZED STEEL SHEET. ALL JOINTS ARE TO BE DESIGNED USING METHODS AS SET FORTH IN TPI STANDARDS 1976.

3. HANGERS: ALL TRUSS TO TRUSS HANGERS ARE TO BE DESIGNED AND SUPPLIED BY THE TRUSS SUPPLIER.

4. SPECIFICATIONS AND REFERENCE STANDARDS: UNLESS SPECIFICALLY SHOWN OTHERWISE, DESIGN, FABRICATION, ERECTION, HANDLING AND BRACING REQUIREMENTS ARE TO BE GOVERNED BY THE LATEST REVISIONS OF: NATIONAL DESIGN SPECIFICATIONS FOR STRESS-GRADE LUMBER AND ITS FASTENINGS TIMBER CONSTRUCTION STANDARDS DESIGN SPECIFICATIONS FOR LIGHT METAL PLATE CONNECTED WOOD TRUSSES

COMMENTARY AND RECOMMENDATIONS 5. ALL TRUSSES ARE TO BE DESIGNED BY THE TRUSS MANUFACTURER FOR THE FOLLOWING LOADS: TOP CHORD LIVE LOAD: 25 PSF (GROUND SNOW) DEAD LOAD:


TRUSS PLATE INSTITUTE PUBLICATION-BTW BRACING WOOD TRUSSES:

BOTTOM CHORD LIVE LOAD: IO PSF 6. WHERE TRUSSES ARE REQUIRED TO FRAME INTO OTHER TRUSSES, THE DESIGN OF THE HANGERS SHALL BE THE RESPONSIBILITY OF THE TRUSS SUPPLIER. THIS IS TO INCLUDE THE DESIGN OF THE HANGERS AND PROVISION IN THE SUPPORTING TRUSS TO ACCEPT THE TYPE OF HANGER PROVIDED.

7. TRUSS DESIGNS ARE TO BE SUBMITTED FOR REVIEW PRIOR TO FABRICATION. TRUSS SUBMITTAL SHALL INCLUDE THE FOLLOWING INFORMATION:


DESIGN INFORMATION FOR EACH TYPE OF TRUSS SUPPLIED TRUSS HANGER TYPE AND LOCATION, FOR ALL TRUSSES FRAMING INTO TRUSSES TRUSS DESIGN DRAWINGS SHALL BE STAMPED BY A REGISTERED ENGINEER

8. ALL MEMBERS OF MULTIPLE TRUSSES ARE TO BE NAILED TOGETHER WITH IOD COMMON NAILS AT 8" O.C., FOR DOUBLE TRUSSES, OR WITH 16D COMMON NAILS AT 8" O.C. FROM EACH SIDE, FOR TRIPLE TRUSSES.

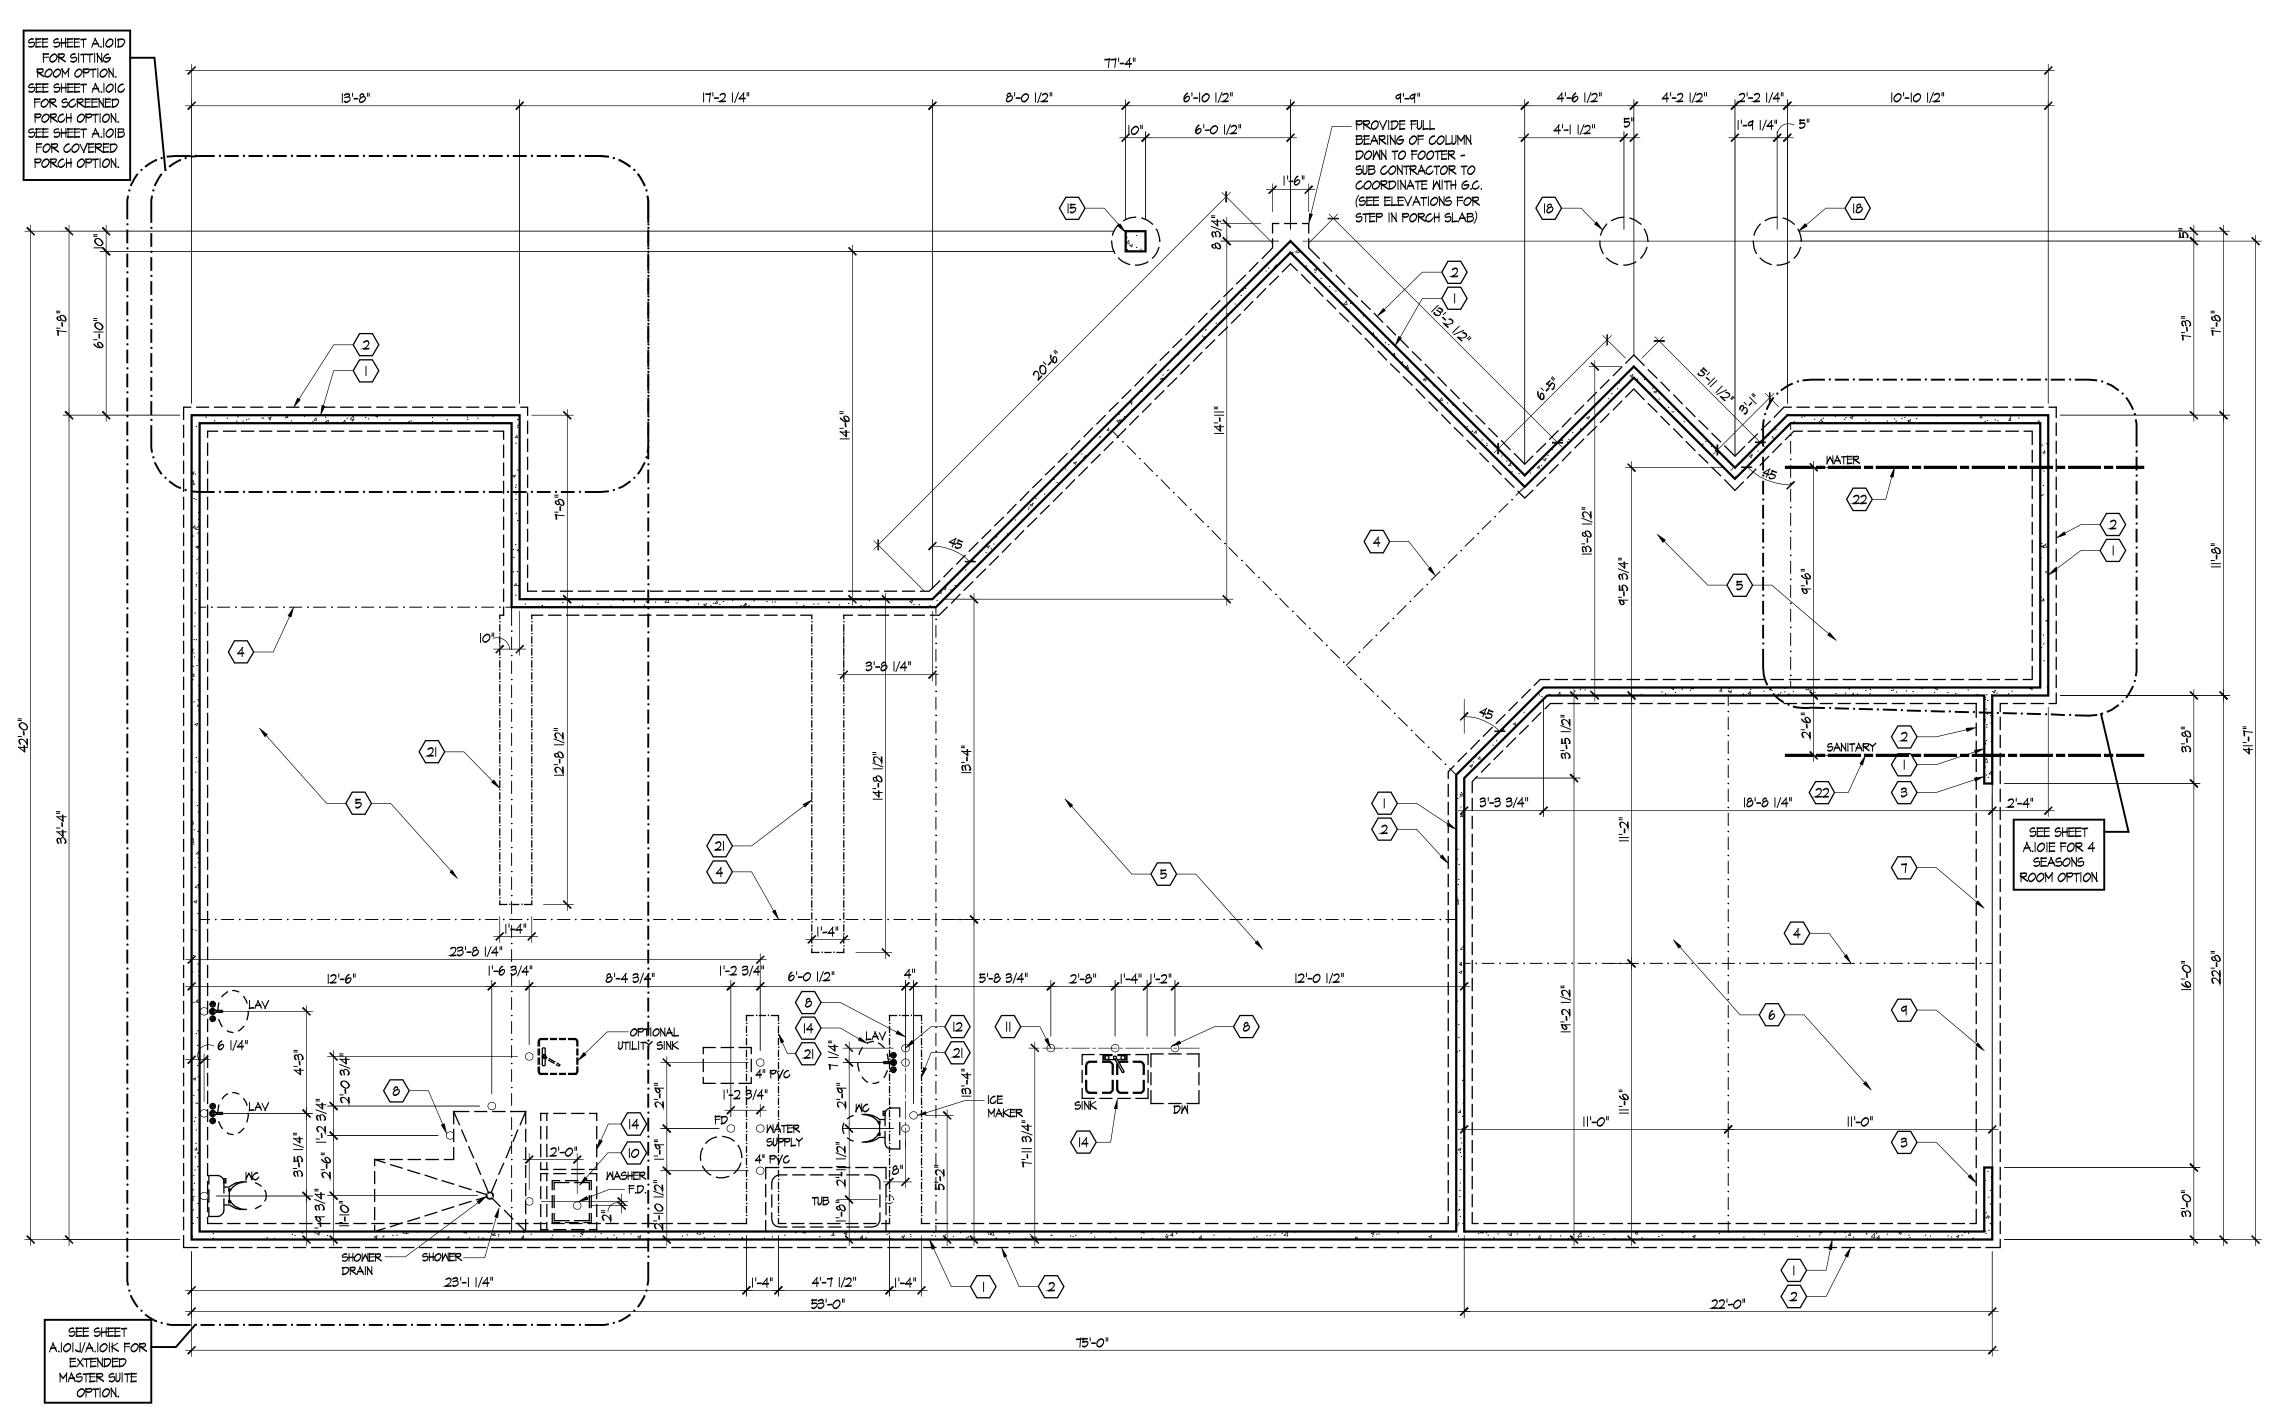


Foundation Plan

Scale: 1/4" = 1'-0"

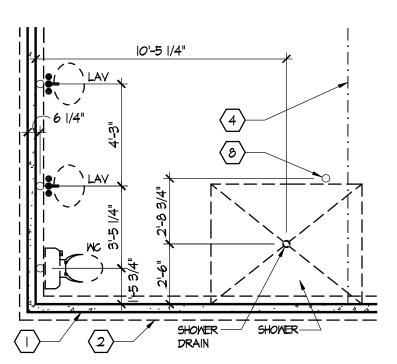

Master Bath - Optional Alternate Walk-In Shower

Scale: 1/4" = 1'-0"

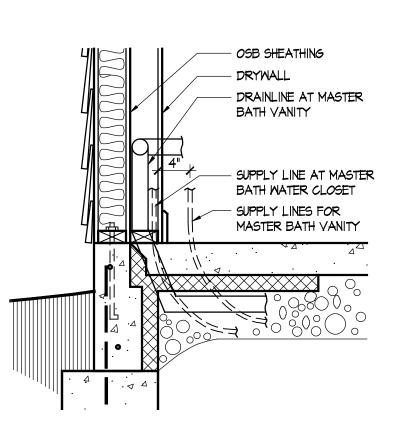

Master Bath Plumbing Detail - Vanity/W.C.

Scale: 1/4" = 1'-0"

FOUNDATION CODED NOTES (FOUNDATION PLAN ONLY)

(ALL NOTES NOT APPLICABLE TO ALL SHEETS)

- I. POURED CONCRETE FOUNDATION STEM WALL (TYPICAL) SEE WALL SECTIONS SHEETS.
- 2. I2" MIDE CONCRETE FOOTING WITH STEEL BAR REINFORCING AS REQUIRED BY SOILS ENGINEER MAINTAIN BOTTOM OF FOOTING A MINIMUM 30" BELOW FINISH GRADE AND TOP OF FOOTING SET I2" BELOW FINISHED FLOOR TYPICAL.
- 3. PROVIDE MIN. 2 ANCHOR BOLTS EACH SIDE OF GARAGE DOORS.
- 4. SAW CUT CONTROL JOINT IN CONCRETE SLAB, 1/8" WIDE x 1/4 DEEP TYPICAL.
- 4" POURED CONCRETE FLOOR SLAB OVER 4 MIL.
 POLYETHYLENE VAPOR BARRIER AND 4" GRAVEL BASE -TYPICAL.
- 4" GLASS FIBER REINFORCED CONCRETE FLOOR SLAB OVER
 4" GRAVEL BASE TYPICAL IN GARAGES.
- 7. PROVIDE WEATHERLIP @ GARAGE DOOR OPENING SEE DETAIL D, SHEET A.301.
- 8. PIPE LOCATION CENTERED ON WALL ABOVE.
- 9. NO STEM WALL AT GARAGE DOOR OPENINGS.
- IO. WASHER ALWAYS LOCATED LEFT OF DRYER.
- II. ELECTRICAL CONDUIT UNDER SLAB FOR ELECTRICAL OUTLET AT KITCHEN ISLAND.
- 12. ELECTRICAL CONDUIT SLAB PENETRATION.
- 13. NOT USED.
- 14. DASHED LINES INDICATE LOCATION OF PLUMBING FIXTURES ABOVE - SHOWN FOR REFERENCE ONLY.
- 15. IO" WIDE \times IO" DEEP CONCRETE PIER WITH 24" DIA. FOOTING. MAINTAIN BOTTOM OF FOOTING A MINIMUM 30" BELOW FINISH GRADE AND TOP OF PIER SET 6" BELOW FINISHED FLOOR.
- 16. DOTTED LINE INDICATES WALL LINE OF BASE UNIT.
- 17. 8" DEEP X 16" WIDE THICKENED SLAB WITH (2) NO. 4 REBAR CONTINUOUS.
- 18. 24" DIA. FOOTING MAINTAIN BOTTOM OF FOOTING A MINIMUM 30" BELOW FINISH GRADE.
- 19. 12" DEEP CONCRETE FOOTING WITH (2) NO. 5 REBAR EACH WAY - SEE PLANS FOR SIZE - MAINTAIN BOTTOM OF FOOTING A MINIMUM 30" BELOW FINISH GRADE. 12" THICKENED SLAB EDGE TO CONTINUE DOWN TO FOOTING.
- 20. 24" WIDE CONCRETE FOOTING WITH STEEL BAR REINFORCING AS REQUIRED BY SOILS ENGINEER MAINTAIN BOTTOM OF FOOTING A MINIMUM 30" BELOW FINISH GRADE AND TOP OF FOOTING SET 12" BELOW FINISHED FLOOR.
- 21. 12" DEEP x 16" WIDE THICKENED SLAB WITH (2) NO. 4 REBAR CONTINUOUS. TYPICAL UNDER ALL INTERIOR SHEAR WALLS.
- 22. PLUMBER TO PROVIDE 4" PVC SLEEVE FOR WATER AND 4" SANITARY LINE FOR INSTALLATION BY FOOTER CONTRACTOR.

GENERAL FOUNDATION NOTES

I. SOIL BEARING CAPACITY ASSUMED TO BE 2500 PSF AND SHALL BE VERIFIED BY SOILS ENGINEER PRIOR TO PLACEMENT OF BUILDING FOUNDATION. CONSULT ARCHITECT WHEN INADEQUATE SOIL CAPACITIES ARE FOUND.

2. ALL DIMENSIONS ARE TO FACE OF FOUNDATION / BASEMENT WALL UNLESS NOTED OTHERWISE.

3. HOLD DOWN TOP OF FOUNDATION WALL 8" AT ALL ENTRY DOORS TO ALLOW FOR EXTENSION OF FLOOR SLAB UNDER THE DOOR THRESHOLDS.

4. PLUMBING CONTRACTOR TO USE ROUND BUCKETS FOR FORMED SLAB PENETRATIONS.

5. CONCRETE CONTRACTOR TO INSTALL 1/2" EXP. JT. AROUND THE PERIMETER OF GARAGES.

LOCATION OF BLOCKOUTS FOR UNDERSLAB LINES.

7. CONCRETE CONTRACTOR - SEE FIRST FLOOR PLAN FOR SIDEMALKS AND PATIOS.

6. CONCRETE CONTRACTOR COORDINATE WITH PLUMBING FOR

8. CONCRETE CONTRACTOR TO VERIFY SLAB PENETRATION AT TUB/SHOWER OPTIONS.

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Villas at Park Place
By Park Place West Chester, LL

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THESE DRAWINGS SHALL BE USED IN CONFORMANCE WITH ALL LOCAL BUILDING, MECHANICAL, PLUMBING AND ELECTRICAL CODES AND SHALL MEET THE REQUIREMENTS OF THE HEALTH DEPARTMENT, FIRE MARSHALL, AMERICANS WITH DISABILITIES ACT ACCESSIBILITY GUIDELINES (ADAAG), THE FAIR HOUSING ACT ACCESSIBILITY GUIDELINES (FHAAG), AND SHALL BE CONSTRUCTED IN CONFORMANCE WITH STATE AND LOCAL

ENERGY REQUIREMENTS.

Prototype	Interim Pag	e Revisions
Disk No.	Revision	Date
		8/1/10

Architect Project Number 2010-005

Community Dates & Revisions
Date Originated 1 FEB 2015
Bid
Permit
Construction

Permit
Construction
Revisions


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Drawing Title
Foundation Plan

Architectural Style

European Country
Sheet Number

A.100 D3 - 2010

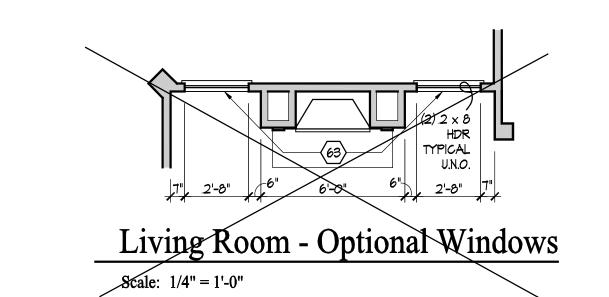

77'-4"

15'-4"

8'-0 1/2"

.

(51)—

DINING **ROOM**

-3-0 WIDE x 7-8

HIGH D.W. OPENING

First Floor Plan

Scale: 1/4'' = 1'-0''

5'-6" 5 1/2"

 $\begin{bmatrix} \frac{1}{2} \\ \frac{1}{2} \end{bmatrix} BATH 2 - \begin{bmatrix} \frac{1}{2} \\ \frac{1}{2} \end{bmatrix}$

(2)2×8

|T'-2 |/4"

BEDROOM 2

5-6" 3'-0"

A.301

-(14)

4'-1"

—(54)

4'-2 3/4"

13'-8"

·5 1/2" LVL

LT. OPTION: IN-SMING

FRENCH DOOR WITH STATIONARY PANEL

MASTER

BEDROOM

-9'-0 1/2"-----

MASTER

CLOSET

MASTER BATH

SEE SHEET A.IOID

FOR SITTING

ROOM OPTION. SEE SHEET A.IOIC

FOR SCREENED PORCH OPTION.

SEE SHEET A.IOIB

FOR COVERED PORCH OPTION.

A201

SEE SHEET A.IOIJ/A.IOIK FOR 📙

EXTENDED MASTER SUITE

OPTION.

GENERAL NOTES

- I. EXTERIOR WALL DIMENSIONS INCLUDE THICKNESS OF SHEATHING.
- 2. REFER TO SITE LAYOUT PLAN FOR BUILDING LOCATIONS AND ORIENTATIONS.
- 3. DOORS NOT OTHERWISE DIMENSIONED SHALL BE LOCATED WITH ROUGH OPENING 3" FROM INTERSECTING WALLS.
- 4. AT SECOND FLOOR WALL LOCATIONS WITH PARALLEL FLOOR

JOIST/TRUSSES - PROVIDE 2 X BLOCKING FULL DEPTH OF FLOOR STRUCTURE BETWEEN JOISTS/TRUSSES @ 24" O.C..

10'-10 1/2"

(2) 2 \times 8 HDR-

TYPICAL U.N.O.

(3)

42

SEE SHEET

A.IOIE FOR 4

SEASONS

ROOM OPTION

A201

6'-4 3/4"

5'-6 3/4"

4'-6 1/2"

43 L

Eliminate door from hall into storage and two walls

making one room with door from kitchen to remain.

See Sheet A.101L for Extended Garage Option

18'-2 1/2"

GARAGE

3'-8 1/2"

(3) || T/8" x

1 3/4" LVL \

A.401

LIVING

ROOM

6

28 30 6 24 25

63 SEE INT.

ELEVATIONS

63 SEE INT. ELEVATIONS

77'-4"

U 2'-0" STORAGE

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PROVIDE FIBERGLASS BATT INSULATION IN GARAGE WALLS COMMON TO LIVING SPACE.

5. ISLAND BASE CABINETS & COUNTERTOP - FINISH ALL EDGES OF CABINETS & COUNTERTOP.

AND 7/16" O.S.B. SHEATHING ON EXTERIOR SURFACES - TYPICAL.

3. FLAT DRYWALL CEILING @ 9'-O" A.F.F. - TYPICAL UNLESS NOTED OTHERWISE.

4. 20" DEEP X 60" WIDE GRANITE HEARTH EXTENSION - CENTERED ON FIREBOX.

MAINTAIN 4" MINIMUM ELEVATION CHANGE BETWEEN GARAGE FLOOR & FINISHED FIRST FLOOR.

PREFABRICATED METAL FIREBOX UNIT HEARTH & HOME MODEL DV37325BI (OR SIMILAR), PROVIDE GAS LINE, GAS LOG SET AND SCREEN - ROUGH OPENING 31" WIDE X 34 3/4" HIGH X 18" DEEP (26" DEEP WITH BUILT-IN CABINETRY OPTION).

EXTERIOR STUD WALL - 2 X 4 WOOD STUDS AT 16" O.C. WITH 1/2" DRYWALL ON ALL INTERIOR SURFACES

2. INTERIOR STUD WALL - 2 X 4 WOOD STUDS AT 16" O.C. WITH 1/2" DRYWALL ON ALL FINISHED SURFACES

IO. OPTIONAL CABINETS - SEE INTERIOR ELEVATIONS.

MASHER LOCATION - PROVIDE MASHER BOX ON BACK WALL. MASHER ALMAYS LOCATED LEFT OF

12. DRYER LOCATION - DRYER VENT IN WALL.

TIRST FLOOR PLAN CODED NOTES

(ALL NOTES NOT APPLICABLE TO ALL SHEETS)

(FIRST FLOOR UNIT PLANS ONLY)

6. TRAY CEILING @ 10'-0" A.F.F.

13. OPTIONAL UTILITY SINK AND FAUCET - INSTALL ROUGH-IN PLUMING ONLY.

14. SINGLE CLOSET ROD & SHELF (67 1/2" A.F.F.) - YINYL COATED WIRE WITH STANDARD SPACING.

15. ARCHED OPENING. SPRING POINT @ 7'-8" A.F.F. TOP OF ARCH 8'-6" ABOVE SPRING POINT.

16. LOCATION OF DOUBLE 2 X 4 STUD WALL.

17. FRAMELESS MIRROR LOCATION - 42" HIGH x 2" SHORTER THAN VANITY TOP (I" EACH SIDE) - SET BOTTOM OF MIRROR AT TOP OF BACKSPLASH.

18. VANITY BASE AND COUNTERTOP 31 1/2" A.F.F.

19. TOILET & SEAT.

20. SELF-RIMMING COUNTER LAVATORY AND FAUCET.

21. 32" X 60" STANDARD TUB/SHOWER & FAUCET WITH CERAMIC TILE SURROUND.

22. TEMPERED GLASS SHOWER ENCLOSURE AND DOOR.

23. 22" x 54" OPTIONAL PULL DOWN STAIR LOCATED BETWEEN TRUSSES ABOVE. DRYWALL ON STAIR SHALL BE MOUNTED WITH SCREWS INTO THE TOP & BOTTOM DOOR CROSS SUPPORTS WITH THE CENTER GLUED LEAVING NO SCREWS EXPOSED.

24. BASE CABINETS AND COUNTERTOP.

25. LINE OF WALL CABINETS ABOVE.

26. 24" LONG TOWEL BAR - 54" A.F.F. (56" A.F.F. ABOVE TOILET).

27. REFRIGERATOR LOCATION.

28. DOUBLE BOWL SINK AND FAUCET.

29. RANGE LOCATION.

30. DISHWASHER LOCATION. 31. IO" X IO" BUILT-UP COLUMN - TYPICAL. SEE DETAIL D, SHEET A.304 FOR MORE INFORMATION.

32. TOILET PAPER DISPENSER.

33. (4) 16" DEEP WIRE SHELVES (29", 42", 55", 68" A.F.F.) - STANDARD SPACING. TYPICAL AT LINEN CLOSETS AND PANTRIES, UNLESS NOTED OTHERWISE.

34. FURNACE LOCATION.

35. WATER HEATER LOCATION - WITH PAN.

36. IO" X IO" BUILT-UP COLUMN / PILASTER - TYPICAL. SEE DETAIL F, SHEET A.304 FOR MORE INFORMATION.

37. I6'-O" x 8"-O" ATTIC STORAGE ABOVE - PROVIDE 3/4" APA RATED SUB-FLOORING ON BOTTOM CHORD OF TRUSSES. OSB SHEATHING RATED FOR 20 PSF LIVE LOAD IS PERMITTED AS AN ALTERNATE.

38. I/2 WALL TO UNDERSIDE OF BAR COUNTERTOP.

39. HOSE BIBB LOCATION.

40. SURFACE MOUNTED ELECTRIC PANEL LOCATION.

41. PROVIDE (2) JACKS UNDER ALL HEADERS IN OPENINGS OVER 60" WIDE - TYPICAL.

42. INDICATES MULTIPLE STUD COLUMN IN WALL - TYPICAL AT BEARING OF ALL WOOD BEAMS, GIRDER TRUSSES UNLESS NOTED OTHERWISE. SEE PLAN FOR NUMBER OF STUDS REQUIRED.

43. MINIMUM I/2" DRYWALL ON GARAGE SIDE.

44. 32" X 60" STANDARD SHOWER BASE.

45. CUSTOM TILED WALK-IN SHOWER BASE - SEE PLAN FOR SIZE.

46. WOOD GUARD RAIL - SEE DETAIL K ON SHEET A.304.

47. TILED CORNER SEAT OPTION - 30" WIDE X 18" A.F.F HIGH.

48. FLAT DRYWALL CEILING ON UNDERSIDE OF BOTTOM CHORD OF ROOF TRUSSES OR FLOOR JOISTS.

49. FLAT DRYWALL CEILING @ 8'-4" A.F.F.

50. SOAP DISH - 5" HIGH X 7" WIDE.

51. DOWNSPOUT LOCATION.

52. DOWNSPOUT DISCHARGED INTO BLACK PIPE AND ROUTED UNDER WALKS OR PATIO.

53. EDGE OF DRIVEWAY.

54. 4" THICK SLAB TYPICAL @ CONCRETE WALKS/PORCHES/PATIOS

55. CONTROL JOINTS - TYPICAL.

56. DASHED LINES INDICATE BOXED BEAM ABOVE.

57. 12" DEEP SHELF (60" A.F.F.) - VINYL COATED WIRE - STANDARD SPACING.

58. SHOWER WALL - 6'-0" A.F.F.

59. OPTIONAL GARAGE SHELVING.

60. OPTIONAL DESK.

61. COURTYARD GATE AND FENCE LOCATION.

62. DASHED LINE INDICATES OPTIONAL PATIO SECTION.

63. OPTIONAL WINDOW.

64. (4) 12" DEEP WIRE SHELVES (29", 42", 55", 68" A.F.F.) - STANDARD SPACING.

65. 32" X 60" SHOWER BASE WITH BUILT-IN SEAT.

66. HARDBOARD TREADS AND RISERS.

67. WOOD HANDRAIL - 34" ABOVE STAIR TREADS. RETURN ENDS TO WALL OR NEWEL POST.

68. SINGLE BOWL SINK AND FAUCET.

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> Drawing Title First Floor Plan

Architectural Style European Country

Sheet Number A.101

79. NOT USED. 80. NOT USED. 81. DASHED LINE INDICATES 8" CEILING SOFFIT FOR SANITARY LINES FROM BONUS ROOM.

Master Bath - Optional Alternate Walk-In Shower Scale: 1/4" = 1'-0"

70. FLAT DRYWALL CEILING @ 8'-0" A.F.F..

16'-0" DOOR: -

 $(2).2 \times 12 \text{ WOOD}$

<u> 18'-0" DOOR OPTION:</u>

(2) I-3/4" II-I/4" LVL

<u> 16'-0" DOOR HIP</u>

ROOF OPTION:

 $(2).2 \times 12 \text{ MOOD}$

<u> 18'-0" DOOR HIP</u> ROOF OPTION:

(2) I-3/4" II-I/4" LVL

71. LINE OF BREAK OF SLOPED DRYWALL CEILING - FOLLOW BOTTOM CHORD OF ROOF TRUSSES OR

72. SLOPED CEILING AREA ABOVE.

RAFTERS ABOVE.

73. ATTIC ACCESS PANEL: 22" x 30" MINIMUM. PANEL TO BE 6" MIN. ABOVE BASE IF LOCATED IN KNEE WALL. PANEL TO HAVE I" QUARTER ROUND MOULDING AROUND EDGE. PANEL SHALL BE MEATHER-STRIPPED AND INSULATED TO A LEVEL EQUIVALENT TO THE INSULATION ON THE SURROUNDING SURFACES. IF IN THE CEILING, A BAFFLE IS REQUIRED TO CONTAIN LOOSE-FILL INSULATION.

74. UNDER THE COUNTER REFRIGERATOR LOCATION.

75. FLAT DRYWALL CEILING @ 7'-O" A.F.F..


76. 2×6 HALF WALL @ 36" A.F.F. WITH I X & HARDWOOD CAP - I/2" LAG BOLT EACH END THRU SUB FLOOR.


77. SINGLE CLOSET ROD & SHELF (48" A.F.F.) - VINYL COATED WIRE WITH STANDARD SPACING.

76. KNEE WALL: 2 x 4 WOOD STUDS AT 16" O.C. WITH 1/2" DRYWALL ON ALL INTERIOR SURFACES, AND 1/4" O.S.B. BACKER PANEL ON EXTERIOR SURFACES - TYPICAL. RUN FROM FLOOR STRUCTURE BELOW TO UNDERSIDE OF ROOF FRAMING.

82. TOWEL RING.

69. 20" RANGE LOCATION.

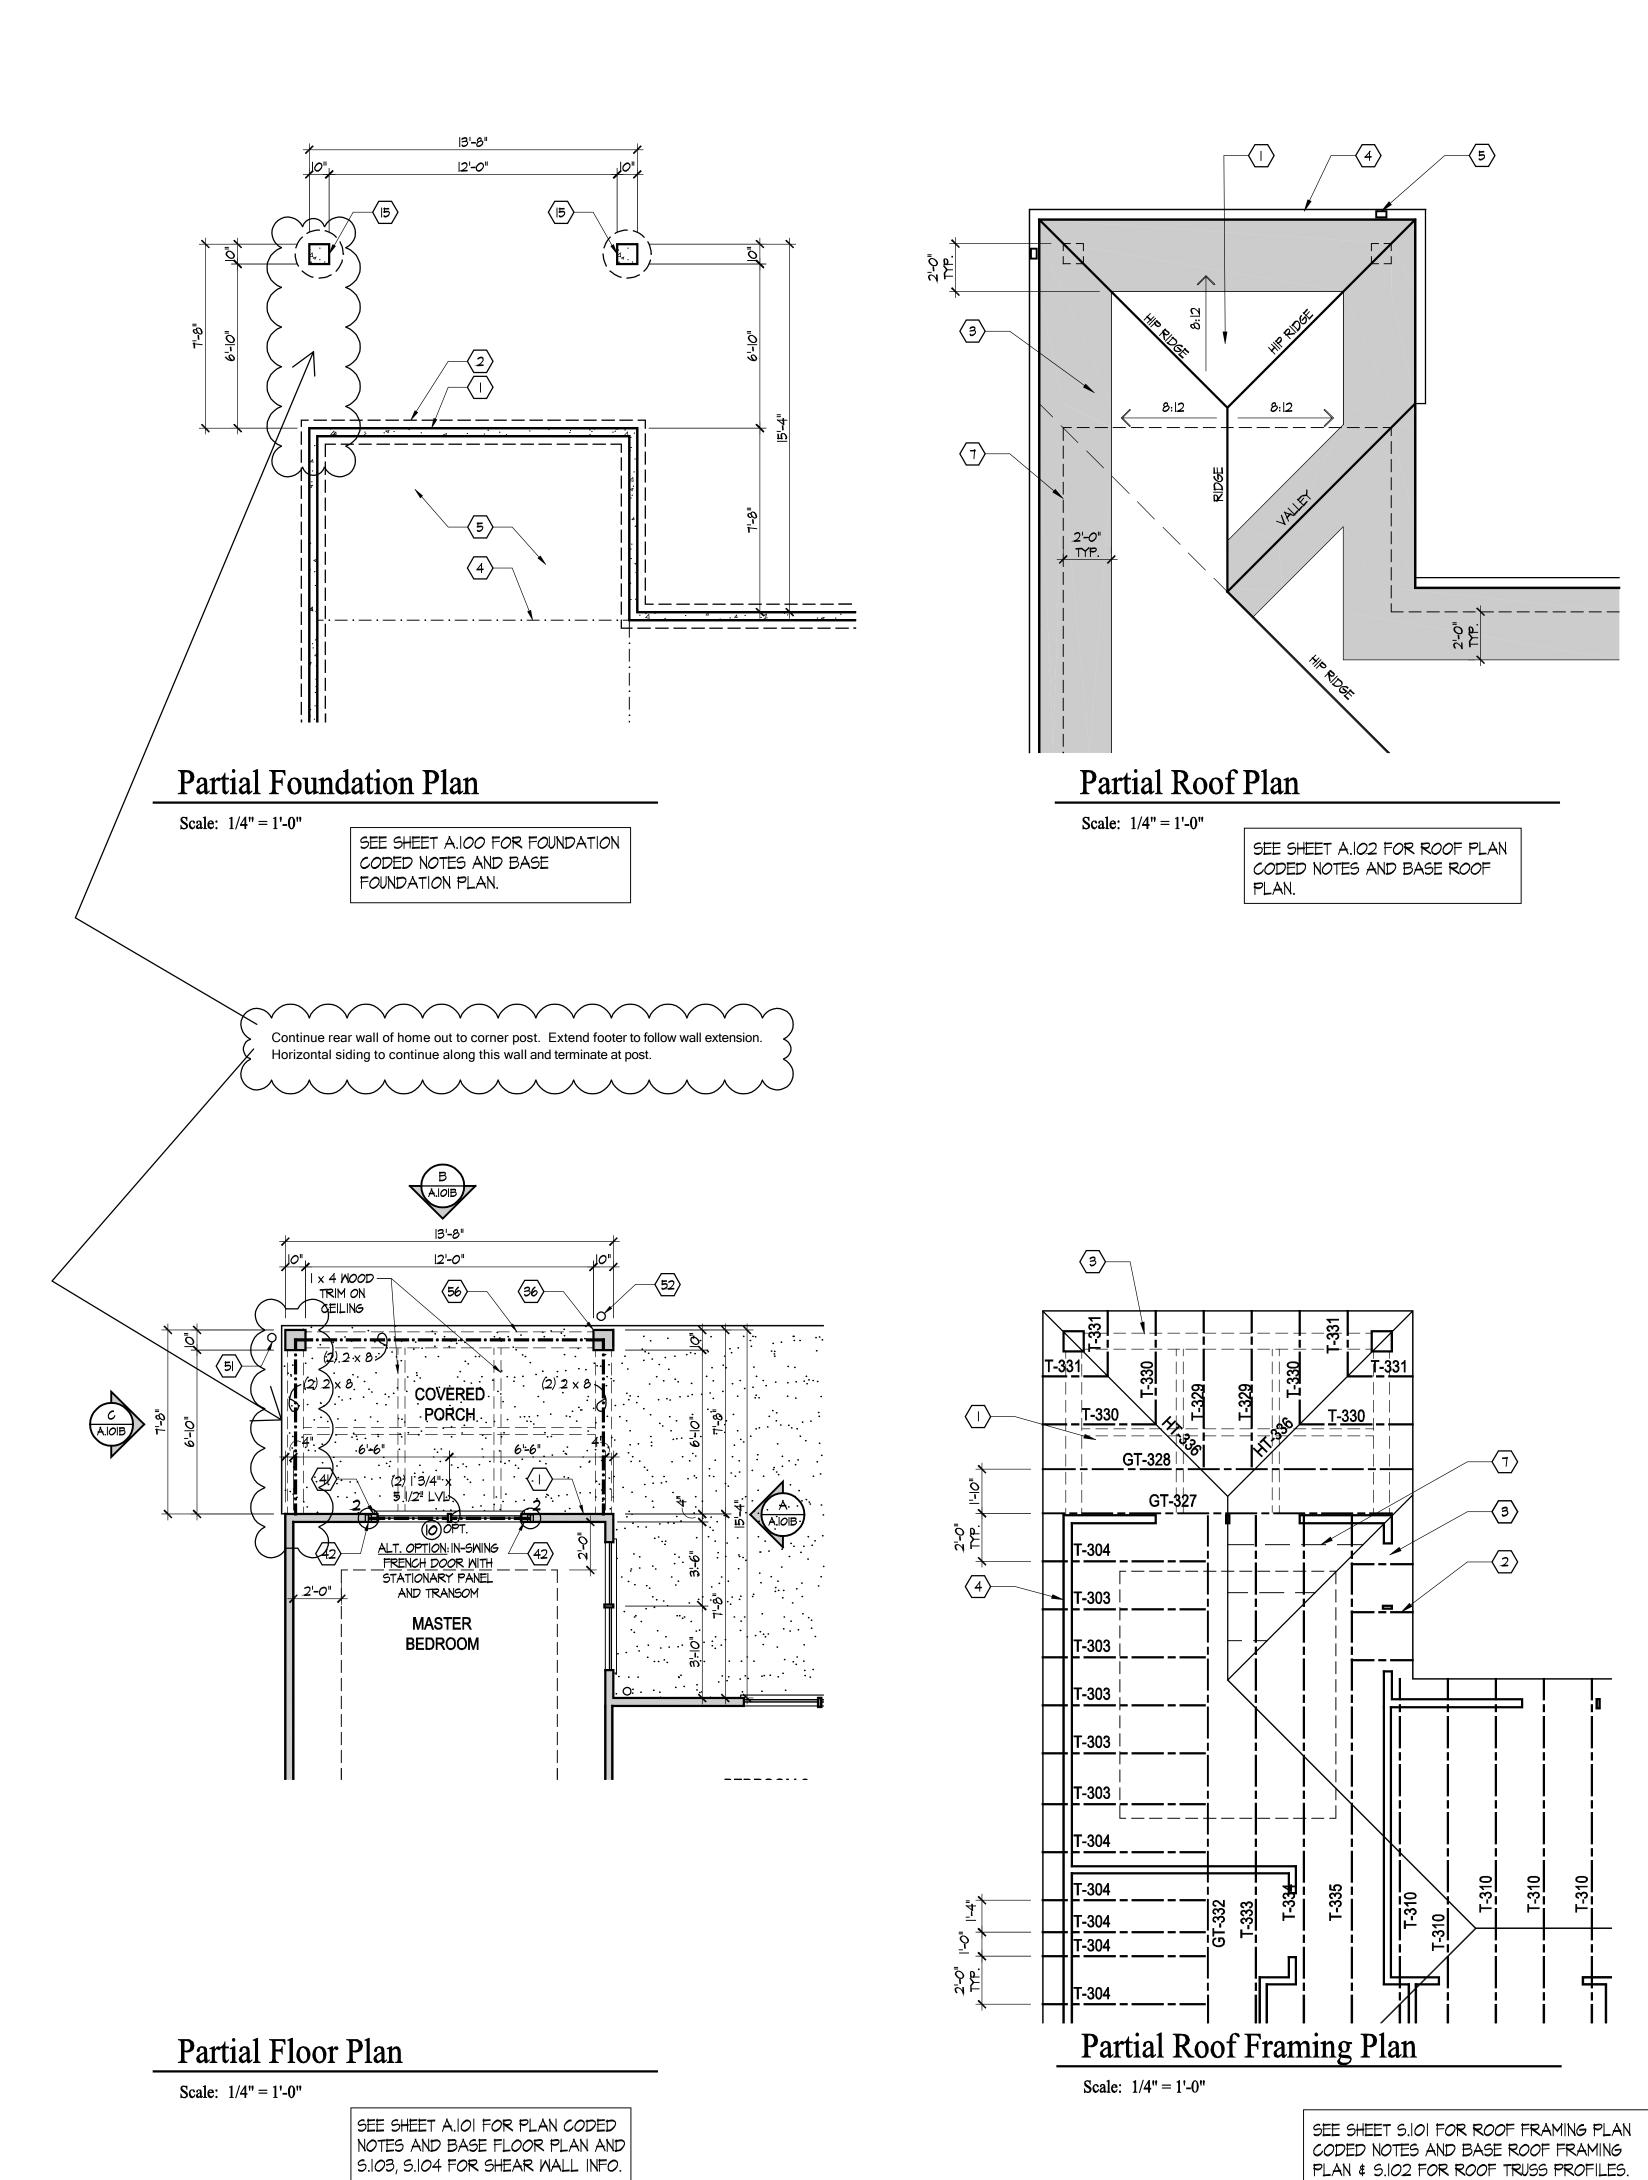


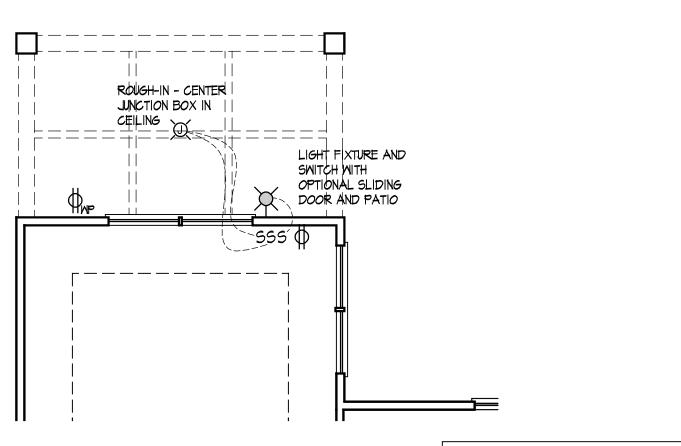

Partial Electrical Plan

Scale: 1/4" = 1'-0"

SEE SHEET E.100 FOR ELECTRICAL PLAN LEGEND AND BASE ELECTRICAL PLAN.

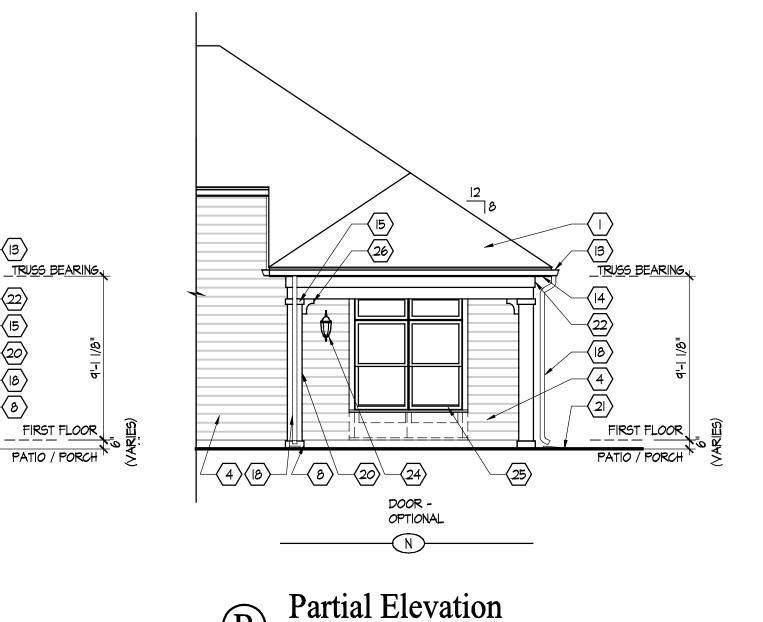

Elevation


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REFER TO SHEETS A.502 \$
A.503 FOR WINDOW

SIZES, TRIMS AND SHUTTERS

INFORMATION INCLUDING

Scale: 3/16" = 1'-0"

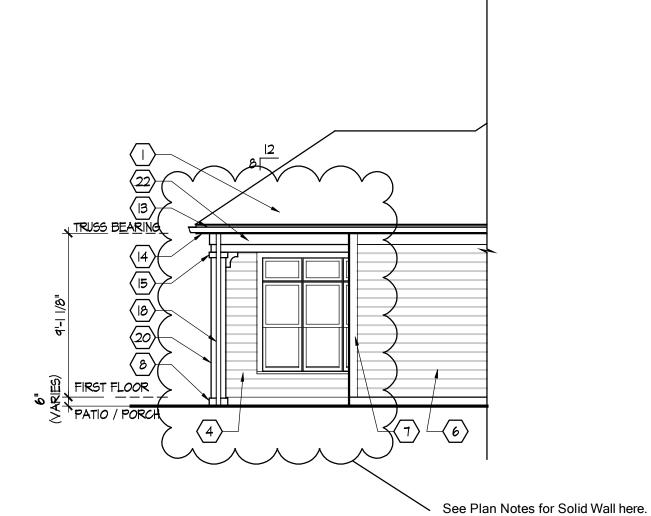

Partial Elevation

SEE SHEET A.201 FOR ELEVATION CODED NOTES AND BASE ELEVATIONS.



Communities at Park Place West Chester, Epcon (Villas a

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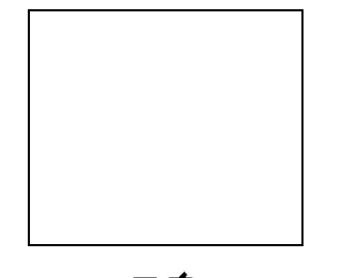
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> **Drawing Title Covered Porch** Option


Architectural Style **European Country**


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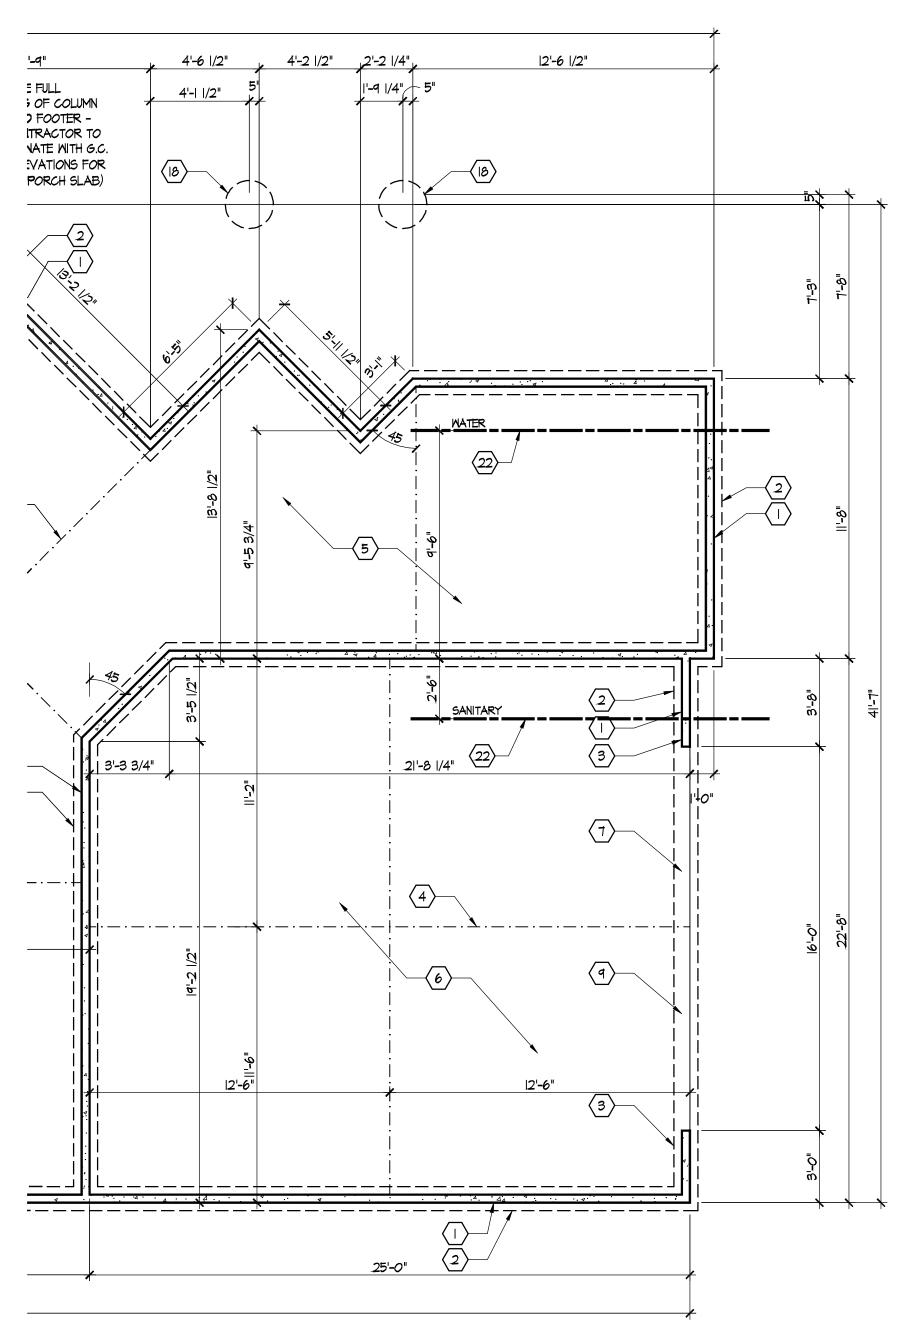




Where Life Comes Together



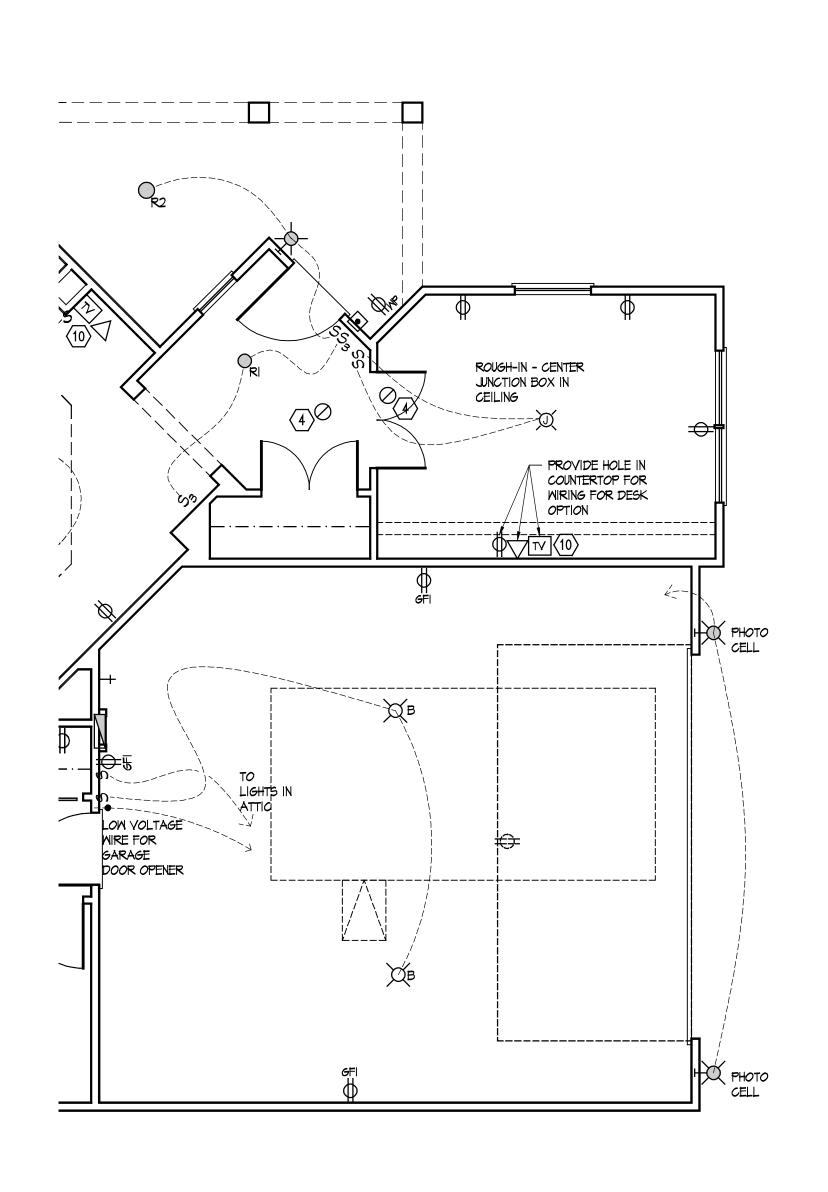

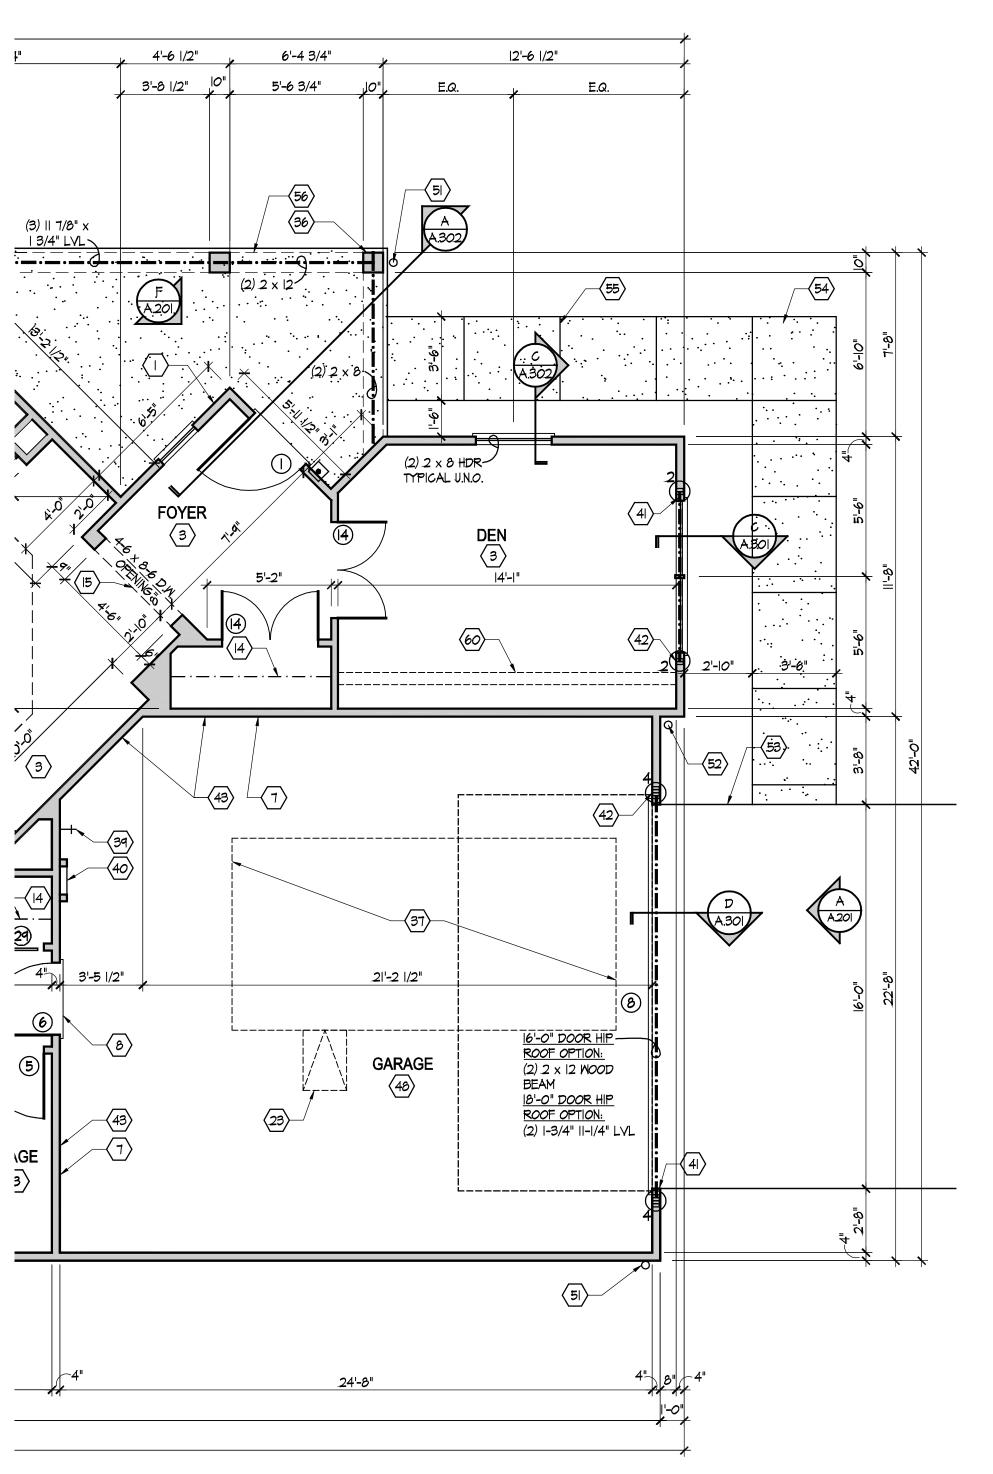

Partial Foundation Plan

SEE SHEET A.100 FOR FOUNDATION CODED NOTES AND BASE FOUNDATION PLAN.

Epcon Communities
Villas at Park Place
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Hip Roof w/ ext. Garage Plans & Electrical

> Architectural Style **European Country** Sheet Number A.101L


Electrical Plan - First Floor

SEE SHEET E.IOO FOR ELECTRICAL PLAN LEGEND AND BASE ELECTRICAL PLAN. Scale: 1/4" = 1'-0"

Partial First Floor Plan Scale: 1/4" = 1'-0"

SEE SHEET A.IOI FOR PLAN CODED NOTES AND BASE FLOOR PLAN AND S.103, S.104 FOR SHEAR WALL INFO.

Scale: 1/4" = 1'-0"

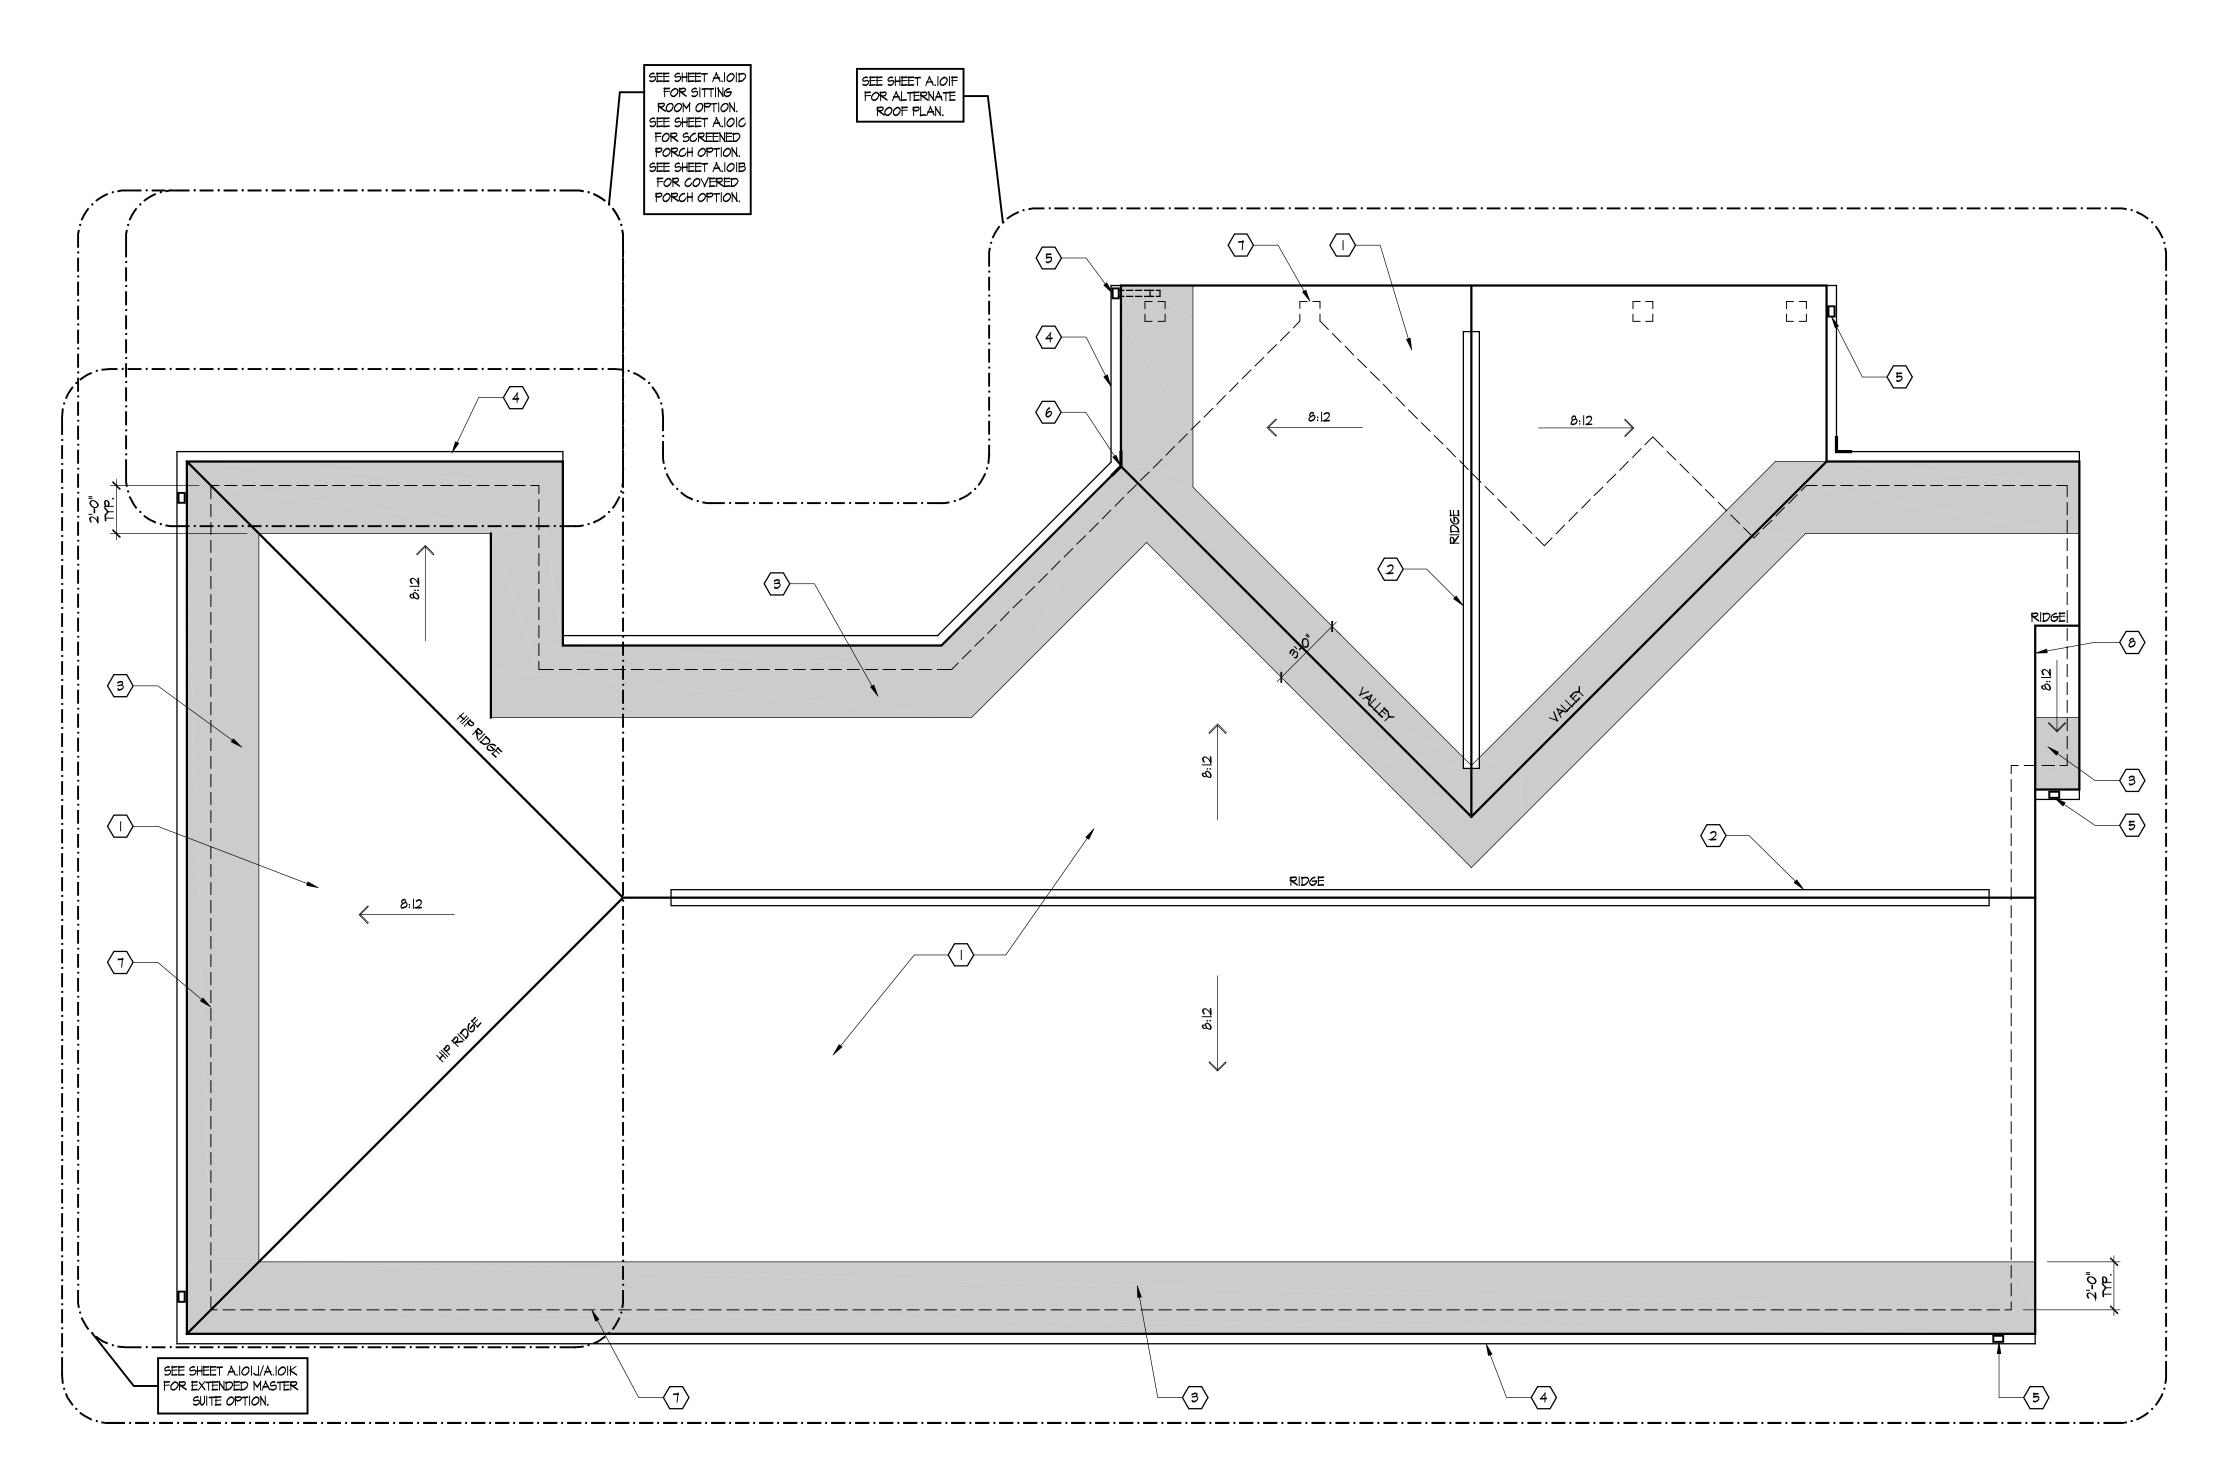

Roof Plan

Scale: 1/4" = 1'-0"



CODED NOTES (ROOF PLAN ONLY)

(ALL NOTES NOT APPLICABLE TO ALL SHEETS)

I. ASPHALT SHINGLE ROOFING ON I LAYER OF 15# ROOFING FELT -TYPICAL ALL ROOF SURFACES UNLESS NOTED OTHERWISE.

- 2. RIDGE VENT LOCATION AIR VENT CRY 100 (TYPICAL).
- 3. SHADED AREAS INDICATE LOCATIONS FOR ICEGUARD INSTALLED BELOW SHINGLE ROOFING.
- 4. 5" ALUMINUM OGEE GUTTER TYPICAL.
- 5. 3" x 4" DOWNSPOUT LOCATION PROVIDE ELBOW AND TURN CORNER AS SHOWN (SOME LOCATIONS ONLY) - ALL DOWNSPOUTS TO TIE INTO COLLECTOR DRAIN OR DAYLIGHT SYSTEM.
- 6. FLOW DIVERTER TYPICAL AT ALL VALLEY TERMINATIONS.
- 7. INDICATES LINE OF PERIMIETER WALL BELOW -
- 8. PROVIDE STEP AND COUNTER FLASHING ON SIDE WALL MINIMUM 16" HIGH UP UNDER SIDING.
- 9. OPTIONAL FAUX DORMER SEE DETAIL A ON SHEET
- IO. BONUS ROOM DORMER SEE SHEET A.607 AND A.608 FOR MORE INFORMATION.

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ENERGY REQUIREMENTS.

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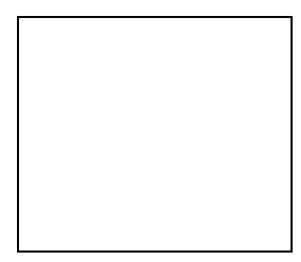
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> **Drawing Title** Roof Plan

Architectural Style **European Country**

> Sheet Number A.102 D3 - 2010







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EXTERIOR ELEVATION CODED NOTES

- I. FIBERGLASS / ASPHALT SHINGLE ROOFING OVER I LAYER OF 15# FELT TYPICAL.
- 2. I x 8 LP SMART TRIM RAKE EXTENSION TYPICAL.
- 3. WATER FLOW DIVERTER TYPICAL AT VALLEY ENDS.
- 4. PRE-PRIMED COMPOSITION LAP SIDING BY LOUISIANA PACIFIC (OR EQUAL).
- 5. CULTURED STONE VENEER. COLOR, STYLE, MORTAR COLOR, COURSING, & JOINT STYLE TO BE SELECTED BY THE OWNER.
- 6. VINYL FRENCH DOOR UNIT PAINTED. SEE DOOR SCHEDULE FOR MORE
- 7. $5/4 \times 6$ CORNER TRIM RIP ONE SIDE TO ACHIEVE 5 1/2" DIMENSION EACH SIDE
- 8. I \times 6 PAINTED COLUMN BASE TRIM WITH BEVELED TOP EDGE TYPICAL.
- 9. VINYL WINDOW UNIT (TYPICAL) SEE WINDOW DETAILS ON SHEET A.502 FOR SIZE AND TRIM INFORMATION.
- 10. PRE-HUNG INSULATED FIBERGLASS ENTRY DOOR PAINTED. SEE DOOR SCHEDULE
- II. BRICK ARCHED SOLDIER COURSE AT DOOR HEAD OVER 5/4 SMOOTH SAWN
- 12. DORMER LOCATION. SEE DETAIL A ON SHEET A.304 FOR MORE INFORMATION.
- 13. 5" ALUMINUM OGEE GUTTER ON I \times δ LP SMART TRIM FASCIA TYPICAL.
- 14. VENTED VINYL SOFFIT (TYPICAL) SEE TYPICAL WALL SECTIONS FOR MORE
- 15. I x 4 PAINTED COLUMN CAP TRIM TYPICAL.
- 16. CONTINUOUS RIDGE VENT LOCATION TYPICAL.
- 17. PANELED OVERHEAD GARAGE DOOR TYPICAL. SEE SHEET A.501 FOR DETAILS.
- 18. DOWNSPOUT LOCATION WITH SPLASH BLOCK (NO SPLASH BLOCK WHERE ROUTED
- 19. $5/4 \times 8$ RAKE TRIM AT FACE OF WALL TYPICAL.
- 20. 10" SQUARE BUILT-UP COLUMN/PILASTER SEE DETAIL F, SHEET A.304 FOR MORE
- INFORMATION TYPICAL.
- 21. APPROXIMATE LINE OF GRADE TO BE COORDINATED WITH BUILDER PRIOR TO START OF CONSTRUCTION - SEE WALL SECTIONS FOR ADDITIONAL INFORMATION.
- 22. 5/4 x 8 FRIEZE BOARD TRIM TYPICAL.
- 23. ADDRESS PLAQUE USE DOUBLE THICKNESS TRIM AS BACKING. MOUNT TOP @
- 5'-5" A.F.F. ON WALL TYPICAL.
- 24. EXTERIOR LIGHT FIXTURE USE DOUBLE THICKNESS TRIM AS BACKING.. MOUNT TOP @ 6'-7" A.F.F. ON WALL - TYPICAL.
- 25. VINYL FRENCH SLIDING DOOR UNIT PAINTED. SEE DOOR SCHEDULE FOR MORE
- 26. DECORATIVE WALL BRACKET FYPON BKT7XI2x4.
- 27. SLOPED BRICK ROWLOCK BELT COURSE.
- 28. 5/4 PILASTER TRIM CUT TO FIT BETWEEN WINDOWS.
- 32. EYEBROW LOUVER BY FYPON 1'-6" WIDE X.2'-6" HIGH OR EQUAL.
- 33. PROVIDE STEP FLASHING AND COUNTER FLASHING MIN. 16" HIGH THE ENTIRE LENGTH OF VERTICAL WALL ADJACENT TO ROOF - TYPICAL.
- 34. HEAD AND SILL WINDOW TRIM TO CONTINUE TO ADJACENT CORNER TRIM. TRIM INFILL BETWEEN WINDOW JAMB AND CORNER TRIM OR CUT WINDOW TRIM AS
- 35. POURED CONCRETE STEPS WITH II" TREAD AND 8 1/4" RISER MAXIMUM.
- 36. 2 X 8 PAINTED WOOD HEAD TRIM WITH 2" OVERHANG EACH SIDE.
- 37. 2 X IO PAINTED WOOD EYEBROW TRIM. END OF TRIM TO BE 2" LESS THAN HEIGHT
- 38. WOOD GUARD RAIL SEE DETAIL K ON SHEET A.304.
- 39. $5/4 \times 8$ TRIM SEE WALL SECTION D ON SHEET A.301.
- 40. WINDOWS IN GARAGE DOORS OPTIONAL.
- 41. DORMER LOCATION. SEE WALL SECTION ON SHEET A.303A FOR MORE
- 42. VINYL SHAKE SIDING.

Scale: 3/16'' = 1'-0''

ALL SIDING & TRIM TO BE LOUSIANA PACIFIC "SMART SIDE" CEDAR GRAIN TEXTURE (UNLESS NOTED OTHERWISE) - SIZES AS INDICATED.

ommunities Place ark Villas

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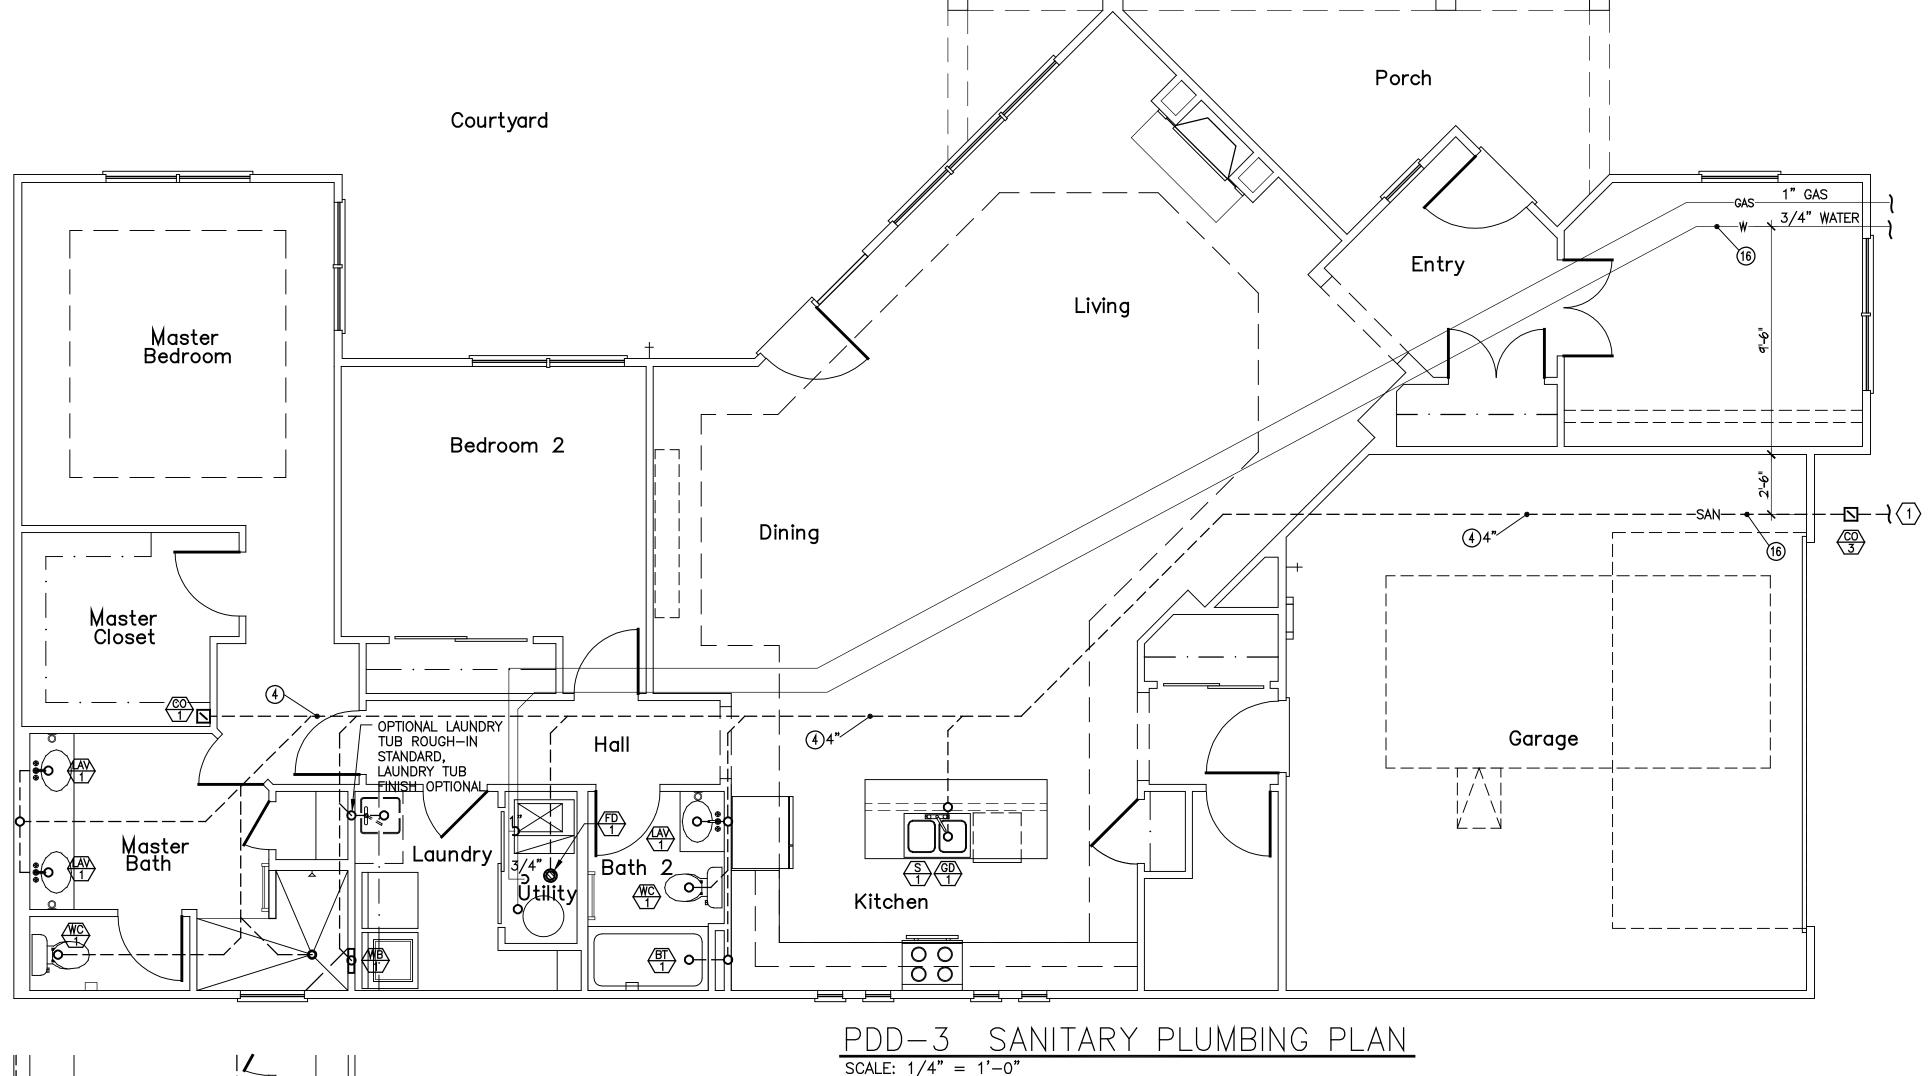
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Drawing Title

Exterior Elevations

Architectural Style European Country

Sheet Number D3 - 2010




MASTER BATH - OPTIONAL ALT

WALK-IN SHOWER

SCALE: 1/4" = 1'-0"

NOTE: PENETRATIONS OF FLOOR—CEILING ASSEMBLIES AND WALL ASSEMBLIES REQUIRED TO HAVE A FIRERESISTANCE RATING MUST MAINTAIN THE INTEGRITY OF THE FIRERESISTANCE—RATED ASSEMBLY AND LIMIT THE SPREAD OF FIRE AND SMOKE. FIRE/SMOKE STOPPING MATERIAL SHALL BE U.L. APPROVED AND SHALL BE RATED FOR THE TYPE OF FIRERESISTANT RATED ASSEMBLY AND THE MATERIAL TYPE OF THE PENETRANT.

NOTE: PVC DRAIN, WASTE AND VENT PIPING AND COPPER WATER PIPING PASSING THROUGH A STRUCTURAL MEMBER WITHIN 1-1/2" FROM THE NEAREST EDGE MUST BE PROTECTED BY A 1/16" STEEL PLATE TO PREVENT FASTENER PENETRATION. NOTE: NO PIPING SHALL BE LOCATED DIRECTLY ABOVE ELECTRIC PANELS, SEE ELECTRIC PLANS FOR LOCATIONS.

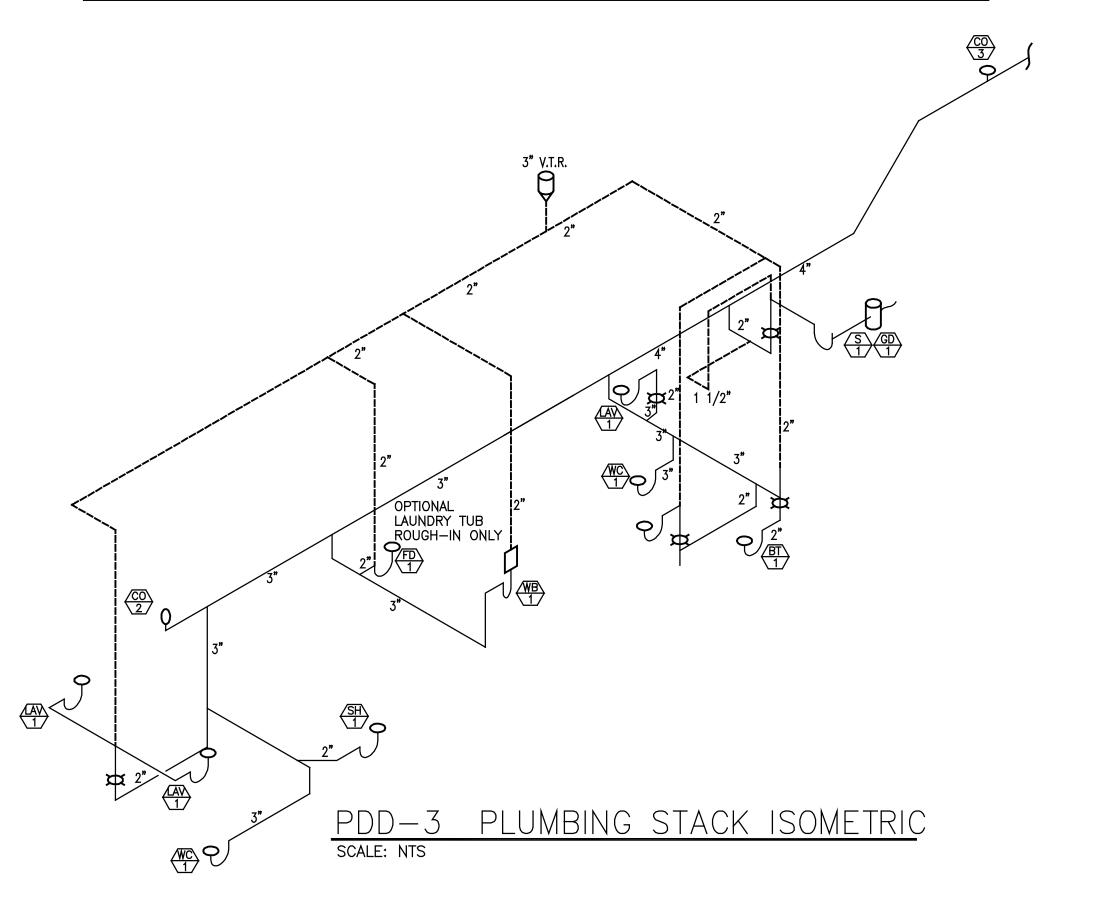

PLUMBING DESIGN CRITERIA

-SANITARY BUILDING SERVICES SHALL BE SDR-35 AND AS APPROVED FOR USE BY LOCAL UTILITY.

-SANITARY DRAIN WASTE AND VENT PIPING SHALL BE SCHEDULE #40 PVC SOLVENT WELD PIPE AND FITTINGS. PIPING SHALL BE SLOPED AS FOLLOWS: 3" AND SMALLER: 1/4" PER FT. 4" AND LARGER: 1/8" PER FT.

-WATER SERVICE SUPPLY PIPING SHALL BE POLYTHYLENE TUBING OR TYPE 'K' SOFT COPPER AND AS APPROVED FOR USE BY LOCAL UTILITY.

-PROVIDE 3/4" WATER SERVICE TO EACH BUILDING. COORDINATE WITH LOCAL WATER UTILITY.

-PROVIDE WATTS NO. 7D BACKFLOW DEVICE ON WATER SERVICE TO EACH INDIVIDUAL UNIT.

-PROVIDE MINIMUM 1/2" WATER SUPPLY PIPE TO EACH PLUMBING FIXTURE. PIPING TO BE INSTALLED BELOW FLOOR SLAB. (NO FITTINGS PERMITTED BELOW SLAB),

WATER SUPPLY PIPING SHALL BE AS FOLLOWS: o TYPE 'K' SOFT COPPER TUBING - BELOW SLAB. TYPE 'L' HARD COPPER TUBING - ABOVE SLAB.
CPVC COILED PLASTIC TUBING - BELOW SLAB. o CPVC RIGID PLASTIC TUBING - ABOVE SLAB.

-GAS SERVICE SUPPLY PIPING SHALL BE AS REQUIRED BY LOCAL GAS UTILITY.

o FIRE PIT

-PROVIDE GAS METER AND RISER ASSEMBLY FOR EACH UNIT PER LOCAL GAS UTILITY REQUIREMENTS.

-PROVIDE MINIMUM 1/2" GAS SUPPLY PIPE TO EACH DESIGNATED PIECE OF EQUIPMENT. PIPING TO BE INSTALLED IN VENTILATED ATTIC. GAS SUPPLY PIPING SHALL BE AS FOLLOWS: o SCHEDULE #40 BLACK STEEL PIPE. CSST TUBING

-PROVIDE GAS SUPPLY PIPE TO THE FOLLOWING EQUIPMENT: o FURNACE o WATER HEATER o FIREPLACE o RANGE

-ALL PIPING SYSTEMS SHALL COMPLY WITH STATE AND LOCAL CODE REQUIREMENTS.

-ALL MATERIALS AND INSTALLATION OF PLUMBING SYSTEMS SHALL COMPLY WITH STATE AND LOCAL BUILDING CODE REQUIREMENTS.

-WATER HEATER SHALL BE 40 GALLON GAS FIRED WITH 35,000 BTUH GAS INPUT. o INSTALL CODE APPROVED, SELF CLOSING TEMPERATURE AND PRESSURE RELIEF VALVE AND DISCHARGE INDIRECTLY INTO

O INSTALL HEAT TRAPS ON CW AND HW SUPPLY PIPES. O INSTALL THERMAL EXPANSION TANK ON CW SUPPLY PIPE TO WATER HEATER.

-WATER HEATER SHALL BE ADJUSTED TO DELIVER NO MORE THAN

-SHOWER VALVES SHALL BE THERMOSTATIC/PRESSURE BALANCE TYPE MIXING VALVES WITH MAXIMUM WATER TEMPERATURE ADJUSTED TO DELIVER NO MORE THAN 110° F HW.

-EACH FIXTURE OR PIECE OF EQUIPMENT SHALL BE INSTALLED WITH INDIVIDUAL SHUT-OFF VALVES. -SHOCK ARRESTORS SHALL BE INSTALLED ON WATER SUPPLY PIPING

WHERE QUICK CLOSING VALVES ARE CONNECTED TO THE SYSTEM. (I.E. DISHWASHER/WASHING MACHINE).

-PROVIDE 1/2" CW SUPPLY PIPE WITH 1/4 TURN BALL VALVE PVC VALVE BOX FOR ICE MAKER,

-PROVIDE 1/2" HW SUPPLY PIPE WITH 1/4 TURN BALL VALVE FOR DISHWASHER. PROVIDE 5/8" DRAIN LINE FROM DISHWASHER TO GARBAGE DISPOSAL. -INSTALL 1/3 H.P. GARBAGE DISPOSAL IN SINK COMPARTMENT

CLOSEST TO DISHWASHER. EXCEPTION: ON SINK UPGRADE, G.D. TO BE INSTALLED IN VEGTABLE BOWL. -PROVIDE 1/2"CW/HW SUPPLY PIPES WITH 1/4 TURN VALVES, 2" DRAIN LINE AND PVC BOX FOR WASHING MACHINE.

-NO WATER PIPING TO BE LOCATED IN EXTERIOR WALL. PIPE ROUGH-INS SHALL BE LOCATED IN BASE CABINET BELOW FIXTURE. -INSTALL CLEANOUTS ON BUILDING SANITARY DRAINS AT MAXIMUM

100FT. O.C. AND CHANGES GREATER THAN 45°. -INSTALL FLOOR DRAIN IN WATER HEATER CLOSET. -PROVIDE TRAP PRIMER VALVE FOR ALL FLOOR DRAINS AND HUB DRAINS.

PLUMBING PLAN NOTES

- 4" SANITARY BUILDING DRAIN LOCATED BELOW FLOOR SLAB. SLOPE MINIMUM 1/8" PER FT.
- 2 3/4" WATER SUPPLY PIPING LOCATED BELOW FLOOR SLAB. INSTALL MINIMUM 48" BELOW GRADE.
- 3 1/2" (2LB.) CSST GAS SUPPLY PIPE FROM METER SET TO MANIFOLD, INSTALL IN VENTILATED ATTIC.
- SANITARY BRANCH PIPING FOR 1st FLOOR FIXTURES TO BE LOCATED BELOW FIRST FLOOR SLAB.
- 6 HOT AND COLD WATER PIPING FOR 1st FLOOR FIXTURES TO BE LOCATED BELOW FIRST FLOOR SLAB, (NO FITTINGS BELOW SLAB).
- GAS PIPING FOR 1st FLOOR EQUIPMENT TO BE LOCATED IN VENTILATED ATTIC.
 EXTEND INDIVIDUAL "CSST" GAS SUPPLY PIPES FROM MANIFOLD TO EACH INDIVIDUAL PIECE OF EQUIPMENT. (NO FITTINGS).
- DISHWASHER.
 PROVIDE 1/2" VALVED HW WITH FLEX HOSE TO DW.
 PROVIDE 5/8" FLEX DRAIN LINE FROM D.W. TO G.D.
- 8 ICE MAKER VALVE BOX. PROVIDE 1/2" VALVED CW WITH 3/8" FLEX HOSE TO ICE MAKER.
- 9 FURNACE, PROVIDE 3/4" CSST WARD FLEX GAS SUPPLY PIPE TO FURNACE. INSTALL GAS VALVE AT CONNECTION TO EQUIPMENT.
- WATER HEATER.
 PROVIDE 3/4" CSST WARD FLEX GAS SUPPLY PIPE TO WATER HEATER. INSTALL GAS VALVE AT CONNECTION TO EQUIPMENT.
- RANGE, (OPTIONAL)
 PROVIDE 1/2" CSST WARD FLEX GAS SUPPLY PIPE
 TO RANGE, INSTALL GAS VALVE AT CONNECTION TO EQUIPMENT.
- FIREPLACE.
 PROVIDE 1/2* CSST WARDFLEX GAS SUPPLY PIPE
 TO VENTED FIREPLACE. INSTALL BRASS SHUT-OFF VALVE AND KEY. FIRE PIT. (OPTIONAL)
 PROVIDE 1/2" CSST WARDFLEX GAS SUPPLY PIPE
 TO FIRE PIT. INSTALL BRASS SHUT-OFF VALVE
 AND KEY AT 18" ABOVE GRADE.
- (VERIFY EXACT LOCATION WITH G.C.) 1/2" TYPE "K" FLEX COPPER GAS SUPPLY PIPE. INSTALL IN PVC CONDUIT 12 "-18" BELOW GRADE. COORDINATE INSTALLATION WITH G.C.
- 15) 4" SANITARY DOWN IN CHASE TO TIE INTO FIRST FLOOR SANITARY.
- 16 PLUMBER TO PROVIDE 4" PVC SLEEVE FOR WATER AND 4" SANITARY LINE FOR INSTALLATION BY FOOTER CONTRACTOR.



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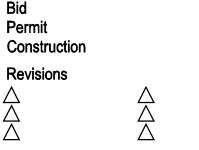
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Prototype	Interim Page Revisions				
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		2/17/12			

ENERGY REQUIREMENTS.

Architect Project Number 2010-005

Community Dates & Revisions Date Originated 1 FEB 2015 Permit Construction





Drawing Title Plumbing Plans

Architectural Style European Country

Sheet Number

D3 - 2010

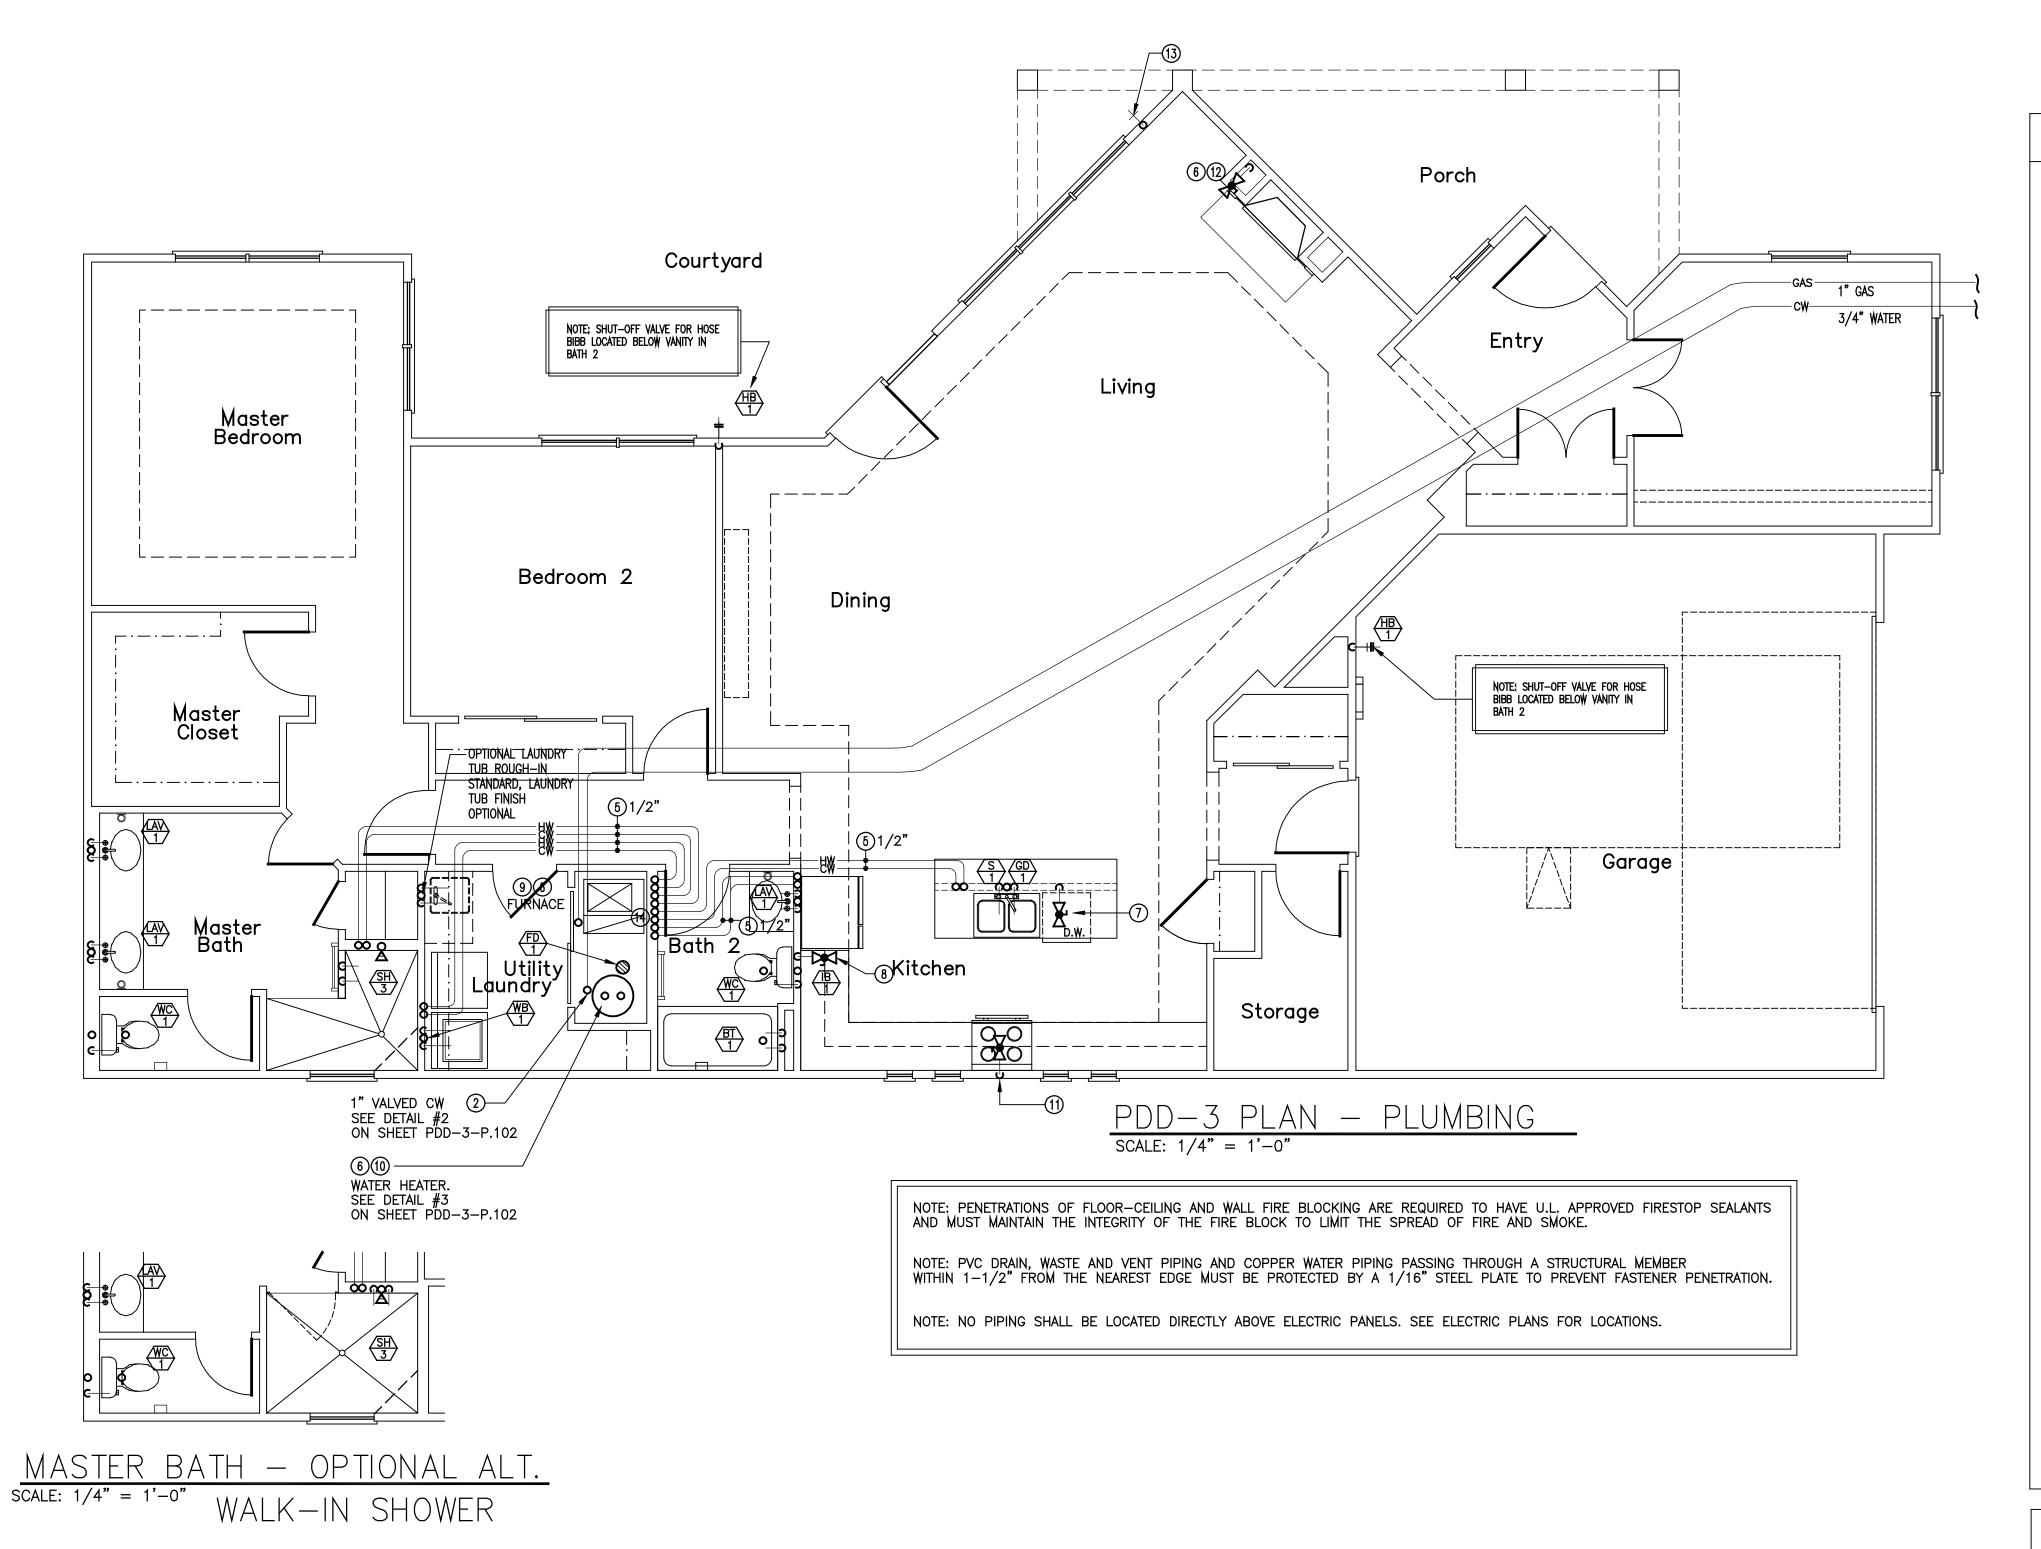

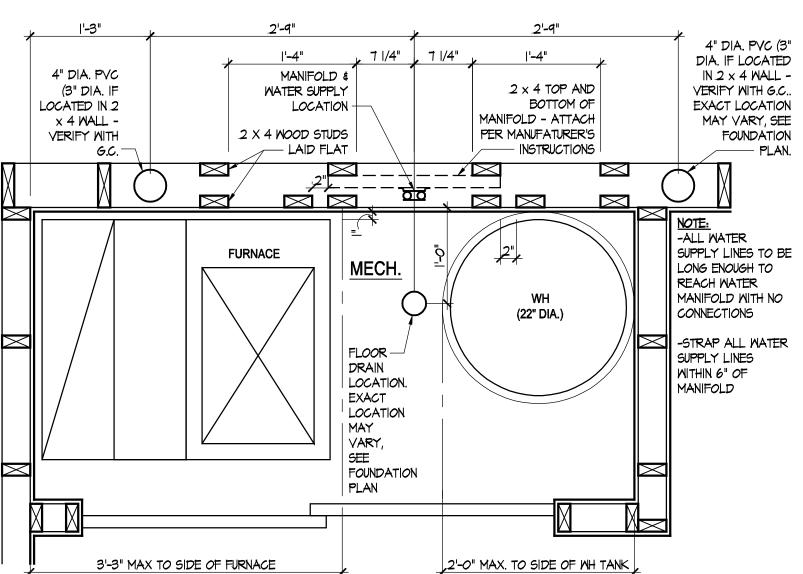

PLUMBING DESIGN CRITERIA

-SANITARY BUILDING SERVICES SHALL BE SDR-35 AND AS APPROVED FOR USE BY LOCAL UTILITY.

-SANITARY DRAIN WASTE AND VENT PIPING SHALL BE SCHEDULE #40 PVC SOLVENT WELD PIPE AND FITTINGS. PIPING SHALL BE SLOPED AS FOLLOWS: 3" AND SMALLER: 1/4" PER FT. 4" AND LARGER: 1/8" PER FT.

-WATER SERVICE SUPPLY PIPING SHALL BE POLYTHYLENE TUBING OR TYPE 'K' SOFT COPPER

AND AS APPROVED FOR USE BY LOCAL UTILITY. -PROVIDE 3/4" WATER SERVICE TO EACH BUILDING.

COORDINATE WITH LOCAL WATER UTILITY. -PROVIDE WATTS NO. 7D BACKFLOW DEVICE ON WATER SERVICE TO EACH INDIVIDUAL UNIT.

-PROVIDE MINIMUM 1/2" WATER SUPPLY PIPE TO EACH PLUMBING FIXTURE. PIPING TO BE INSTALLED BELOW FLOOR SLAB. (NO FITTINGS PERMITTED BELOW SLAB).

WATER SUPPLY PIPING SHALL BE AS FOLLOWS: o TYPE 'K' SOFT COPPER TUBING - BELOW SLAB, o TYPE 'L' HARD COPPER TUBING - ABOVE SLAB. o CPVC COILED PLASTIC TUBING - BELOW SLAB. o CPVC RIGID PLASTIC TUBING - ABOVE SLAB.

-GAS SERVICE SUPPLY PIPING SHALL BE AS REQUIRED BY LOCAL GAS UTILITY.

-PROVIDE GAS METER AND RISER ASSEMBLY FOR EACH UNIT PER LOCAL GAS UTILITY REQUIREMENTS.

-PROVIDE MINIMUM 1/2" GAS SUPPLY PIPE TO EACH DESIGNATED PIECE OF EQUIPMENT, PIPING TO BE INSTALLED IN VENTILATED ATTIC. GAS SUPPLY PIPING SHALL BE AS FOLLOWS; o SCHEDULE #40 BLACK STEEL PIPE. o CSST TUBING.

-PROVIDE GAS SUPPLY PIPE TO THE FOLLOWING EQUIPMENT: o FURNACE

o WATER HEATER o FIREPLACE

o RANGE o FIRE PIT

-ALL PIPING SYSTEMS SHALL COMPLY WITH STATE AND LOCAL CODE REQUIREMENTS.

-ALL MATERIALS AND INSTALLATION OF PLUMBING SYSTEMS SHALL COMPLY WITH STATE AND LOCAL BUILDING CODE REQUIREMENTS.

-WATER HEATER SHALL BE 40 GALLON GAS FIRED WITH 35,000 BTUH GAS INPUT. o INSTALL CODE APPROVED, SELF CLOSING TEMPERATURE AND PRESSURE RELIEF VALVE AND DISCHARGE INDIRECTLY INTO

O INSTALL HEAT TRAPS ON CW AND HW SUPPLY PIPES.
O INSTALL THERMAL EXPANSION TANK ON CW SUPPLY PIPE TO WATER HEATER.

-WATER HEATER SHALL BE ADJUSTED TO DELIVER NO MORE THAN

-SHOWER VALVES SHALL BE THERMOSTATIC/PRESSURE BALANCE TYPE MIXING VALVES WITH MAXIMUM WATER TEMPERATURE ADJUSTED TO DELIVER NO MORE THAN 110° F HW.

-EACH FIXTURE OR PIECE OF EQUIPMENT SHALL BE INSTALLED WITH INDIVIDUAL SHUT-OFF VALVES.

-SHOCK ARRESTORS SHALL BE INSTALLED ON WATER SUPPLY PIPING WHERE QUICK CLOSING VALVES ARE CONNECTED TO THE SYSTEM. (I,E, DISHWASHER/WASHING MACHINE).

-PROVIDE 1/2" CW SUPPLY PIPE WITH 1/4 TURN BALL VALVE PVC VALVE BOX FOR ICE MAKER,

-PROVIDE 1/2" HW SUPPLY PIPE WITH 1/4 TURN BALL VALVE PROVIDE 5/8" DRAIN LINE FROM DISHWASHER TO GARBAGE DISPOSAL. -INSTALL 1/3 H.P. GARBAGE DISPOSAL IN SINK COMPARTMENT CLOSEST TO DISHWASHER.

EXCEPTION: ON SINK UPGRADE, G.D. TO BE INSTALLED IN VEGTABLE BOWL -PROVIDE 1/2"CW/HW SUPPLY PIPES WITH 1/4 TURN VALVES,

2" DRAIN LINE AND PVC BOX FOR WASHING MACHINE,

-NO WATER PIPING TO BE LOCATED IN EXTERIOR WALL. PIPE ROUGH-INS SHALL BE LOCATED IN BASE CABINET BELOW FIXTURE.

-INSTALL CLEANOUTS ON BUILDING SANITARY DRAINS AT MAXIMUM 100FT. O.C. AND CHANGES GREATER THAN 45°.

-INSTALL FLOOR DRAIN IN WATER HEATER CLOSET.

-PROVIDE TRAP PRIMER VALVE FOR ALL FLOOR DRAINS AND HUB DRAINS,

PLUMBING PLAN NOTES

4" SANITARY BUILDING DRAIN LOCATED BELOW FLOOR SLAB. SLOPE MINIMUM 1/8" PER FT.

1" WATER SUPPLY PIPING LOCATED BELOW FLOOR SLAB. INSTALL MINIMUM 48" BELOW GRADE.

3 1/2" (2LB.) CSST GAS SUPPLY PIPE FROM METER SET TO MANIFOLD. INSTALL IN VENTILATED ATTIC.

4) SANITARY BRANCH PIPING FOR 1st FLOOR FIXTURES TO BE LOCATED BELOW FIRST FLOOR SLAB.

6 HOT AND COLD WATER PIPING FOR 1st FLOOR FIXTURES TO BE LOCATED BELOW FIRST FLOOR SLAB. (NO FITTINGS BELOW SLAB).

GAS PIPING FOR 1st FLOOR EQUIPMENT TO BE LOCATED IN VENTILATED ATTIC.

EXTEND INDIVIDUAL "CSST" GAS SUPPLY PIPES FROM MANIFOLD TO EACH INDIVIDUAL PIECE OF EQUIPMENT. (NO FITTINGS).

7 DISHWASHER.
PROVIDE 1/2" VALVED HW WITH FLEX HOSE TO DW.
PROVIDE 5/8" FLEX DRAIN LINE FROM D.W. TO G.D.

8 ICE MAKER VALVE BOX. PROVIDE 1/2" VALVED CW WITH 3/8" FLEX HOSE TO ICE MAKER.

9 FURNACE.
PROVIDE 3/4" CSST WARD FLEX GAS SUPPLY PIPE
TO FURNACE. INSTALL GAS VALVE AT CONNECTION TO EQUIPMENT.

WATER HEATER.
PROVIDE 3/4" CSST WARD FLEX GAS SUPPLY PIPE
TO WATER HEATER. INSTALL GAS VALVE AT CONNECTION TO EQUIPMENT.

RANGE. (OPTIONAL)
PROVIDE 1/2" CSST WARD FLEX GAS SUPPLY PIPE
TO RANGE. INSTALL GAS VALVE AT CONNECTION TO EQUIPMENT.

FIREPLACE.
PROVIDE 1/2" CSST WARDFLEX GAS SUPPLY PIPE
TO VENTED FIREPLACE, INSTALL BRASS SHUT-OFF VALVE AND KEY.

OPTIONAL GAS BIB — PROVIDE 1/2" CSST WARDFLEX GAS SUPPLY PIPE. INSTALL PER ALL APPLICABLE CODES. (VERIFY EXACT LOCATION WITH G.C.).

(14) SEE DETAIL THIS SHEET FOR EXACT MANIFOLD LOCATION.

HOT AND COLD WATER PIPING FOR 2nd FLOOR FIXTURES TO BE ROUTED UP TO 2nd FLOOR JOIST SPACE.



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ENERGY REQUIREMENTS.

Prototype	Interim Pag	e Revisions
Disk No.	Revision	Date
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Revisions	$\stackrel{\triangle}{\wedge}$	


Drawing Title Supply Plumbing Plan

Architectural Style

European Country


Sheet Number P.101 D3 - 2010

		PIPING				
ITEM	DESCRIPTION	WASTE	VENT	НОТ	COLD	ACCESSORIES
₩C-1	WATER CLOSET	3"	1-1/2"		1/2"	SEAT: BEMIS NO. 60
LAV-1	LAVATORY	1-1/2"	1-1/2"	1/2"	1/2"	
BT-1	BATHTUB	1-1/2"	1-1/2"	1/2"	1/2"	LEFT OR RIGHT HAND OUTLET (SEE PLANS)
SH-1	SHOWER	2"	1-1/2"	1/2"	1/2"	LEFT OR RIGHT HAND OUTLET (SEE PLANS)
SH-2	SHOWER W/ BUILT-IN SEAT	2"	1-1/2"	1/2"	1/2"	LEFT OR RIGHT HAND OUTLET (SEE PLANS)
SH-3	CUSTOM TILED SHOWER	2"	1-1/2"	1/2"	1/2"	
S-1	SINK	1-1/2"	1-1/2"	1/2"	1/2"	
GD-1	GARBAGE DISPOSAL	1-1/2"				
IB-1	ICE MAKER BOX				1/2"	
₩B-1	WASHER BOX	2"	1-1/2"	1/2"	1/2"	
HB-1	FROST FREE HOSE BIBB				3/4"	INSTALL IN EACH GARAGE. MOUNT 18" A.F.F
FD-1	FLOOR DRAIN	3°				FURNISH WITH TRAP PRIMER
CO-1	CLEANOUT	4"				NICKALOY ACCESS COVER
CO-2	CLEANOUT	4"				STAINLESS STEEL ACCESS COVER
CO-3	CLEANOUT	4"				SEE DETAIL #5 ON THIS SHEET.

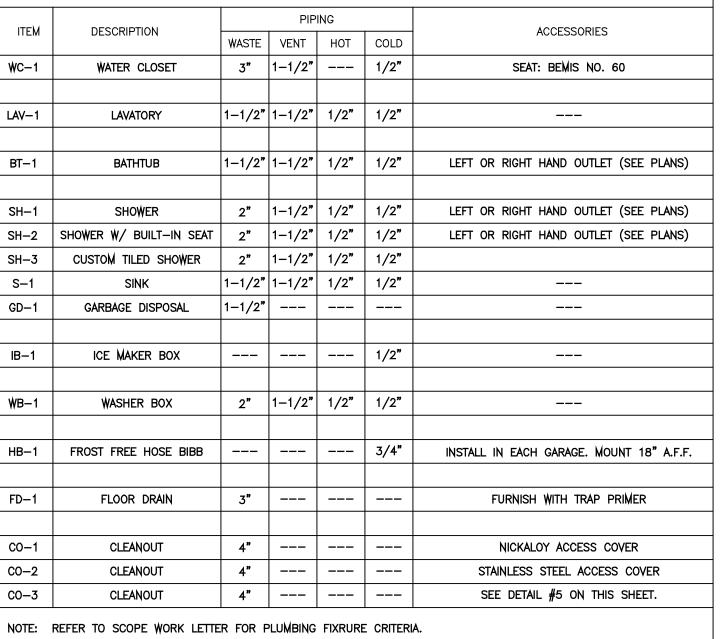


PLUMBING GENERAL NOTES


- 1. Refer to scope of work letter for plumbing specifications and and related work items.
- 2. Pressure test all piping systems:
- A. Sanitary and vent per State Plumbing Code. B. Building water 125 P.S.I. water for 24 hr., no drop. C. Building gas 50 P.S.I. nitrogen for 24 hr., no drop.
- 3. Sanitary service pipe shall be as required by local utility.
- 4. Water service pipe shall be as required by local utility.
- 5. Gas service pipe shall be as required by local utility.
- 6. Sanitary waste and vent piping shall be Schedule #40 (PVC) and as
- approved for use by Local Code.
- 7. Water distribution piping shall be Shedule #40 CPVC piping with solvent weld joints. Threaded connection to be brass.
- Gas distribution piping shall be code approved "CSST" plastic coated flexible stainless steel tubing with threaded fittings.
- Gas pipe rough—ins at equipment shall be schedule #40 black steel piping with threaded fittings.
- 10. Provide pipe hangers for all piping systems installed. Support at intervals not to exceed 4'-0". Support all piping at fittings, valves and unions. Locate all supports to allow for proper pitch and expansion of pipes.
- 11. Pitch 3" and smaller sanitary pipe 1/4" per foot. Pitch 4" and larger sanitary pipe 1/8" per foot. Pitch vent piping for drainage.
- 12. Provide blocking for all plumbing rough—in.
- 13. All piping for plumbing fixture rough—ins to be located in wall
- unless otherwise noted. 14. Chrome escutcheon plate shall be provided where pipe rough—in
- penetrates wall. 15. Provide chrome plated brass shut-off valve with chrome supply pipe
- at each water closet, lavatory and sink.
- 16. Bathtub and shower valves shall be equipped with integral shut-off valves.
- 17. Provide brass shut-off valves at water heater, dishwasher, icemaker water box and washer box.

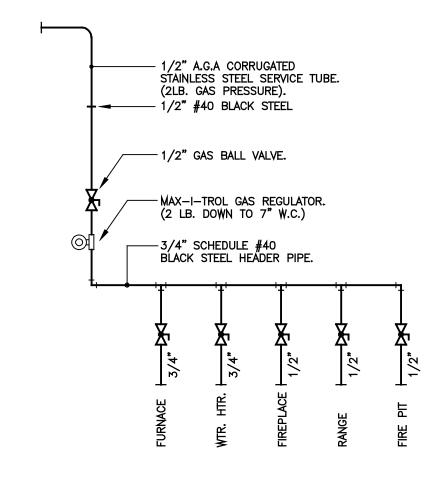

1 GAS HEADER PIPE DETAIL P.102 NTS

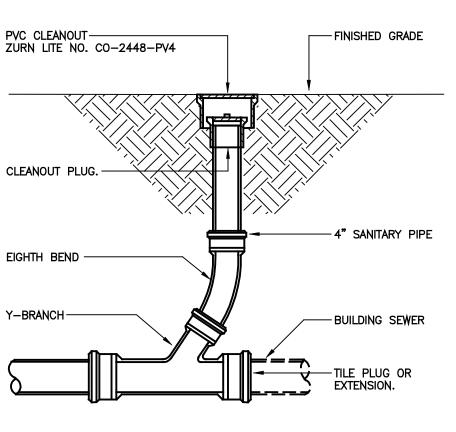


5 OUTSIDE CLEANOUT DETAIL P.102 NTS

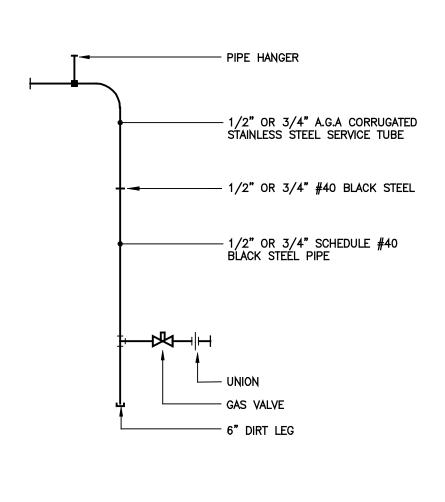



GAS PIPE


A CONNECTION DETAIL P.102 NTS

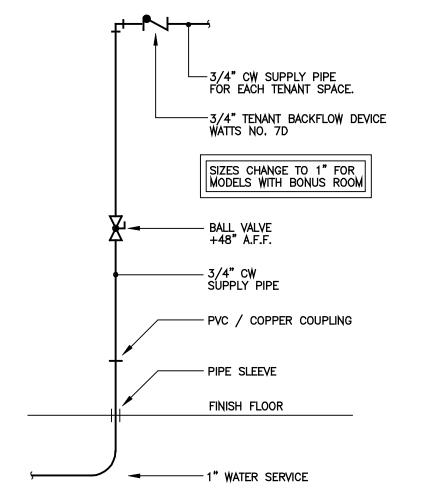

2 WATER SERVICE RISER DETAIL P.102/ N.T.S.

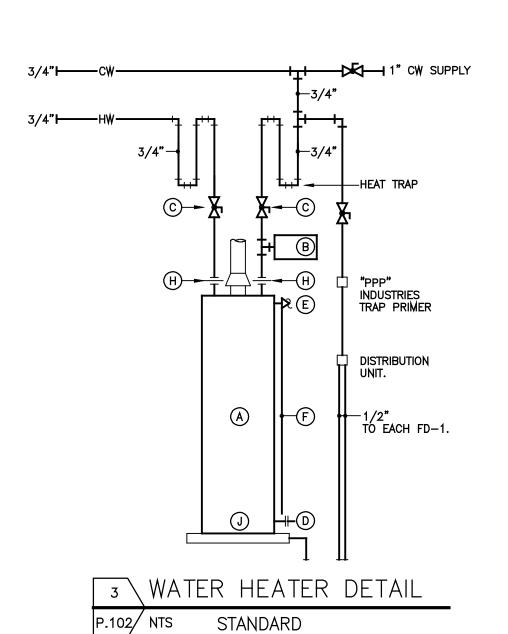

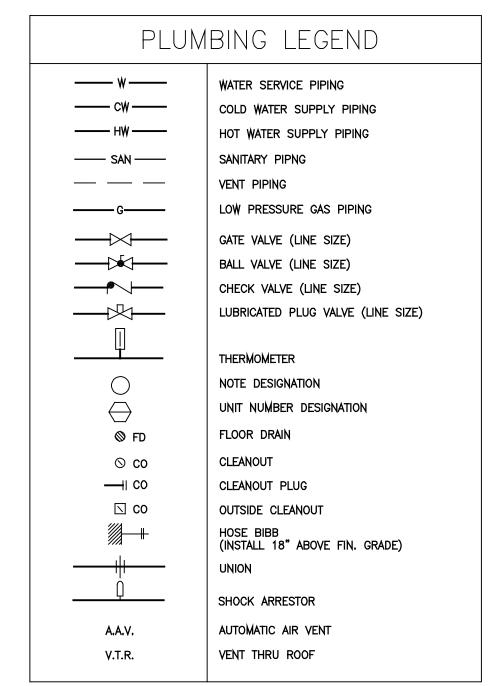

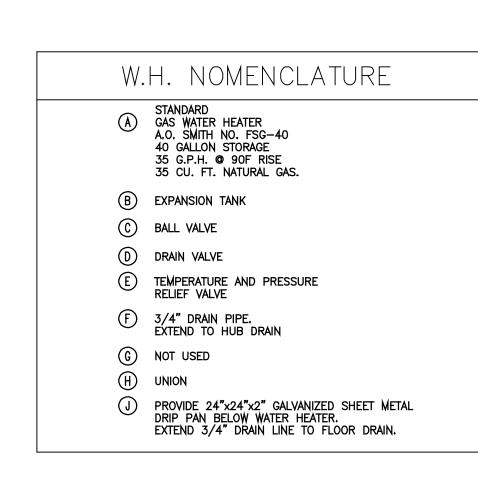



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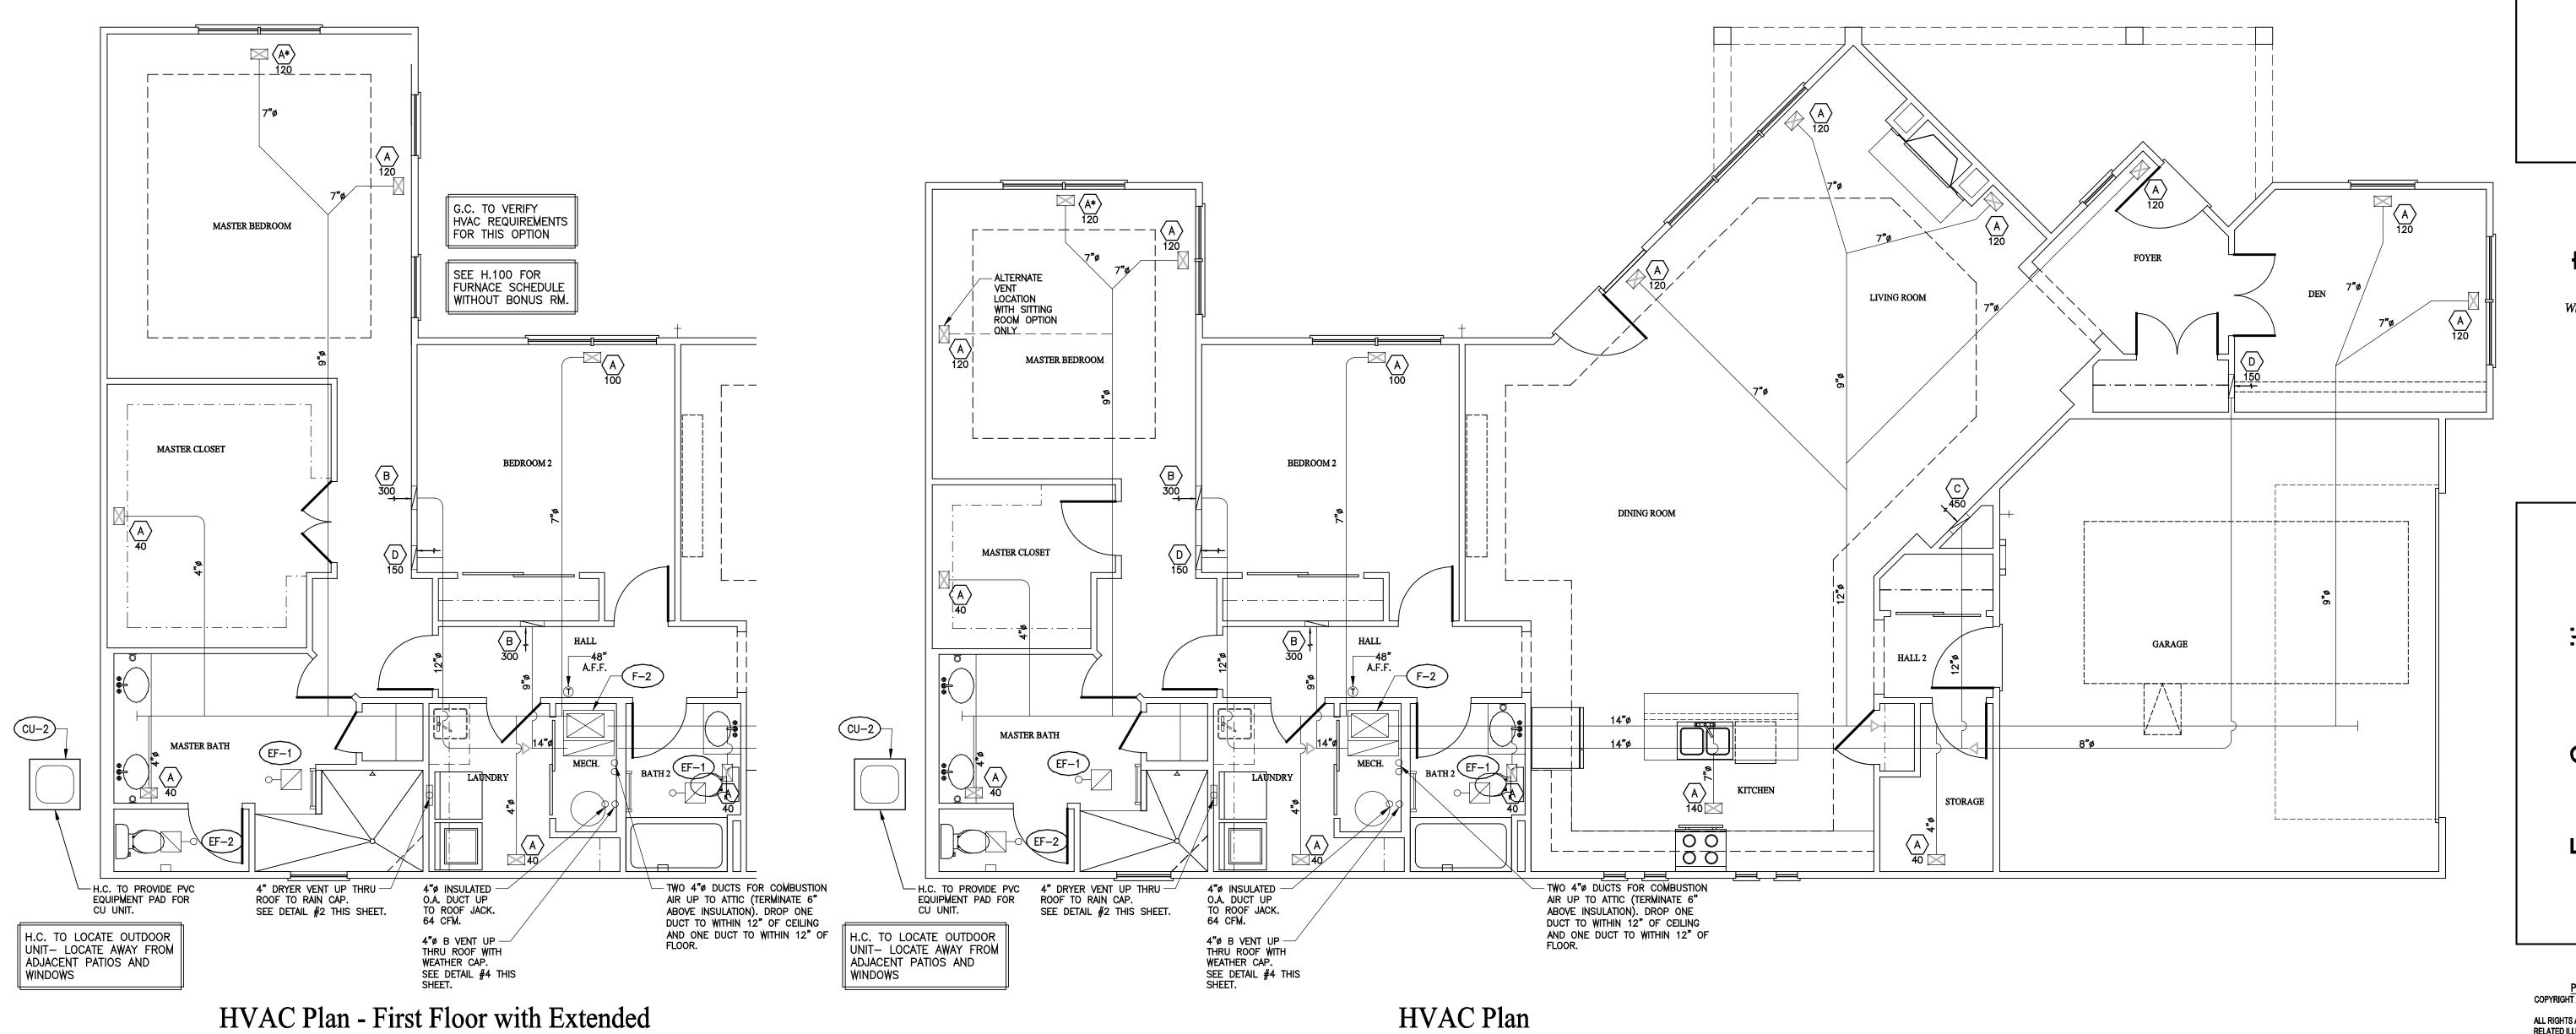
Architect Project Number 2010-005

Community Dates & Revisions 1 FEB 2015 Date Originated Permit Construction Revisions

Drawing Title Plumbing Specifications & Schedules

> Architectural Style **European Country**

> > **Sheet Number** P.102 D3 - 2010




HVAC Plan

Scale: 1/4" = 1'-0"

Scale: 1/4" = 1'-0"

Master Suite Option

Scale: 1/4" = 1'-0"

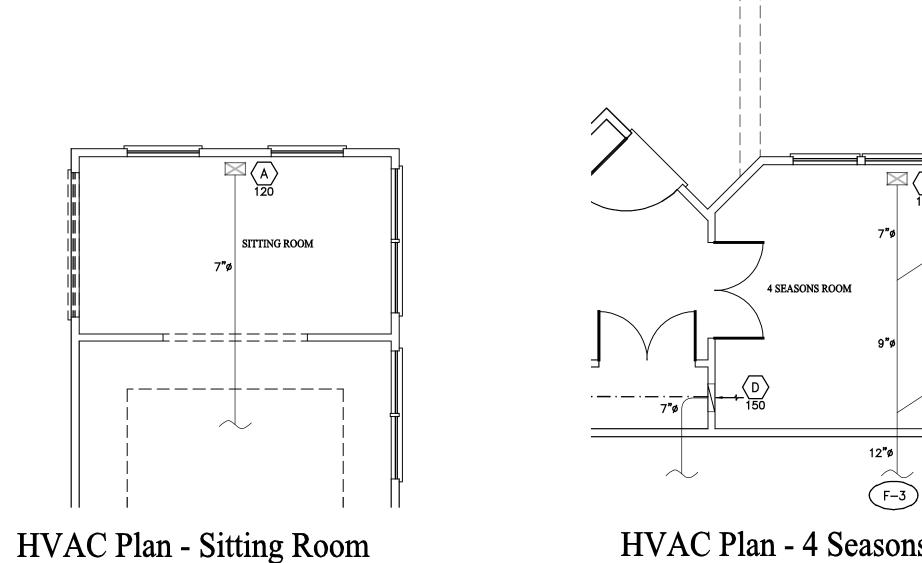

HVAC Plan - 4 Seasons Room

Scale: 1/4" = 1'-0"

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ENERGY REQUIREMENTS.

Architect Project Number 2010-005

Community Dates & Revisions 1 FEB 2015 Date Originated Bid Permit Construction Revisions

> Drawing Title **HVAC Plans**

Architectural Style **European Country**

Sheet Number H.100

			FUR	NACE							LING DIL				CON	DENSIN	IG UNI	Т			
SYMBOL	CARRIER	CFM	ESP	BLOWER	HEA	T. CAP.	Мвн	ELECT	RICAL	CARRIER C. D. TYPE		TYPE SYMBOL	TYPE CYAIROI	MODEL #	COOL. C	AP. MBH		ELECTRIC	AL	CEED	NOTES
SIMBOL	MODEL #	СЕМ	ESP	Η̈́P		OUTPUT	AFUE	ν./φ	FLA.	MODEL #	S.P.	ITPE	STMBOL		TOTAL	SENS.	٧/φ	M.C.A.	HACR. BKR	SEER N	NOTES
F-2	58MCB100-1-16	1570	0.5	場	100	93	92.3	120	7.9	CNRVP4221 W/ TXV EXP. VALVE			CU-2	24ABR342			240/1	25.4	40	13	1,2,3,4,5,6


- 2) FURNISH & INSTALL DIGITAL PROGRAMMABLE THERMOSTAT.
- 3) FURNISH CLEAN FILTER, 16"x25" AND SIDE FILTER RACK.
- 4) FURNISH & INSTALL 2" PVC COMBUSTION AND VENT PIPING WITH CONCENTRIC VENT KIT FOR THRU ROOF VENTING.
- 6) MOUNT UNIT ON LEVELING BLOCKS.

SYMBOL MODEL # CFM DRIVE ELECTRICAL DUTY DAMPER NOTES	FAN SCHEDULE								
EF-1 BROAN #670 50 DIRECT 120V TOILET GRAVITY 1,2, FAN ONLY									
EF-2 BROAN #678 OR NUTONE 763 RLN 50 DIRECT 120V TOILET GRAVITY 1,2, FAN AND LIGHT CON	ВО								

2) 4" EXHAUST VENT THROUGH ROOF WITH RAINCAP,

AIR DEVICE SCHEDULE									
SYMBOL	FACE SIZE	NECK SIZE	LIMA (OR EQUAL) MODEL NO.	MAX CFM	MOUNTING SURFACE	AIR PATTERN	NOTES		
A	12 " x6"	10"x4"	10V	200	GYP. BD.	2-WAY	1,2,3,4		
В	32"x8"	30"x6"	19H	260	GYP. BD.	RETURN	1,3,7		
С	32"x12"	30"x10"	19H	560	GYP. BD.	RETURN	1,3,5		
D	16"x8"	14"x6"	19H	130	GYP. BD.	RETURN	1,3,6		
1) 2) 3) 4)	FINISH TO BE STANDA FURNISH NECK MOUNT FRAME TO BE COMPA' SURFACE MOUNTINGS. CEILING MOUNTED.	TED OPP. BLADE DAMI TIBLE WITH PLASTER, I	DRYWALL, OR OTHER	6) L	OW SIDEWALL DUCT CONNECT TO TWO 14- CONNECT TO TWO 14- CONNECT TO ONE 14- COW SIDEWALL DUCT CONNECT TO TWO 14-	-1/2" X 5-1/2 OPENING @ 8" A	"R.A. RISERS. AFF.		

- FURNISH NECK MOUNTED OPP. BLADE DAMPER.
 FRAME TO BE COMPATIBLE WITH PLASTER, DRYWALL, OR OTHER SURFACE MOUNTINGS.
 CEILING MOUNTED.
- *SEE OPTIONAL FLOOR PLANS FOR VARYING VENT LOCATIONS
- HVAC LEGEND

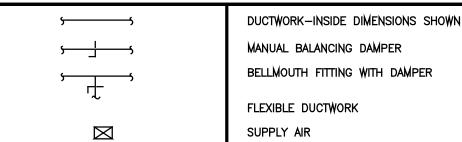

3. FURNISH AND INSTALL UL LISTED TYPE B-VENT FROM OUTLET ON DOMESTIC WATER HEATER AND EXTEND THRU ROOF WITH TERMINATIONS AS REQUIRED BY CODE. FURNISH AND INSTALL UL LISTED WEATHER CAP AND CONE FLASHING. 4. DUCTWORK SHALL MEET THE REQUIREMENTS OF SMACNA, NFPA 90A, OBC MECHANICAL CODE, ARTICLE 3. RECTANGULAR DUCTS SHALL BE CONSTRUCTED AND REINFORCED PER SMACNA DUCT CONSTRUCTION STANDARDS, SECTION I. ALL DUCTWORK SHALL BE SEALED IN ACCORDANCE WITH S.M.A.C.N.A. COORDINATE ALL EQUIPMENT AND DUCT RUNS WITH STRUCTURE, LIGHTS,

5, FLEXIBLE DUCTS SHALL BE 4" THRU 8" SUPPLY AIR BRANCH DUCTS AND 8" THRU 16" RETURN AIR DUCTS ONLY, AND COMPLY WITH NFPA REQUIREMENTS, PAMPHLET 90A AND SHALL BE UL LISTED WITH FLAME SPREAD RATING OF 25 OR LESS AND SMOKE DEVELOPED RATING OF 50 OR LESS. DUCT SHALL BE RATED FOR MINIMUM 10" W.G. INTERNAL WORKING PRESSURE, FOR ALL DUCT

SHEET METAL AND DUCTWORK

1. HVAC WORK SHALL BE LAID OUT WITH DUE CONSIDERATION FOR THE WORK OF

(CONTRACTORS) SHALL BE CORRECTED BY THE HVAC CONTRACTOR WITH NO

2. INSULATE ALL DUCTWORK IN ATTIC WITH FIBERGLASS DUCT WRAP INSULATION: R-8 MINIMUM.ALL OTHER DUCTS SHALL BE INSULATED TO A MINIMUM OF R-8.


OTHER TRADES. ANY CONFLICTS WHICH OCCUR DUE TO LACK OF COORDINATION BY THE HVAC CONTRACTOR WITH THE OTHER TRADES

ADDITIONAL COST TO THE OWNER.

CEILING, CONDUIT, PIPING, AND OTHER EQUIPMENT.

- 6. BALANCING DAMPERS SHALL BE GALVANIZED STEEL DAMPERS WITH LOCKING QUADRANT OPERATORS.
- 7. DUCTS, AIR HANDLERS, FILTER BOXES, AND BUILDING CAVITIES USED AS RETURN DUCTS SHALL BE SEALED. JOINTS AND SEAMS SHALL COMPLY WITH CURRENT MECHANICAL CODES. DUCT TIGHTNESS SHALL BE VERIFIED BY EITHER OF THE FOLLOWING: POST-CONSTRUCTION TEST
 - ROUGH-IN TEST EXCEPTION; DUCT TIGHTNESS TEST IS NOT REQUIRED IF THE AIR HANDLER AND ALL DUCTS ARE LOCATED WITHIN THE CONDITIONED SPACE.

MANUAL BALANCING DAMPER BELLMOUTH FITTING WITH DAMPER FLEXIBLE DUCTWORK \boxtimes RETURN AIR / EXHAUST AIR REFRIGERANT LINE SET CONDENSATE DRAIN PIPING DIAMETER (ROUND) PROGRAMMABLE THERMOSTAT (A) 150 AIR DEVICE SYMBOL WITH CFM \bigcirc PLAN NOTE SYMBOL EQUIPMENT NOTE SYMBOL; SEE SCHEDULES AND/OR NOTES. A.F.F. ABOVE FINISHED FLOOR CEILING FLOOR G.C. GENERAL CONTRACTOR PLUMBING CONTRACTOR H.C. HVAC CONTRACTOR F.P.C. FIRE PROTECTION CONTRACTOR E.C. ELECTRICAL CONTRACTOR SUPPLY AIR RETURN AIR 0.A. OUTSIDE AIR EXHAUST

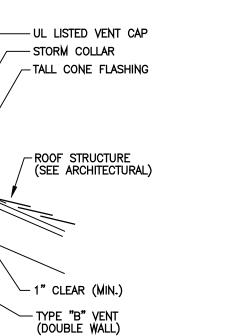

Flue Through Roof Detail


Scale: N.T.S.

FLUE SUPPORT

SEE PLAN FOR


SIZE AND CONTINUATION.—

MIN. 3'-0" ABOVE STRUCTURE.

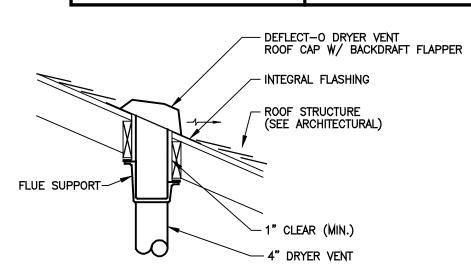

Dryer Vent Roof Cap Detail

Scale: N.T.S.

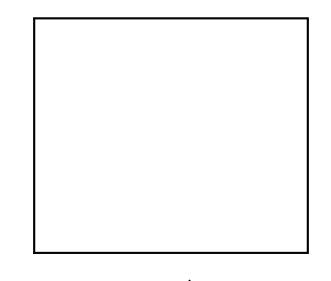



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Chester, ommunities Place Villas at Park Place V O Epcon

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THESE DRAWINGS SHALL BE USED IN CONFORMANCE WITH ALL LOCAL BUILDING, MECHANICAL, PLUMBING AND ELECTRICAL CODES AND SHALL MEET THE REQUIREMENTS OF THE HEALTH DEPARTMENT, FIRE MARSHALL, AMERICANS WITH DISABILITIES ACT ACCESSIBILITY GUIDELINES (ADAAG), THE FAIR HOUSING ACT ACCESSIBILITY GUIDELINES (FHAAG), AND SHALL BE CONSTRUCTED IN CONFORMANCE WITH STATE AND LOCAL ENERGY REQUIREMENTS.

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Prototype	Interim Pag	Interim Page Revisions					
Disk No.	Revision	Date					
		2/17/12					


Architect Project Number 2010-005

Community Dates & Revisions Date Originated 1 FEB 2015 Permit Construction Revisions

> Drawing Title **HVAC** Schedules & Details

Architectural Style European Country

> **Sheet Number** H.101

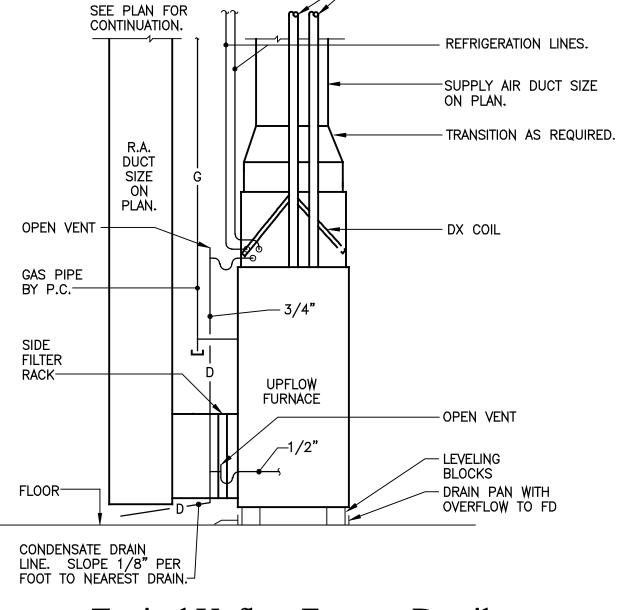


Typical Upflow Furnace Detail

Scale: N.T.S.

-PVC EXHAUST AND

INTAKE PIPES UP TO

CONCENTRIC VENT KIT.

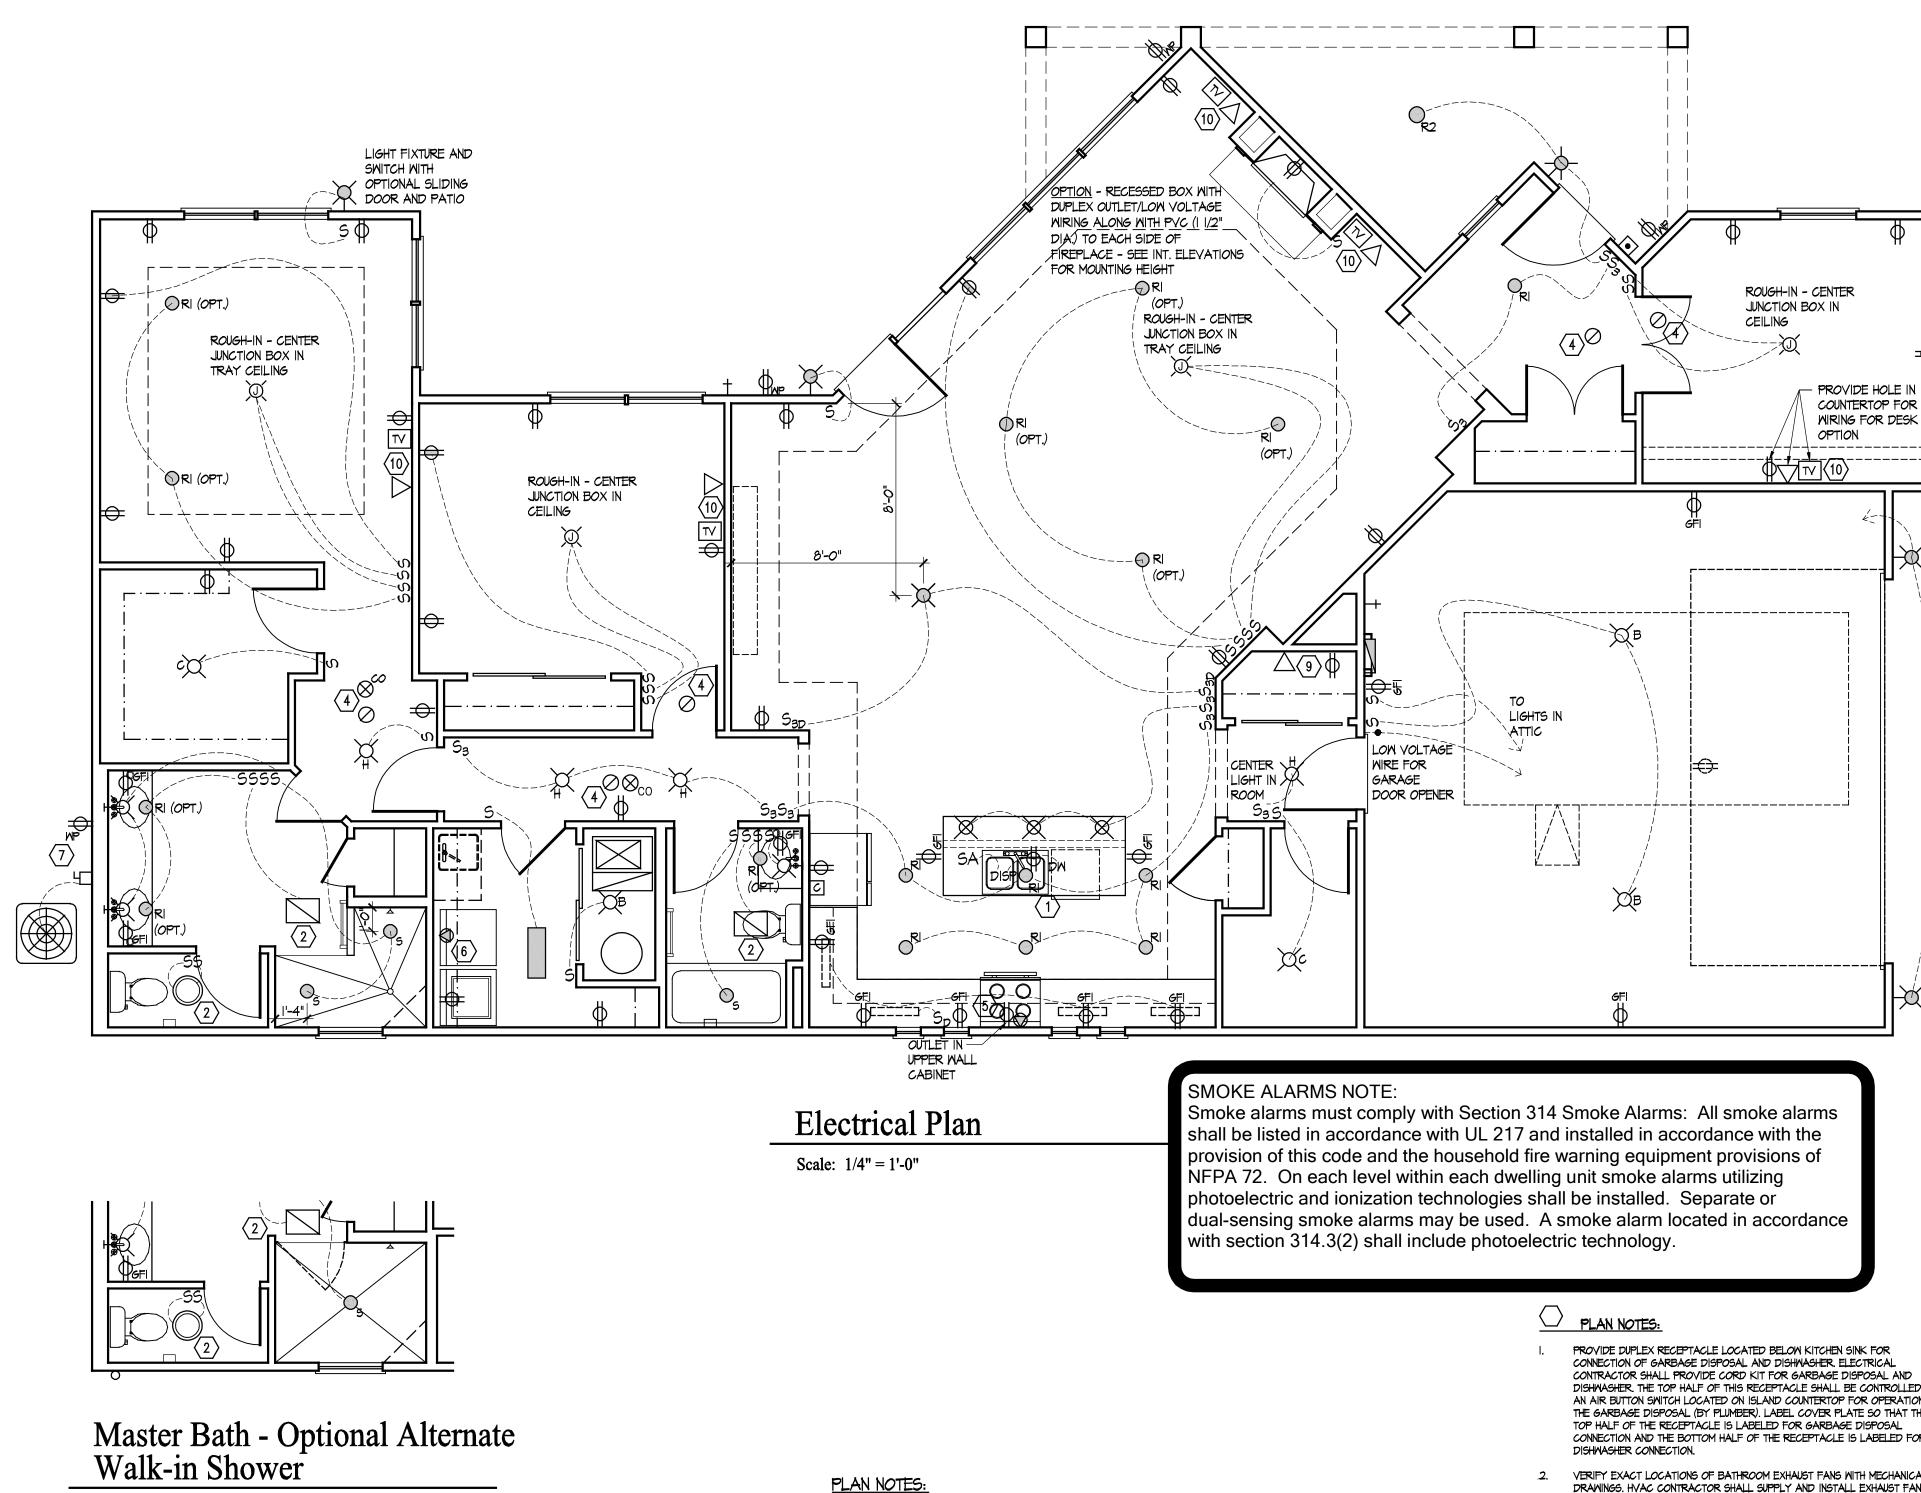

PROVIDE #6 CU TO GROUND ROD.

BUILDING STEEL

Electrical Riser Diagram

COMPANY PRIOR TO BID.

3. I25A FUSIBLE DISCONNECT.

FOOTER REINFORCING

STEEL ___

(1) #6 CU <

M

Scale: NTS

SERVICE PROVIDED BY UTILITY COMPANY. EC SHALL CONFIRM REQUIREMENTS WITH UTILITY

-(125-30)

(3) #1/O AL & (1) #6 CU GND. IN 1-1/2" CONDUIT OR 125A SER CABLE

120/240V

IPH 3M

125A MLO

Scale: 1/4" = 1'-0"

PROVIDE DUPLEX RECEPTACLE LOCATED BELOW KITCHEN SINK FOR CONNECTION OF GARBAGE DISPOSAL AND DISHWASHER, ELECTRICAL CONTRACTOR SHALL PROVIDE CORD KIT FOR GARBAGE DISPOSAL AND DISHWASHER. THE TOP HALF OF THIS RECEPTACLE SHALL BE CONTROLLED BY AN AIR BUTTON SMITCH LOCATED ON ISLAND COUNTERTOP FOR OPERATION OF THE GARBAGE DISPOSAL (BY PLUMBER). LABEL COVER PLATE SO THAT THE TOP HALF OF THE RECEPTACLE IS LABELED FOR GARBAGE DISPOSAL CONNECTION AND THE BOTTOM HALF OF THE RECEPTACLE IS LABELED FOR

GENERAL NOTES:

A. ALL WORK SHALL MEET OR EXCEED THE MOST CURRENT EDITION OF NATIONAL ELECTRICAL CODE, STATE CODE(S) AND LOCAL CODE(S). ELECTRICAL CONTRACTOR SHALL FURNISH ALL LABOR, MATERIALS,

HUBBELL, BRYANT, SLATER, LEVITON, OR EQUAL.

BY THE ELECTRICAL CONTRACTOR.

FIXTURES SHALL BE HIGH EFFICACY LAMPS.

ELECTRICAL CONTRACTOR SHALL ROUGH-IN APPROPRIATE WIRING, ETC. TO

RETROFIT THIS HOME WITH SMOKE DETECTORS WITH HORN AND STROBE, TTY

ALL LIGHTING FIXTURES SHALL BE SUPPLIED BY THE OWNER AND INSTALLED

A MINIMUM OF 50% OF THE LAMPS IN PERMANENTLY INSTALLED LIGHTING

A CARBON MONOXIDE DETECTOR SHALL BE PLACED OUTSIDE EACH

SLEEPING AREA, IN THE IMMEDIATE VICINITY OF THE BEDROOMS.

THE ANNULAR SPACE AROUND ALL PENETRATIONS IN GYPSUM BOARDS, INCLUDING WIRING AND ELECTRICAL BOXES, SHALL BE SEALED TIGHT.

ALL BEDROOM OUTLETS TO HAVE "COMBINATION-TYPE" ARC FAULT

TELEPHONES, AND DOORBELL WITH CHIME AND FLASHING LIGHT.

- 2. VERIFY EXACT LOCATIONS OF BATHROOM EXHAUST FANS WITH MECHANICAL DRAWINGS. HVAC CONTRACTOR SHALL SUPPLY AND INSTALL EXHAUST FAN AND DUCTING, WIRING BY ELECTRICAL CONTRACTOR.
- PROVIDE ELECTRICAL CONNECTION AND SAFETY SWITCH FOR FURNACE. VERIFY EXACT REQUIREMENTS WITH MANUFACTURERS NAMEPLATE.
- 4. PROVIDE 120 VOLT SMOKE ALARM WITH 9 VOLT BATTERY BACK-UP. SMOKE ALARMS SHALL BE CONNECTED TOGETHER SO THAT WHEN ONE SMOKE ALARM WITHIN A RESIDENCE SOUNDS, ALL SMOKE ALARMS WITHIN THAT RESIDENCE
- 5. PROVIDE 120/240 VOLT RANGE RECEPTACLE. THIS RECEPTACLE MUST BE PROVIDED WITH A GROUNDED CONDUCTOR AND AN EQUIPMENT GROUNDING CONDUCTOR PER THE NATIONAL ELECTRICAL CODE.
- 6. PROVIDE 120/240 VOLT DRYER RECEPTACLE FOR DRYER UNIT. THIS RECEPTACLE MUST BE PROVIDED WITH A GROUNDED CONDUCTOR AND AN EQUIPMENT GROUNDING CONDUCTOR PER THE NATIONAL ELECTRICAL CODE. PROVIDE A DUPLEX RECEPTACLE FOR WASHER.
- 7. PROVIDE ELECTRICAL CONNECTION AND DISCONNECT SWITCH FOR HEAT PUMP. VERIFY EXACT REQUIREMENTS WITH MANUFACTURERS NAMEPLATE.
- 8. PROVIDE ELECTRICAL CONNECTION AND SAFETY SWITCH FOR WATER HEATER. VERIFY EXACT REQUIREMENTS WITH MANUFACTURERS NAMEPLATE.
- 9. COAX/CATY HOME RUN LOCATION (75" A.F.F.).
- IO. ALL TV LOCATIONS TO RECEIVE A SINGLE GANG BOX WITH COAX/CATV

		LLLO I NIOAL LLOL		THE TAX TORLE GOLLEDOLL
ALL WORK SHALL MEET OR EXCEED THE MOST CURRENT EDITION OF THE NATIONAL ELECTRICAL CODE, STATE CODE(S) AND LOCAL CODE(S). ELECTRICAL CONTRACTOR SHALL FURNISH ALL LABOR, MATERIALS, APPLIANCES, EQUIPMENT, TOOLS, SUPERINTENDENCE, AND SERVICES AS	Ф	DUPLEX RECEPTACLE OUTLET	•	DOOR PUSH BUTTON
REQUIRED TO PROVIDE ELECTRICAL WORK AS SPECIFIED OR AS INTENDED ON THESE DRAWINGS.	#	QUADRUPLEX RECEPTACLE OUTLET	•	DIRECT WIRE APPLIANCE
ELECTRICAL CONTRACTOR SHALL VISIT THE SITE TO FAMILIARIZE THEMSELVES WITH THE SCOPE OF THE PROJECT PRIOR TO BID.	Φ _{σFI}	DUPLEX RECEPTACLE OUTLET WITH GROUND FAULT INTERRUPTER (GFI)		RECESSED MINI INCANDESCENT DOWN LIGHT FIXTURE
ELECTRICAL CONTRACTOR MUST VERIFY THE MOUNTING HEIGHTS OF ALL DEVICES WITH ARCHITECTURAL DRAWINGS PRIOR TO ROUGH-IN. ALL SWITCHES, RECEPTACLES, ETC. AND COVER PLATES SHALL BE WHITE IN COLOR.		DUPLEX RECEPTACLE OUTLET WITH	Os	SHOWER LIGHT
ELECTRICAL CONTRACTOR SHALL INSTALL ALL WIRING IN ACCORDANCE WITH THE CURRENT EDITIONS OF THE NATIONAL AND LOCAL ELECTRICAL CODES.	│ \$\psi_mp	WATERPROOF COVER \$ GFI	\bigcirc_{RI}	RECESSED INCANDESCENT DOWN LIGHT FIXTURE
ALL RECEPTACLES LOCATED OUTSIDE SHALL BE GFC! TYPE AND SHALL HAVE WEATHERPROOF IN-USE COVERS.	ф	DUPLEX RECEPTACLE OUTLET - SWITCH TOP OUTLET	O_{R2}	RECESSED INCANDESCENT EXTERIOR DOWN LIGHT FIXTURE
IN ALL AREAS SPECIFIED IN NEC 210.52, ALL 15 AND 20 AMP, 120 VOLT RECEPTACLES SHALL BE LISTED TAMPER-RESISTANT RECEPTACLES.	 ш	DUPLEX RECEPTACLE OUTLET-		
ELECTRICAL CONTRACTOR SHALL PROVIDE SAFETY SMITCHES FOR ALL HVAC AND PLUMBING EQUIPMENT IN ACCORDANCE WITH THE NATIONAL ELECTRICAL CODE.		SPECIAL	\bigcirc_{sc}	RECESSED INCANDESCENT FIXTURE (SLOPED CEILING)
DEVICES INSTALLED IN FIRE SEPARATION WALLS/CEILINGS SHALL BE INSTALLED IN ACCORDANCE WITH THE LISTING AND LABELING OF THE RATED	\triangle	TELEPHONE OUTLET (CATEGORY 5 WIRE TO ALL PHONE LOCATIONS)	Ф	RECESSED INCANDESCENT EYEBALL FIXTURE
ASSEMBLY. DO NOT INSTALL OUTLET BOXES WITHIN THE SAME STUD SPACE. SMOKE ALARMS SHALL BE CONNECTED TOGETHER SO THAT WHEN ONE SMOKE		DATA COMMUNICATIONS OUTLET	χc	SURFACE MOUNTED INCANDESCENT FIXTURE - CLOSETS
ALARM WITHIN A RESIDENCE SOUNDS, ALL SMOKE ALARMS WITHIN THAT RESIDENCE SOUND. SMOKE ALARMS SHALL NOT BE INSTALELD CLOSER THAN 3' IN FRONT OF HVAC SUPPLY GRILLES.	0	SMOKE DETECTOR	ЖH	SURFACE MOUNTED INCANDESCENT FIXTURE - HALLWAYS
LIGHT FIXTURES INSTALLED IN CLOSETS SHALL CONFORM TO NEC ARTICLE 410.8.	5	SINGLE POLE SMITCH	$\not\!$	EXTERIOR INCANDESCENT WALL BRACKET FIXTURE
KITCHEN COUNTERTOP RECEPTACLES AND BATHROOM RECEPTACLES SHALL BE GFCI PROTECTED VIA CLASS A GFCI TYPE CIRCUIT BREAKER. PROVIDE CLASS A GFCI CIRCUIT BREAKERS	s ₃	THREE-WAY SWITCH	$\not\!$	INTERIOR INCANDESCENT WALL SCONCE
EACH TELEPHONE OUTLET LOCATION SHALL BE PROVIDED WITH (I) CATEGORY 5E CABLE. PROVIDE FACEPLATE WITH (2) R.J-45 PORTS, ROUTE CABLES TO DEMANCATION LOCATION.	s ₄	FOUR-WAY SMITCH	Дв	KEYLESS PORCELAIN LAMP HOLDER
EACH CABLE TV OUTLET LOCATION SHALL BE PROVIDED WITH (1) RG6 VIDEO	S _D	DIMMER SWITCH	\bowtie	PENDANT FIXTURE - OPTIONAL
CABLE. PROVIDE FACEPLATE WITH (I) MALE PORT. ROUTE CABLES TO CONNECTION POINT. ALL SERVICE MAINS SHALL BE IDENTIFIED IN FIELD.	s _R	REMOTE SMITCH FOR LIGHT \$ 3-SPEED FAN CONTROL	X	CHANDELIER FIXTURE
EQUIPMENT, PANELS, SPECIAL DEVICE PLATES, AND SIMILAR MATERIAL SHALL BE CLEARLY MARKED. SIZE OF LETTERING AND WORDING SHALL BE APPROVED BY THE OWNERS REPRESENTATIVE. PROVIDE TYPEWRITTEN	SA	SINGLE POLE AIR BUTTON SWITCH FOR ALL KITCHEN SINK DISPOSALS (PLUMBER TO LOCATE ON ISLAND)		SURFACE MOUNTED FLUORESCENT FIXTURE
DIRECTORIES IN PANELS, AND WHERE OTHERWISE REQUIRED, WITH CLEAR PLASTIC PROTECTION SHEILDS AND MOUNTED IN CARD HOLDERS.	TV	CABLE TV OUTLET		SURFACE MOUNTED FLUORESCENT FIXTURE
PROPERLY GROUND ALL ELECTRICAL SYSTEMS AND EQUIPMENT IN ACCORDANCE WITH NEC REQUIREMENTS, ALL SPECIAL SYSTEMS TO BE GROUNDED PER NEC 800.100(D).	<u> </u>	120/240 VOLT RECEPTACLE- SEE		EXHAUST FAN
SMITCHES SHALL BE SPECIFICATION GRADE, MIN. 15A, #1221, 120/277V, MANUFACTURERED BY HUBBELL, BRYANT, SLATER, LEVITON OR EQUAL.		ELECTRICAL PLAN NOTES JUNDER-CABINET LIGHTING -		EXHAUST FAN - LIGHT
DUPLEX CONVENIENCE RECEPTACLES SHALL BE SPECIFICATION GRADE, MIN. 15A, 125V, 2P, 3N, GROUNDING TYPE #5362, NEMA 5-20R, MANUFACTURED BY		STANDARD (OPTIONAL LED TAPE/TRANSFORMERS).	Ø	JUNCTION BOX FOR CEILING FAN

ELECTRICAL LEGEND / LIGHT FIXTURE SCHEDULE

Panel "A"					
	СКТ	СКТ	СКТ	СКТ	
LOAD SERVED	#	BKR	BKR	#	LOAD SERVED
* MSTR BEDROOM	1 1	15	15	2	REFRIGERATOR
* BEDROOM 2	3	15	15	4	DISPOSAL
BATHROOMS	5	20	20	6	DISHWASHER
* GENERAL LTG	7	15		8	B.1110E
* KITCHEN LTG	9	15	50	10	RANGE
GARAGE REC	11	15	20	12	KITCHEN REC
EXTERIOR REC	13	20	20	14	KITCHEN REC
WATER HTR	15	15	20	16	KITCHEN REC
FURNACE	17	15	15	18	* GENERAL REC
DRYER	19	30	15	20	* SITTING RM
DRIER	21	30	40	22	CONDENSOR
WASHER	23	20	Līv	24	CONDENCOR
* 4 SEASONS RM/DEN	25	15	15	26	SMOKE DETECTORS
SPARE	27	15		28	
	29			30	
	31			32	
	33			34	
	35			36	
	37			38	
	39			40	
	41			42	
	125A	MAIN	LUG	ONLY	•
SERVICE FEEDER SIZE					SEE RISER

CARBON MONOXIDE DETECTOR

* PROVIDE ARC FAULT BREAKER

** PROVIDE BREAKER TIE FOR THESE TWO CIRCUITS

Р	anel "A" LOAD CALC	3	
LIGHTING:	LOAD SERVED		
2103 SQUARE FEET	6309	VA	
APPLIANCES:			
(2) APPLIANCE CCT	S @ 1500VA EACH	3000	VA
DISHWASHER		1200	VA
DISPOSAL		750	VA
WASHER		1500	VA
DRYER		5000	VA
RANGE		8800	VA
WATER HEATER		180	VA
REFRIGERATOR		750	VA
FURNACE	_	500	VA
	FIXED LOAD + LIGHTS	27989	VA
FIRST 10KW @ 100%		10000	VA
REMAINING KW @ 40%		7195.6	VA
	TOTAL WITHOUT HVAC	17195.6	VA
HVAC LOAD:			
AC		5914	VA
	LARGEST LOAD	5914	VA
	TOTAL DEMAND LOAD	23109.6	VA
120/240V 1PH 3W		96.3	AMPS
	UTILIZE 125AMP SERVICE		

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ENERGY REQUIREMENTS.

Prototype	Interim Page Revisions					
Disk Ňo.	Revision	Date				
		3/12/12				


Architect Project Number 2010-005

Community Dates & Revisions 1 FEB 2015 Date Originated **Permit** Construction Revisions

> Drawing Title **Electrical Plan**

Architectural Style **European Country Sheet Number**

D3 - 2010

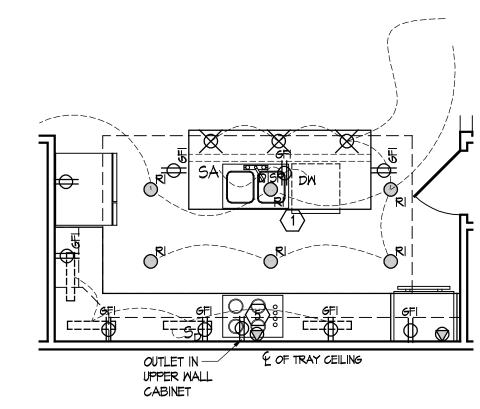


Electrical Plan - Deluxe Kitchen

Scale: 1/4" = 1'-0"

Panel "A"						
	СКТ	СКТ	СКТ	СКТ		
LOAD SERVED	#	BKR	BKR	#	LOAD SERVED	
* MSTR BEDROOM	1	15	15	2	REFRIGERATOR	
* BEDROOM 2	3	15	15	4	DISPOSAL	
BATHROOMS	5	20	20	6	DISHWASHER	
* GENERAL LTG	7	15	50	8	DOUBLE OVENS	
* KITCHEN LTG	9	15	30	10	DOUBLE OVENS	
GARAGE REC	11	15	50	12	сооктор	
EXTERIOR REC	13	20	50	14	COOKTOP	
WATER HTR	15	15	20	16	KITCHEN REC	
FURNACE	17	15	20	18	KITCHEN REC	
DDVED	19		20	20	KITCHEN REC	
DRYER	21	30	15	22	* GENERAL REC	
WASHER	23	20	15	24	* SITTING RM	
* 4 SEASONS RM/DEN	25	15	40	26	22117511227	
SPARE	27	15	40	28	CONDENSOR	
	29		15	30	SMOKE DETECTORS	
	31			32		
	33			34		
	35			36		
	37			38		
	39			40		
	41			42		
	125A	MAIN	LUG	ONLY		
ERVICE FEEDER SIZE					SEE RISER	

^{*} PROVIDE ARC FAULT BREAKER

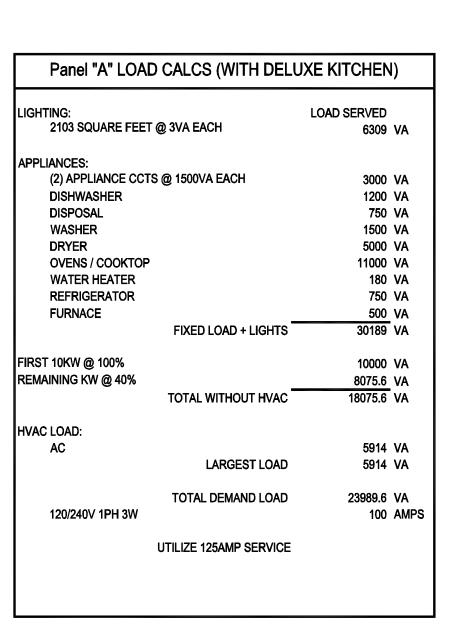

PLAN NOTES:

- PROVIDE DUPLEX RECEPTACLE LOCATED BELOW KITCHEN SINK FOR CONNECTION OF GARBAGE DISPOSAL AND DISHWASHER. ELECTRICAL CONTRACTOR SHALL PROVIDE CORD KIT FOR GARBAGE DISPOSAL AND DISHWASHER. THE TOP HALF OF THIS RECEPTACLE SHALL BE CONTROLLED IN AN AIR BUTTON SWITCH LOCATED ON ISLAND COUNTERTOP FOR OPERATION THE GARBAGE DISPOSAL (BY PLUMBER). LABEL COVER PLATE SO THAT THE TOP HALF OF THE RECEPTACLE IS LABELED FOR GARBAGE DISPOSAL CONNECTION AND THE BOTTOM HALF OF THE RECEPTACLE IS LABELED FOR DISHWASHER CONNECTION.
- VERIFY EXACT LOCATIONS OF BATHROOM EXHAUST FANS WITH MECHANICA DRAWINGS. HVAC CONTRACTOR SHALL SUPPLY AND INSTALL EXHAUST FAN AND DUCTING, WIRING BY ELECTRICAL CONTRACTOR.
- PROVIDE ELECTRICAL CONNECTION AND SAFETY SWITCH FOR FURNACE.
- 4. PROVIDE 120 VOLT SMOKE ALARM WITH 9 VOLT BATTERY BACK-UP. SMOKI ALARMS SHALL BE CONNECTED TOGETHER SO THAT WHEN ONE SMOKE ALA WITHIN A RESIDENCE SOUNDS, ALL SMOKE ALARMS WITHIN THAT RESIDENCE

VERIFY EXACT REQUIREMENTS WITH MANUFACTURERS NAMEPLATE.

 PROVIDE 120/240 VOLT RANGE RECEPTACLE. THIS RECEPTACLE MUST BE PROVIDED WITH A GROUNDED CONDUCTOR AND AN EQUIPMENT GROUNDING CONDUCTOR PER THE NATIONAL ELECTRICAL CODE.

6. PROVIDE 120/240 VOLT DRYER RECEPTACLE FOR DRYER UNIT. THIS

- RECEPTACLE MUST BE PROVIDED WITH A GROUNDED CONDUCTOR AND AN EQUIPMENT GROUNDING CONDUCTOR PER THE NATIONAL ELECTRICAL CODE. PROVIDE A DUPLEX RECEPTACLE FOR WASHER.
- PROVIDE ELECTRICAL CONNECTION AND DISCONNECT SWITCH FOR HEAT PUMP. VERIFY EXACT REQUIREMENTS WITH MANUFACTURERS NAMEPLATE.
- PROVIDE ELECTRICAL CONNECTION AND SAFETY SWITCH FOR WATER HEAT VERIFY EXACT REQUIREMENTS WITH MANUFACTURERS NAMEPLATE.
- 9. COAX/CATY HOME RUN LOCATION (75" A.F.F.).
- IO. ALL TY LOCATIONS TO RECEIVE A SINGLE GANG BOX WITH COAX/CATY CONNECTION.

GENERAL NOTES:

- A. ALL WORK SHALL MEET OR EXCEED THE MOST CURRENT EDITION OF THE NATIONAL ELECTRICAL CODE, STATE CODE(S) AND LOCAL CODE(S).

 ELECTRICAL CONTRACTOR SHALL FURNISH ALL LABOR, MATERIALS,
 APPLIANCES, EQUIPMENT, TOOLS, SUPERINTENDENCE, AND SERVICES AS
 REQUIRED TO PROVIDE ELECTRICAL WORK AS SPECIFIED OR AS INTENDED THESE DRAWINGS.
- B. ELECTRICAL CONTRACTOR SHALL VISIT THE SITE TO FAMILIARIZE THEMSELVES WITH THE SCOPE OF THE PROJECT PRIOR TO BID.
- C. ELECTRICAL CONTRACTOR MUST VERIFY THE MOUNTING HEIGHTS OF ALL DEVICES WITH ARCHITECTURAL DRAWINGS PRIOR TO ROUGH-IN. ALL SWITCHE RECEPTACLES, ETC. AND COVER PLATES SHALL BE WHITE IN COLOR.
- ELECTRICAL CONTRACTOR SHALL INSTALL ALL WIRING IN ACCORDANCE WITH THE CURRENT EDITIONS OF THE NATIONAL AND LOCAL ELECTRICAL CODES.
- E. ALL RECEPTACLES LOCATED OUTSIDE SHALL BE GFCI TYPE AND SHALL HAVE WEATHERPROOF IN-USE COVERS.
- F. IN ALL AREAS SPECIFIED IN NEC 210.52, ALL 15 AND 20 AMP, 120 VOLT RECEPTACLES SHALL BE LISTED TAMPER-RESISTANT RECEPTACLES.
- G. ELECTRICAL CONTRACTOR SHALL PROVIDE SAFETY SWITCHES FOR ALL HYAC AND PLUMBING EQUIPMENT IN ACCORDANCE WITH THE NATIONAL ELECTRICAL CODE.
- H. DEVICES INSTALLED IN FIRE SEPARATION WALLS/CEILINGS SHALL BE INSTALLED IN ACCORDANCE WITH THE LISTING AND LABELING OF THE RATED ASSEMBLY. DO NOT INSTALL OUTLET BOXES WITHIN THE SAME STUD SPACE.
- I. SMOKE ALARMS SHALL BE CONNECTED TOGETHER SO THAT WHEN ONE SMOKE ALARM WITHIN A RESIDENCE SOUNDS, ALL SMOKE ALARMS WITHIN THAT RESIDENCE SOUND. SMOKE ALARMS SHALL NOT BE INSTALELD CLOSER THAN 3' IN FRONT OF HVAC SUPPLY GRILLES.
- J. LIGHT FIXTURES INSTALLED IN CLOSETS SHALL CONFORM TO NEC ARTICLE
- K. KITCHEN COUNTERTOP RECEPTACLES AND BATHROOM RECEPTACLES SHALL BE GFCI PROTECTED VIA CLASS A GFCI TYPE CIRCUIT BREAKER. PROVIDE CLASS A GFCI CIRCUIT BREAKERS
- L. EACH TELEPHONE OUTLET LOCATION SHALL BE PROVIDED WITH (1) CATEGORY 5E CABLE. PROVIDE FACEPLATE WITH (2) RJ-45 PORTS, ROUTE CABLES TO DEMANCATION LOCATION.
- EACH CABLE TY OUTLET LOCATION SHALL BE PROVIDED WITH (I) RG6 VIDEO CABLE. PROVIDE FACEPLATE WITH (I) MALE PORT. ROUTE CABLES TO CONNECTION POINT.
- N. ALL SERVICE MAINS SHALL BE IDENTIFIED IN FIELD.
- EQUIPMENT, PANELS, SPECIAL DEVICE PLATES, AND SIMILAR MATERIAL SHALL BE CLEARLY MARKED. SIZE OF LETTERING AND WORDING SHALL BE APPROVED BY THE OWNERS REPRESENTATIVE. PROVIDE TYPEMRITTEN DIRECTORIES IN PANELS, AND WHERE OTHERWISE REQUIRED, WITH CLEAR PLASTIC PROTECTION SHEILDS AND MOUNTED IN CARD HOLDERS.
- PROPERLY GROUND ALL ELECTRICAL SYSTEMS AND EQUIPMENT IN ACCORDANCE WITH NEC REQUIREMENTS. ALL SPECIAL SYSTEMS TO BE GROUNDED PER NEC 800.100(D).
- Q. SWITCHES SHALL BE SPECIFICATION GRADE, MIN. 15A, #1221, 120/27TV, MANUFACTURERED BY HUBBELL, BRYANT, SLATER, LEVITON OR EQUAL.
- R. DUPLEX CONVENIENCE RECEPTACLES SHALL BE SPECIFICATION GRADE, MIN. 15A, 125V, 2P, 3W, GROUNDING TYPE #5362, NEMA 5-20R, MANUFACTURED BY HUBBELL, BRYANT, SLATER, LEVITON, OR EQUAL.
- 5. ELECTRICAL CONTRACTOR SHALL ROUGH-IN APPROPRIATE WIRING, ETC. TO RETROFIT THIS HOME WITH SMOKE DETECTORS WITH HORN AND STROBE, TTY TELEPHONES, AND DOORBELL WITH CHIME AND FLASHING LIGHT.
- THE ANNULAR SPACE AROUND ALL PENETRATIONS IN GYPSUM BOARDS, INCLUDING MIRING AND ELECTRICAL BOXES, SHALL BE SEALED TIGHT.
- ALL LIGHTING FIXTURES SHALL BE SUPPLIED BY THE OWNER AND INSTALLED BY THE ELECTRICAL CONTRACTOR.
- ALL BEDROOM OUTLETS TO HAVE "COMBINATION-TYPE" ARC FAULT INTERRUPTING CIRCUITS.
- W. A MINIMUM OF 50% OF THE LAMPS IN PERMANENTLY INSTALLED LIGHTING FIXTURES SHALL BE HIGH EFFICACY LAMPS.
- . A CARBON MONOXIDE DETECTOR SHALL BE PLACED OUTSIDE EACH SLEEPING AREA, IN THE IMMEDIATE VICINITY OF THE BEDROOMS.

	ELECTRICAL LEGE	ND / LIGI	HT FIXTURE SCHEDULE
Ф	DUPLEX RECEPTACLE OUTLET	•	DOOR PUSH BUTTON
#	QUADRUPLEX RECEPTACLE OUTLET	<u></u>	DIRECT WIRE APPLIANCE
$\phi_{\rm GFI}$	DUPLEX RECEPTACLE OUTLET WITH GROUND FAULT INTERRUPTER (GFI)		RECESSED MINI INCANDESCENT DOWN LIGHT FIXTURE
Ø _{MP}	DUPLEX RECEPTACLE OUTLET WITH	Os	SHOWER LIGHT
пМЬ	WATERPROOF COVER & GFI	\bigcirc_{RI}	RECESSED INCANDESCENT DOWN LIGHT FIXTURE
ф	DUPLEX RECEPTACLE OUTLET - SWITCH TOP OUTLET	O _{R2}	RECESSED INCANDESCENT EXTERIOR DOWN LIGHT FIXTURE
ф	DUPLEX RECEPTACLE OUTLET- SPECIAL	O _{sc}	RECESSED INCANDESCENT FIXTURE (SLOPED CEILING
\triangle	TELEPHONE OUTLET (CATEGORY 5 WIRE TO ALL PHONE LOCATIONS)	Φ	RECESSED INCANDESCENT EYEBALL FIXTURE
\triangle	DATA COMMUNICATIONS OUTLET	X	SURFACE MOUNTED INCANDESCENT FIXTURE - CLOSETS
\oslash	SMOKE DETECTOR	ЖH	SURFACE MOUNTED INCANDESCENT FIXTURE - HALLWAYS
5	SINGLE POLE SMITCH	+	EXTERIOR INCANDESCENT WALL BRACKET FIXTURE
s ₃	THREE-WAY SWITCH	+	INTERIOR INCANDESCENT WALL SCONCE
s ₄	FOUR-WAY SMITCH	Дв	KEYLESS PORCELAIN LAMP HOLDER
SD	DIMMER SWITCH	\bowtie	PENDANT FIXTURE - OPTIONAL
s R	REMOTE SMITCH FOR LIGHT & 3-SPEED FAN CONTROL	X	CHANDELIER FIXTURE
SA	SINGLE POLE AIR BUTTON SMITCH FOR ALL KITCHEN SINK DISPOSALS (PLUMBER TO LOCATE ON ISLAND)		SURFACE MOUNTED FLUORESCENT FIXTURE
TV	CABLE TV OUTLET		SURFACE MOUNTED FLUORESCENT FIXTURE
<u> </u>	120/240 VOLT RECEPTACLE- SEE		EXHAUST FAN
-	ELECTRICAL PLAN NOTES		EXHAUST FAN - LIGHT

PLAN NOTES:

IIIIIUNDER-CABINET LIGHTING -

DOOR CHIME

STANDARD (OPTIONAL LED


TAPE/TRANSFORMERS).

PROVIDE #6 CU TO GROUND ROD.
 SERVICE PROVIDED BY UTILITY COMPANY. EC SHALL CONFIRM REQUIREMENTS WITH UTILITY

JUNCTION BOX FOR CEILING FAN

CARBON MONOXIDE DETECTOR

COMPANY PRIOR TO BID. 3. 125A FUSIBLE DISCONNECT. BUILDING STEEL

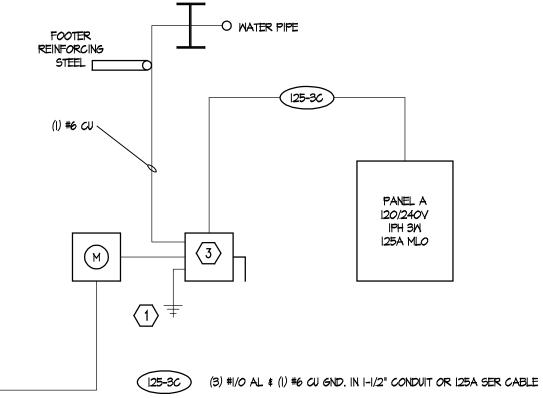

Electrical Riser Diagram

Scale: NTS

EPCON

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Villas at Park Place
By Park Place West Chester, LL(

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LOCAL BUILDING, MECHANICAL, PLUMBING AND ELECTRICAL
CODES AND SHALL MEET THE REQUIREMENTS OF THE HEALTH
DEPARTMENT, FIRE MARSHALL, AMERICANS WITH DISABILITIES
ACT ACCESSIBILITY GUIDELINES (ADAAG), THE FAIR HOUSING
ACT ACCESSIBILITY GUIDELINES (FHAAG), AND SHALL BE
CONSTRUCTED IN CONFORMANCE WITH STATE AND LOCAL

ENERGY REQUIREMENTS.

Prototype	Interim Page Revisions					
Disk No.	Revision	Date				
		2/17/12				

Architect Project Number 2010-005

Community Dates & Revisions
Date Originated 1 FEB 2015
Bid
Permit
Construction
Revisions

\(\triangle \tr

Drawing Title

Electrical Plan

Deluxe Kitchen

Architectural Style
European Country

Sheet Number **E.101**D3 - 2010

^{**} PROVIDE BREAKER TIE FOR THESE TWO CIRCUITS