
S2 399 6891 RIVERVIEW AVENUE MIDDLETOWN, OH 45042


2 Story Basement
2 hose bibs - no valves required
Vent Kitchen
ice maker
1 tub
1 shower
WATER HEATER ELECTRIC 50 GALLON
Inside Water Meter setup


Gas Furnace and Range

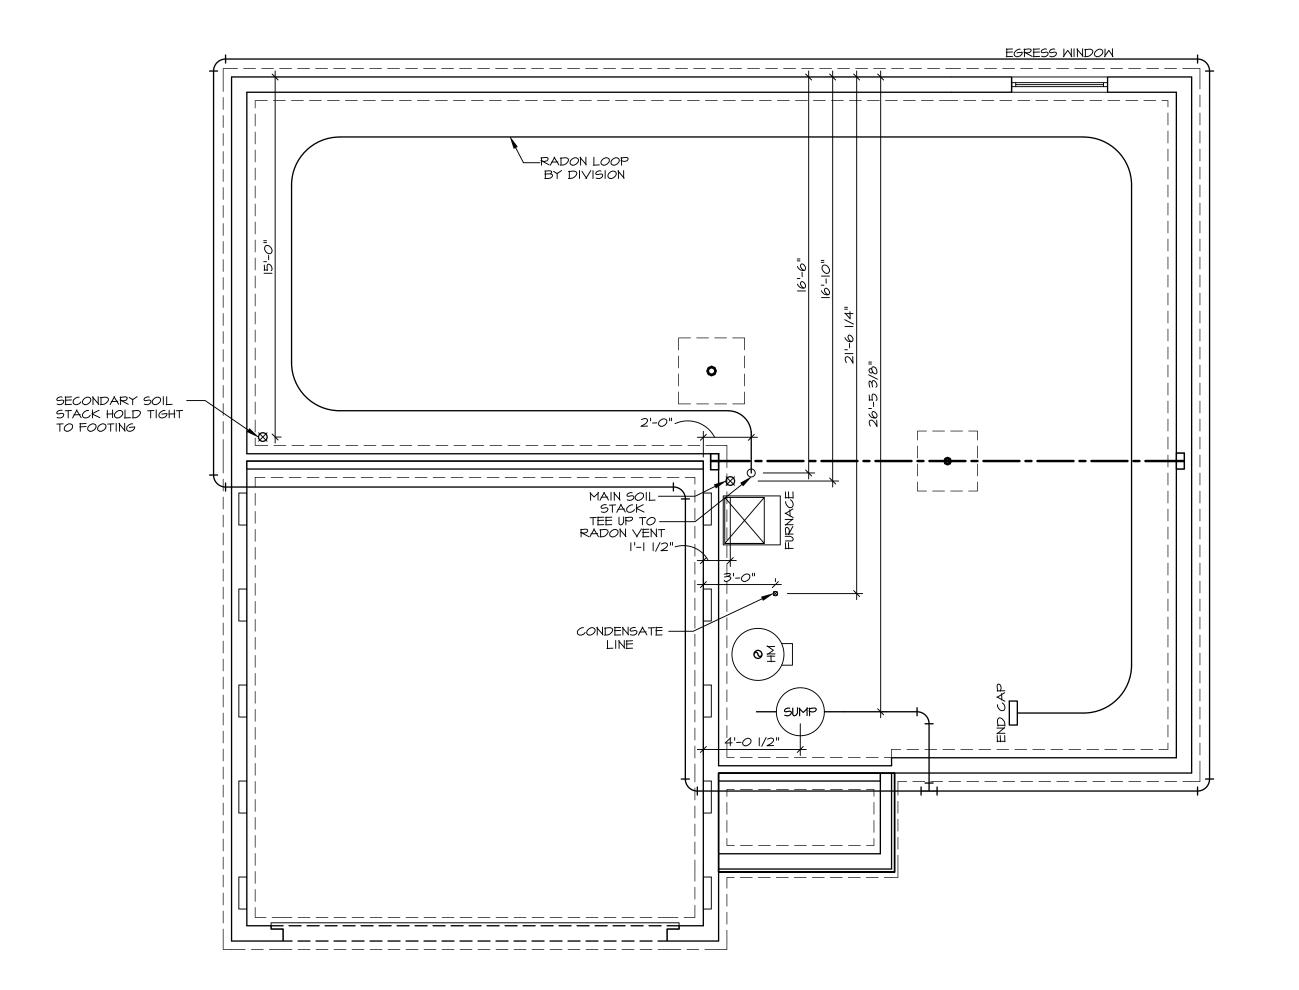



PLUMBING PLAN

A-5 SCALE: 1/4" = 1'-0"

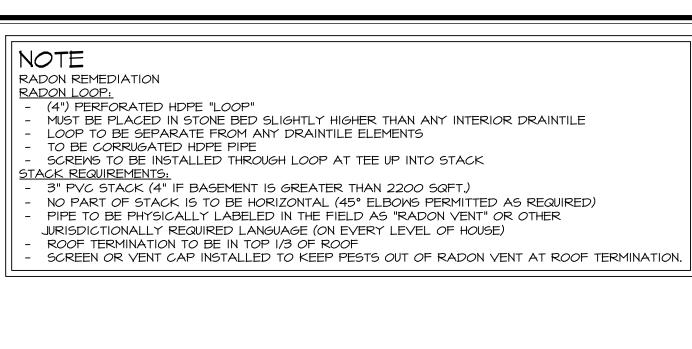

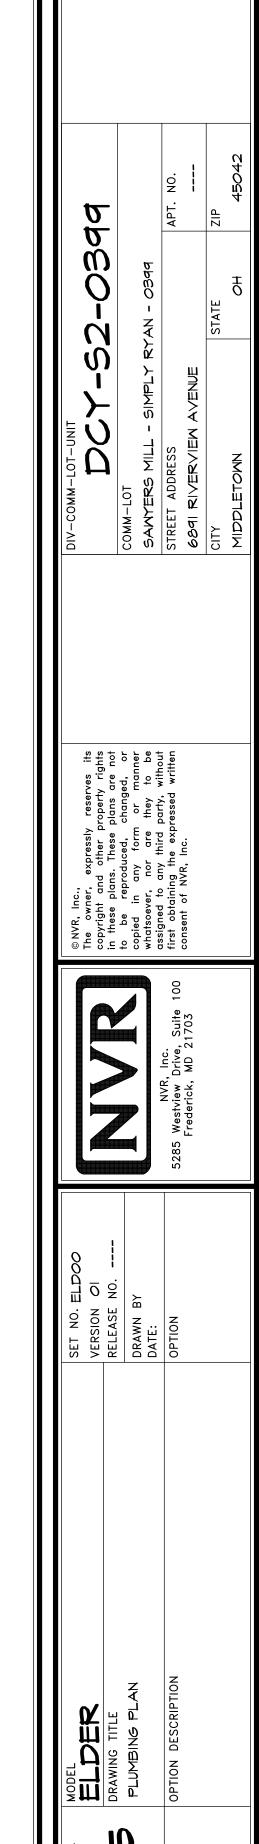

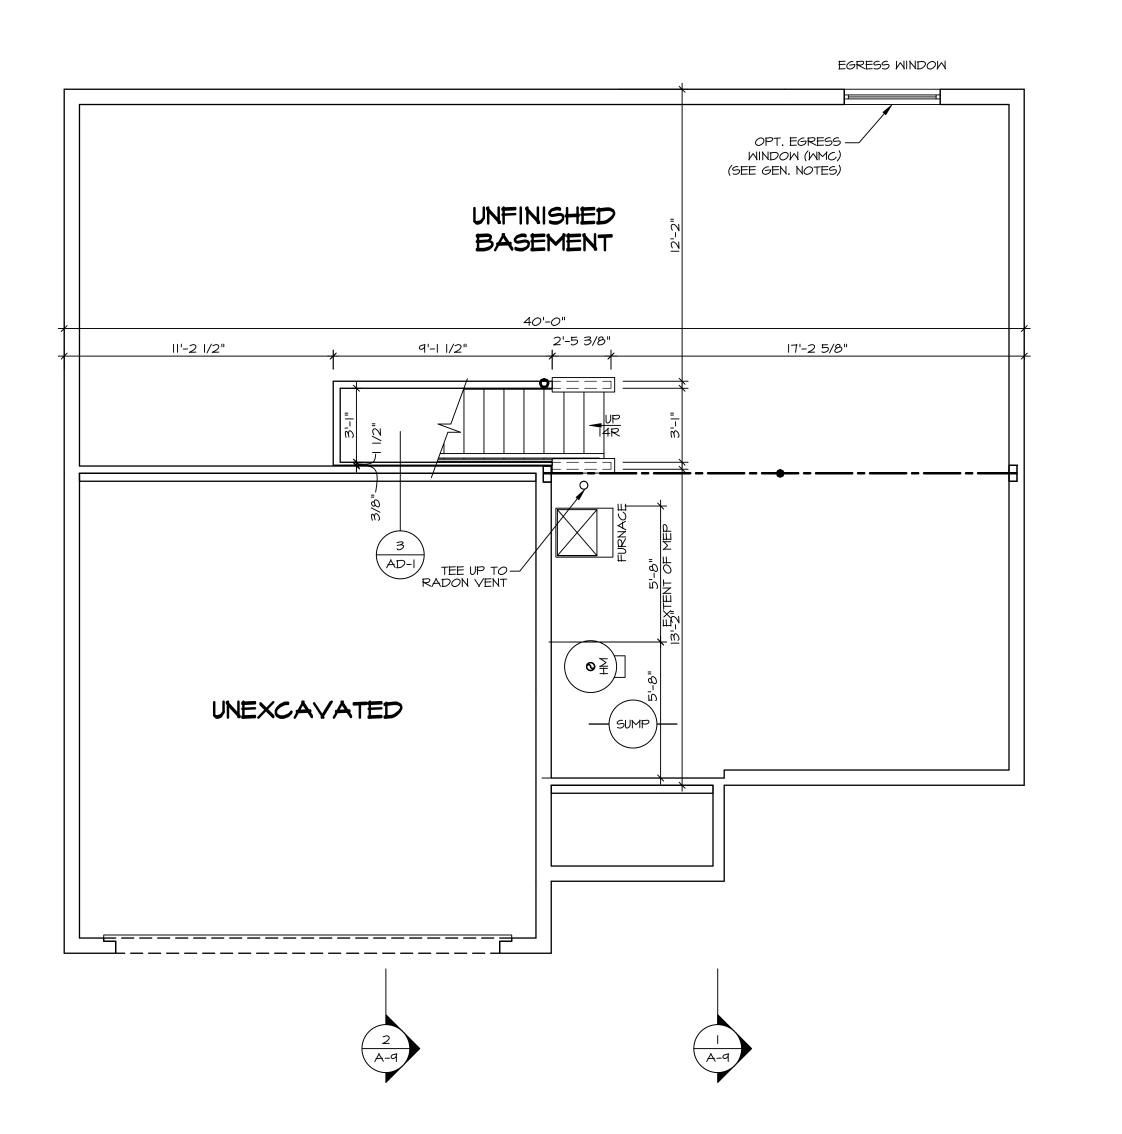

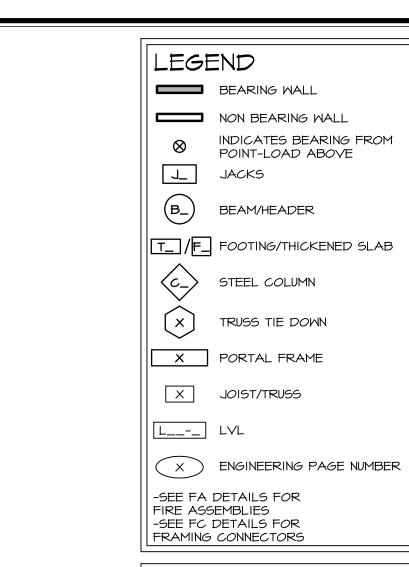

ALL WINDOWS HAVE 8'-0 1/2" HEADER HEIGHT UNLESS OTHERWISE NOTED

FLOOR PLAN NOTES

- ALL HEADERS ARE (2) 2x6 w/ 2x4 WALLS OR (3) 2x6 w/ 2x6 WALLS, UNLESS OTHERWISE NOTED.
 ALL HEADERS TO HAVE (I) 2x4 OR 2x6 JACK AND KING STUD EACH END, UNLESS OTHERWISE NOTED.
 MULTI-OPENING HEADERS TO HAVE (2) JACKS AT
- INTERMEDIATE BEARING, UNLESS OTHERWISE NOTED. NO ADDITIONAL FLOOR SYSTEM BLOCKING OR CONTINUOUS LOAD PATH JACKS ARE REQUIRED UNLESS OTHERWISE NOTED.

 3. ALL EXTERIOR WALLS TO BE 4" W/ OSB OR 3 1/2" W/ LAMINATED FIBROUS STRUCTURAL SHEATHING, ALL
- INTERIOR WALLS TO BE 3 1/2", UNLESS OTHERWISE NOTED.

 4. HATCHED AREAS INDICATE DROPPED CEILINGS. ALL DROPPED CEILINGS ARE 12" UNLESS OTHERWISE NOTED.

 5. SEE "BRACED WALL PANEL DETAIL SHEET" FOR SPECIAL WALL FRAMING LOCATIONS AND HEADER SIZES, IF APPLICABLE.
- APPLICABLE.

 6. SEE STANDARD DETAIL CATEGORY "IT" SHEET(S) FOR INTERIOR TRIM DETAILS.

 7. SEE ARCHITECTURAL DETAIL SHEET "AD" FOR HOUSE
- SPECIFIC INTERIOR TRIM OPTION TABLE.

 8. ALL HEADERS IN NON-BEARING WALLS SHALL BE A SINGLE FLAT 2X4 OR 2X6 ATTACHED TO CRIPPLES ABOVE, UNLESS OTHERWISE NOTED.
- 9. TANKED WATER HEATER SHOWN AS BASE CONDITION,
 OPTIONAL TANKLESS WATER HEATER IS AVAILABLE IN
 LIEU OF TANKED WATER HEATER.

 10. INTERIOR HEADER HEIGHT TO BE 6'-II" W/ 8'-O" CEILINGS
- AND 7'-II" W/ 9'-O" CEILINGS UNLESS OTHERWISE NOTED.

 II. BASEMENT FINISH DIMENSIONS ASSUME A I/2" GAP
 BETWEEN FRAME WALL AND CONCRETE WALL.

GYPSUM NOTES

AT GARAGE:

GYPSUM BOARD AT COMMON WALLS, CEILINGS, BEAM WRAPS AND SUPPORTS PER STANDARD DETAIL FA-I(b) FIRE ASSEMBLIES OR AS REQUIRED BY LOCAL CODE.


AT STAIRS:

1/2" GYPSUM BOARD AT UNDERSIDE OF STAIRS AND WALLS IN CLOSET ---
NVR, Inc.

5285 Westview Drive, Suite 100
Frederick, MD 21703

VERSION OI
RELEASE NO. ---DRAWN BY
DATE:
OPTION

LDER
WING TITLE
ASEMENT FLOOR PLAN

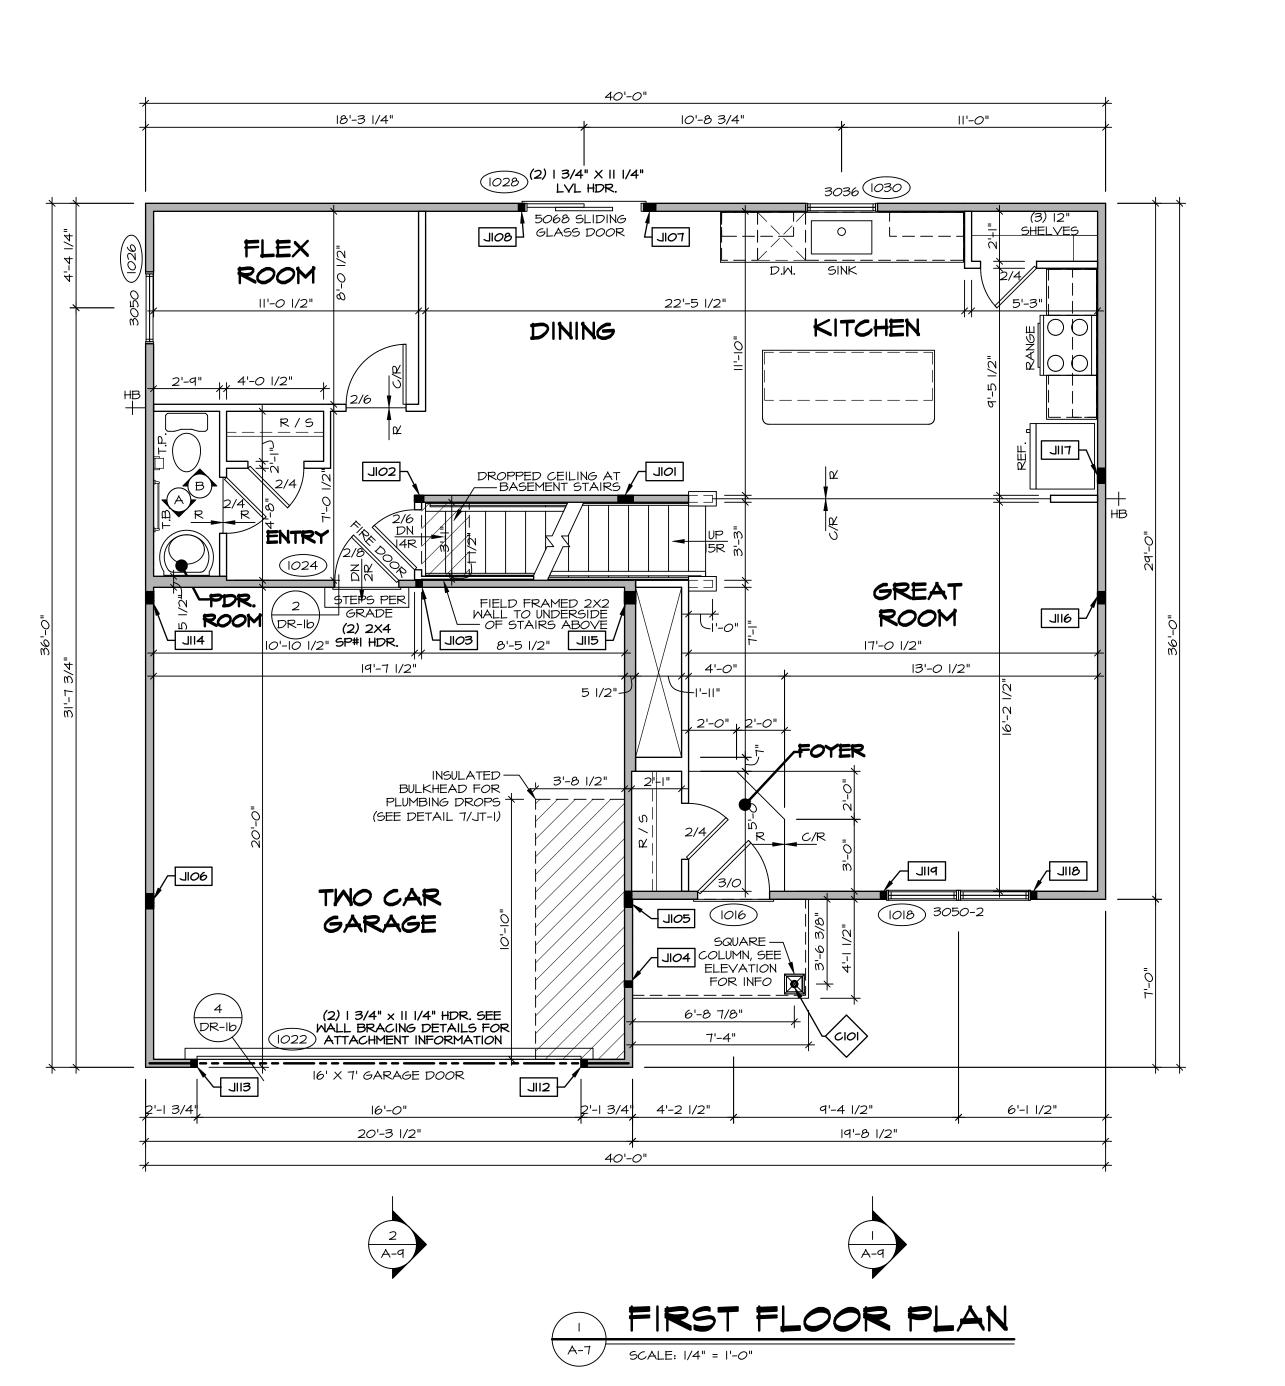

LVL PLY TO PLY FASTENING SCHEDULE: (WHERE APPLICABLE BASED ON LVL USAGE) I.A - (2) PLY UP TO AND INCLUDING II 7/8" TALL: FASTEN PLIES W/ (2) ROWS 16D NAILS AT 12" O.C. OR

ALT I 1/2" WIDE LVL FASTEN PLIES W/ (3) ROWS 12D NAILS AT 12"O.C. 2.A - (2) PLY I4" TO AND I8" TALL (INCLUSIVE): FASTEN PLIES W/ (3) ROWS I6D NAILS AT I2" O.C. OR ALT I I/2" WIDE LVL FASTEN PLIES W/ (4) ROWS I2D NAILS AT I2"O.C.

3.A - (2) PLY 20" TALL AND OVER: FASTEN PLIES W/ (4) ROWS 16D NAILS AT 12" O.C. OR ALT I 1/2" WIDE LVL FASTEN PLIES W/ (5) ROWS 12D NAILS AT 12"O.C. 4.A - (3) PLY UP TO AND INCLUDING II 7/8" TALL: FASTEN PLIES W/ (2) ROWS I6D NAILS AT I2" O.C.

FROM EACH SIDE OR ALT I 1/2" WIDE LVL FASTEN PLIES W/ (3) ROWS 12D NAILS AT 12"O.C. FROM 5.A - (3) PLY 14" TO AND 18" TALL (INCLUSIVE): FASTEN PLIES W/ (3) ROWS 16D NAILS AT 12" O.C. FROM

EACH SIDE OR ALT I 1/2" WIDE LVL FASTEN PLIES W/ (4) ROWS 12D NAILS AT 12"O.C. FROM EACH 6.A - (3) PLY 20" TALL AND OVER: FASTEN PLIES W/ (4) ROWS 16D NAILS AT 12" O.C. FROM EACH SIDE OR ALT I I/2" WIDE LVL FASTEN PLIES W/ (5) ROWS I2D NAILS AT I2"O.C. FROM EACH SIDE. 7.A - (4) PLY (ALL SIZES): FASTEN PLIES W/ (2) ROWS I/2" DIAMETER A307 BOLTS AT 24" O.C. SEE SHOP DRAWING FOR ADDITIONAL INFORMATION.

LEGEND BEARING WALL NON BEARING WALL INDICATES BEARING FROM POINT-LOAD ABOVE J_ JACKS BEAM/HEADER T_ /F_ FOOTING/THICKENED SLAB

STEEL COLUMN TRUSS TIE DOWN

X PORTAL FRAME X JOIST/TRUSS

L__-_ LVL X ENGINEERING PAGE NUMBER

-SEE FA DETAILS FOR FIRE ASSEMBLIES -SEE FC DETAILS FOR FRAMING CONNECTORS

ALL WINDOWS HAVE 7'-0 1/2" HEADER HEIGHT UNLESS OTHERWISE NOTED

FLOOR PLAN NOTES

ALL HEADERS ARE (2) 2x6 W/ 2x4 WALLS OR (3) 2x6 W/ 2x6 WALLS, UNLESS OTHERWISE NOTED.

2. ALL HEADERS TO HAVE (1) 2x4 OR 2x6 JACK AND KING STUD EACH END, UNLESS OTHERWISE NOTED. MULTI-OPENING HEADERS TO HAVE (2) JACKS AT INTERMEDIATE BEARING, UNLESS OTHERWISE NOTED. NO ADDITIONAL FLOOR SYSTEM BLOCKING OR CONTINUOUS

3. ALL EXTERIOR WALLS TO BE 4" W/ OSB OR 3 1/2"
W/ LAMINATED FIBROUS STRUCTURAL SHEATHING, ALL INTERIOR WALLS TO BE 3 1/2", UNLESS OTHERWISE NOTED. . HATCHED AREAS INDICATE DROPPED CEILINGS. ALL DROPPED CEILINGS ARE 12" UNLESS OTHERWISE NOTED. SEE ARCHITECTURAL DETAIL 8/IT-IB FOR 3/4" FIRE

STOPPING AT BULKHEAD / CEILING PANELS SEE "BRACED WALL PANEL DETAIL SHEET" FOR SPECIAL WALL FRAMING LOCATIONS AND HEADER SIZES, IF APPLICABLE. SEE STANDARD DETAIL CATEGORY "IT" SHEET(S) FOR

INTERIOR TRIM DETAILS. . SEE ARCHITECTURAL DETAIL SHEET "AD" FOR HOUSE SPECIFIC INTERIOR TRIM OPTION TABLE. ALL HEADERS IN NON-BEARING WALLS SHALL BE A SINGLE FLAT 2X4 OR 2X6 ATTACHED TO CRIPPLES ABOVE, UNLESS OTHERWISE NOTED.

OPTIONAL TANKLESS WATER HEATER IS AVAILABLE IN LIEU OF TANKED WATER HEATER. D. INTERIOR HEADER HEIGHT TO BE 6'-II" W/ 8'-0" CEILINGS AND 7'-II" W/ 9'-0" CEILINGS UNLESS OTHERWISE NOTED. BASEMENT FINISH DIMENSIONS ASSUME A 1/2" GAP

BETWEEN FRAME WALL AND CONCRETE WALL. 2. ALL INTERIOR BEARING WALLS SHALL HAVE GYPSUM APPLIED TO AT LEAST ONE SIDE OR HAVE MID-HEIGHT

GYPSUM NOTES

BLOCKING INSTALLED.

AT GARAGE:

GYPSUM BOARD AT COMMON WALLS, CEILINGS, BEAM WRAPS AND SUPPORTS PER STANDARD DETAIL FA-I(b) FIRE ASSEMBLIES OR AS REQUIRED BY LOCAL CODE.


AT STAIRS:


I/2" GYPSUM BOARD AT UNDERSIDE OF STAIRS AND WALLS IN CLOSET

FIRST FLOOR JACK SCHEDULE				
DENTIFIER	DESCRIPTION	ENG. NUM.	REMARKS	
IOIL	JACK - (5) 2X4 SPF STUD GRADE	1008, 1012		
JI02	JACK - (3) 2X4 SPF STUD GRADE	1006		
SOIL	JACK - (2) 2X4 SPF STUD GRADE	1006		
JIO4	JACK - (2) 2X4 SPF STUD GRADE	1020		
JI05	JACK - (5) 2X4 SPF STUD GRADE	2006		
JI06	JACK - (5) 2X4 SPF STUD GRADE	2006		
TOIL	JACK - (4) 2X4 SPF STUD GRADE	1028		
80IL	JACK - (2) 2X4 SPF STUD GRADE	1028		
JII2	JACK - (2) 2X4 SPF STUD GRADE	1022		
E Œ	JACK - (2) 2X4 SPF STUD GRADE	1022		
JII4	JACK - (4) 2X4 SPF STUD GRADE	1010		
JII5	JACK - (4) 2X6 SPF STUD GRADE	1010		
JII6	JACK - (4) 2X4 SPF STUD GRADE	1010		
JIL	JACK - (5) 2X4 SPF STUD GRADE	1010		
BIIL	JACK - (2) 2X4 SPF STUD GRADE	1018		
PIIL	JACK - (2) 2X4 SPF STUD GRADE	1018		

	STEEL COLUMN SCHEDULE			
IDENTIFIER	STYLE	HEIGHT	ENG. NUM.	REMARKS
CIOI	STANCHION PORCH - 3 IN DIA IIGA ADJ	7'-10 5/8"	1020	FBA, FCA

LOAD PATH JACKS ARE REQUIRED UNLESS OTHERWISE TANKED WATER HEATER SHOWN AS BASE CONDITION,

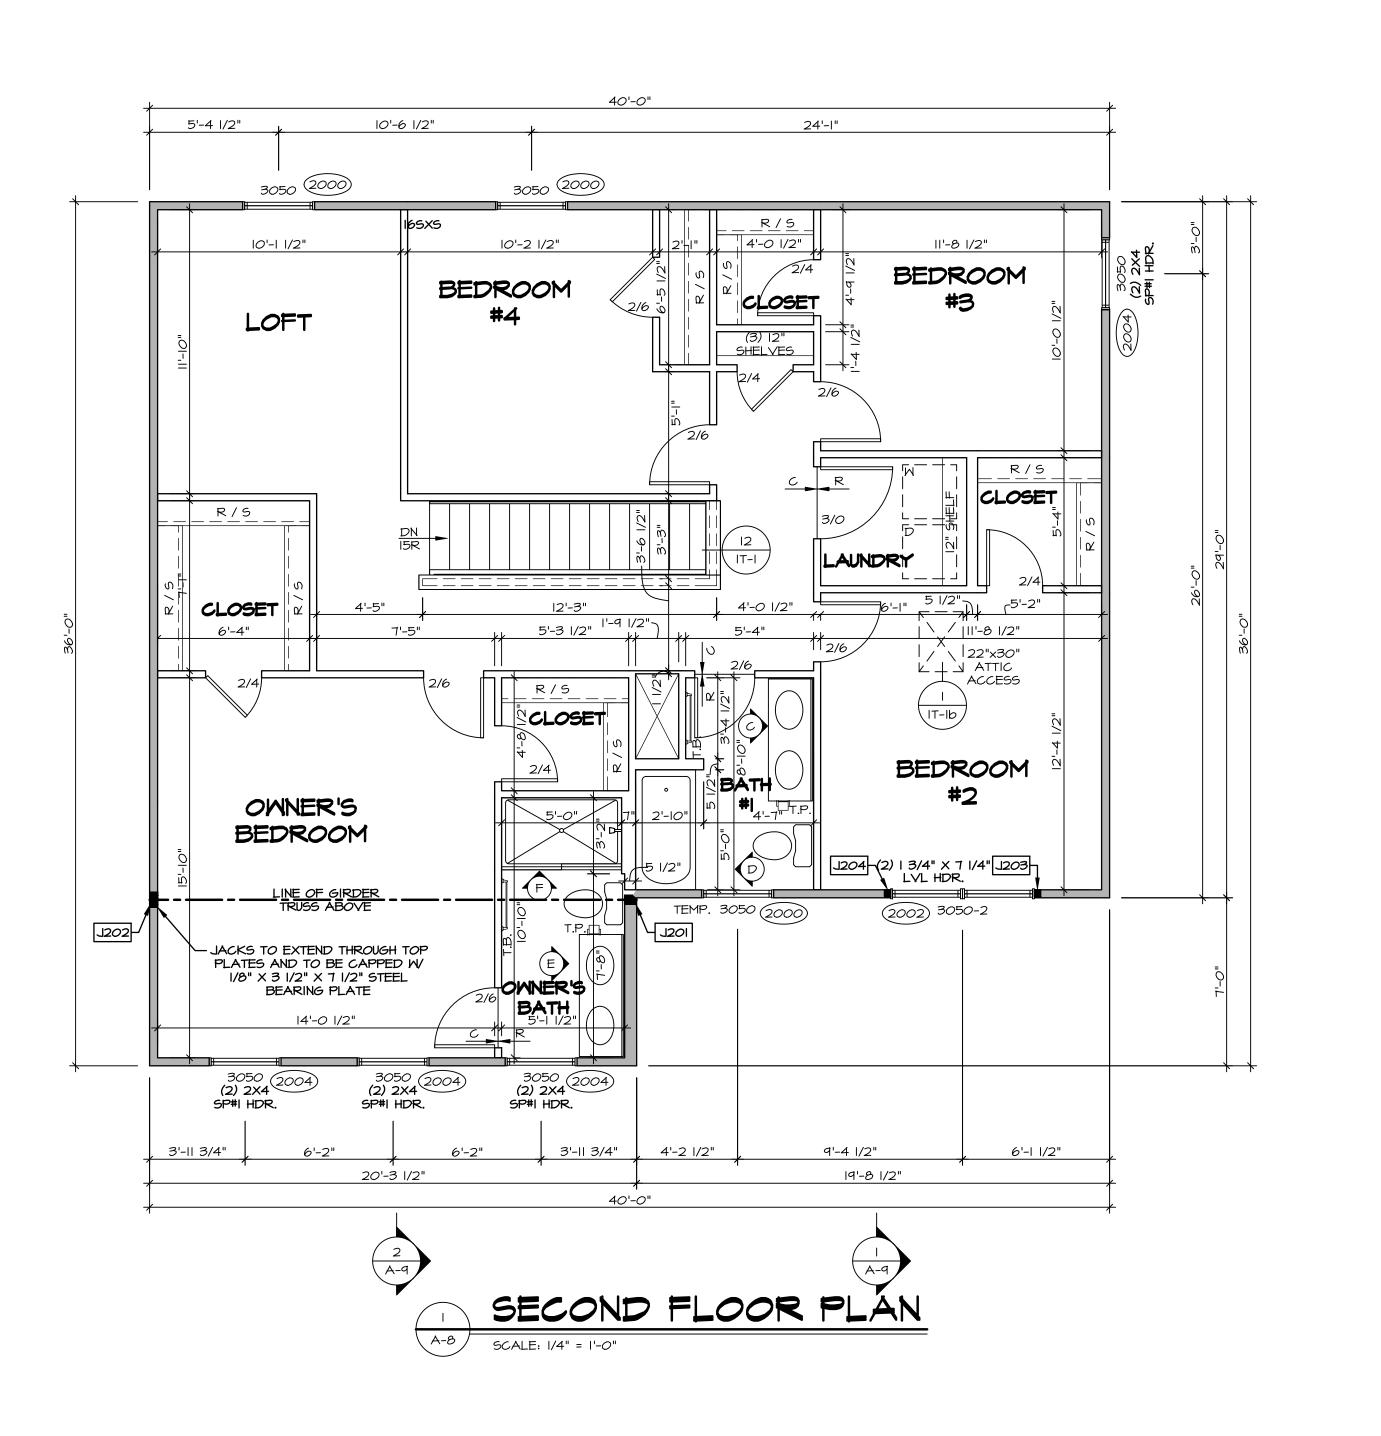

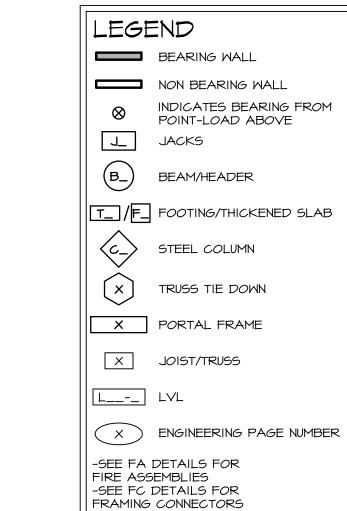

ALL WINDOWS HAVE 7'-4 5/8" HEADER HEIGHT UNLESS OTHERWISE NOTED

FLOOR PLAN NOTES

- ALL HEADERS ARE (2) 2x6 w/ 2x4 WALLS OR (3) 2x6 w/ 2x6 WALLS, UNLESS OTHERWISE NOTED. ALL HEADERS TO HAVE (1) 2x4 OR 2x6 JACK AND KING STUD EACH END, UNLESS OTHERWISE NOTED. MULTI-OPENING HEADERS TO HAVE (2) JACKS AT INTERMEDIATE BEARING, UNLESS OTHERWISE NOTED. NO ADDITIONAL FLOOR SYSTEM BLOCKING OR CONTINUOUS LOAD PATH JACKS ARE REQUIRED UNLESS OTHERWISE NOTED.
- ALL EXTERIOR WALLS TO BE 4" w/ OSB OR 3 1/2" W/ LAMINATED FIBROUS STRUCTURAL SHEATHING, ALL INTERIOR WALLS TO BE 3 1/2", UNLESS OTHERWISE NOTED. HATCHED AREAS INDICATE DROPPED CEILINGS. ALL DROPPED CEILINGS ARE 12" UNLESS OTHERWISE NOTED. SEE ARCHITECTURAL DETAIL 8/IT-IB FOR 3/4" FIRE STOPPING AT BULKHEAD / CEILING PANELS SEE "BRACED WALL PANEL DETAIL SHEET" FOR SPECIAL WALL FRAMING LOCATIONS AND HEADER SIZES, IF APPLICABLE. SEE STANDARD DETAIL CATEGORY "IT" SHEET(S) FOR
- INTERIOR TRIM DETAILS. SEE ARCHITECTURAL DETAIL SHEET "AD" FOR HOUSE SPECIFIC INTERIOR TRIM OPTION TABLE. . ALL HEADERS IN NON-BEARING WALLS SHALL BE A SINGLE FLAT 2X4 OR 2X6 ATTACHED TO CRIPPLES
- ABOVE, UNLESS OTHERWISE NOTED. TANKED WATER HEATER SHOWN AS BASE CONDITION, OPTIONAL TANKLESS WATER HEATER IS AVAILABLE IN LIEU OF TANKED WATER HEATER.
- O. INTERIOR HEADER HEIGHT TO BE 6'-II" W/ 8'-0" CEILINGS AND 7'-II" W/ 9'-0" CEILINGS UNLESS OTHERWISE NOTED. BASEMENT FINISH DIMENSIONS ASSUME A 1/2" GAP BETWEEN FRAME WALL AND CONCRETE WALL.
- 2. ALL INTERIOR BEARING WALLS SHALL HAVE GYPSUM APPLIED TO AT LEAST ONE SIDE OR HAVE MID-HEIGHT BLOCKING INSTALLED.

GYPSUM NOTES


AT GARAGE:


GYPSUM BOARD AT COMMON WALLS, CEILINGS, BEAM WRAPS AND SUPPORTS PER STANDARD DETAIL FA-I(b) FIRE ASSEMBLIES OR AS REQUIRED BY LOCAL CODE.

AT STAIRS:


1/2" GYPSUM BOARD AT UNDERSIDE OF STAIRS AND WALLS


SECOND FLOOR JACK SCHEDULE			
NTIFIER	DESCRIPTION	ENG. NUM.	REMARKS
J20I	JACK - (3) 2X6 SPF STUD GRADE	2006	
J202	JACK - (5) 2X4 SPF STUD GRADE	2006	
J203	JACK - (2) 2X4 SPF STUD GRADE	2002	
J204	JACK - (2) 2X4 SPF STUD GRADE	2002	

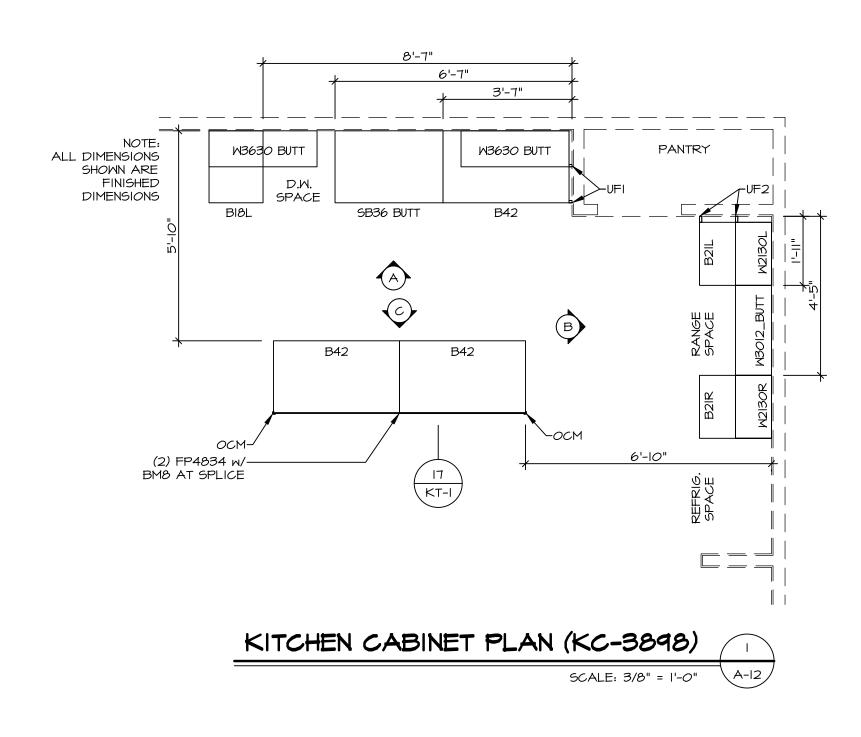

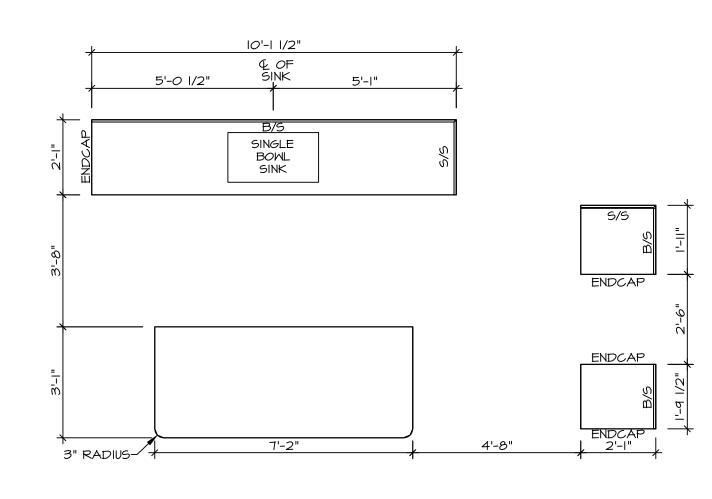


KITCHEN COUNTERTOP PLAN (KT-3898) SCALE: 3/8" = 1'-0" A-12

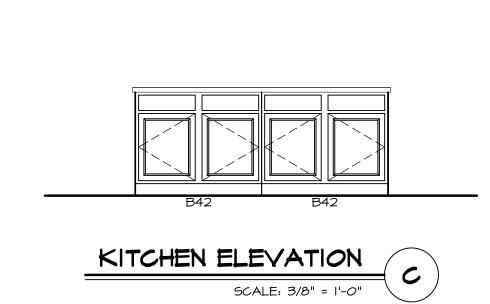

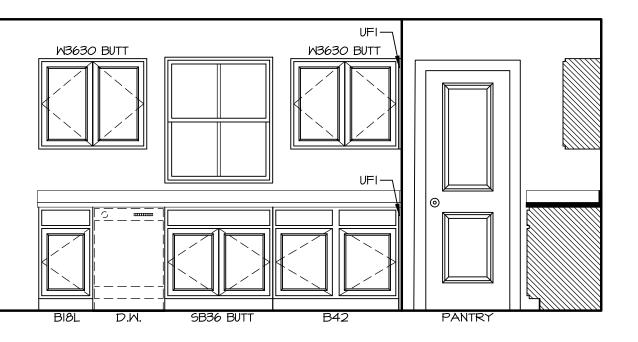



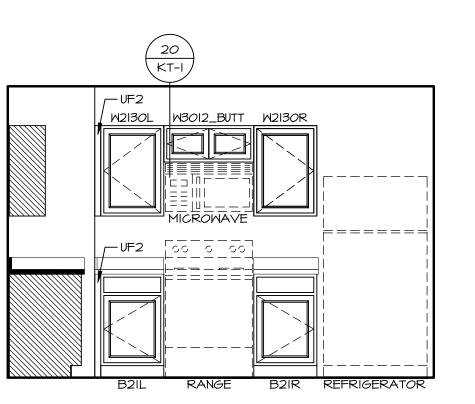

KITCHEN	ELEVATION	
	SCALE: 3/8" = 1'-0"	

I. CABINET LAYOUT (S) ARE BASED ON FINISHED DIMENSIONS TO DRYWALL.

2. IF KITCHEN PLANS/ELEVATIONS CALL-OUT STANDARD MOLDING, REFER TO STANDARD DETAIL (II/KT-I) FOR REPLACEMENT BASED ON CABINET STYLE.

3. ALL (UF#) FILLERS ARE TO BE "TRIM TO FIT" UNLESS OTHERWISE NOTED.

4. CABINET MUST BE SET, SHIMMED, LEVELED AND PLUMB W ADJOINING BASE CABINETS.


5. SET PRE-FINISHED SCRIBE MOLDING AT CABINET BULKHEADS AND AT ENDS (WHERE CABINETS MEET DRYWALL.) PRE-FINISHED SCRIBE MOLDING SHALL BE USED TO PAD OUT CABINET SIDES AT STILE FOR RETURN PIECES OF THE FACE-MOUNTED CABINET CROWN MOLDING.


6. HARDWARE INSTALL NOTE: KNOBS GO ON OPERABLE DOORS AND DRAWERS FOR ALL KITCHEN AND BATH AREAS. DRAWER FRONTS AND DOORS GET (I) KNOB/PULL. NO HARDWARE ON FALSE DRAWER FRONTS. REFER TO STANDARD DETAIL 5/KT-Ib


NOTES:

CABINETS ARE NOT REPRESENTATIVE OF ALL STYLES AND ARE MEANT AS A GENERAL DEPICTION
OF THE INTENDED CABINET LAYOUT

DCY-52-0399	Y RYAN - 0399	APT. NO	STATE ZIP OH 45C	
DIV-COMM-LOT-UNIT	COMM-LOT SAWYERS MILL - SIMPLY RYAN - 0399	STREET ADDRESS 6891 RIVERVIEW AVENUE	CITY MIDDLETOWN	
ves its rights are not	ad, or manner to be without	written		
© NVR, Inc., The owner, expressly reserves copyright and other property r in these plans. These plans are	to be reproduced, changed, or copied in any form or manner whatsoever, nor are they to be	first obtaining the expressed consent of NVR, Inc.		
		NVR, Inc. 5285 Westview Drive, Suite 100 Frederick, MD 21703		/24/24 = 8:01 am
SET NO. ELDOO VERSION OI RELEASE NO	DRAWN BY	OPTION		Solves\FIDER FIDDO 01\DCY-S2-0399\3157283\Sheets\Iot Specific\A-12 KIT IS dwg 07/24/24 - 8:01 am
	VATIONS			S2-0399\ 3157283\ Sheets\ ot
MODEL ELDER DRAWING TITLE	KITCHEN PLANS & ELEVATIONS	OPTION DESCRIPTION		ves/ FLDFR FLD00 01\ DCY-

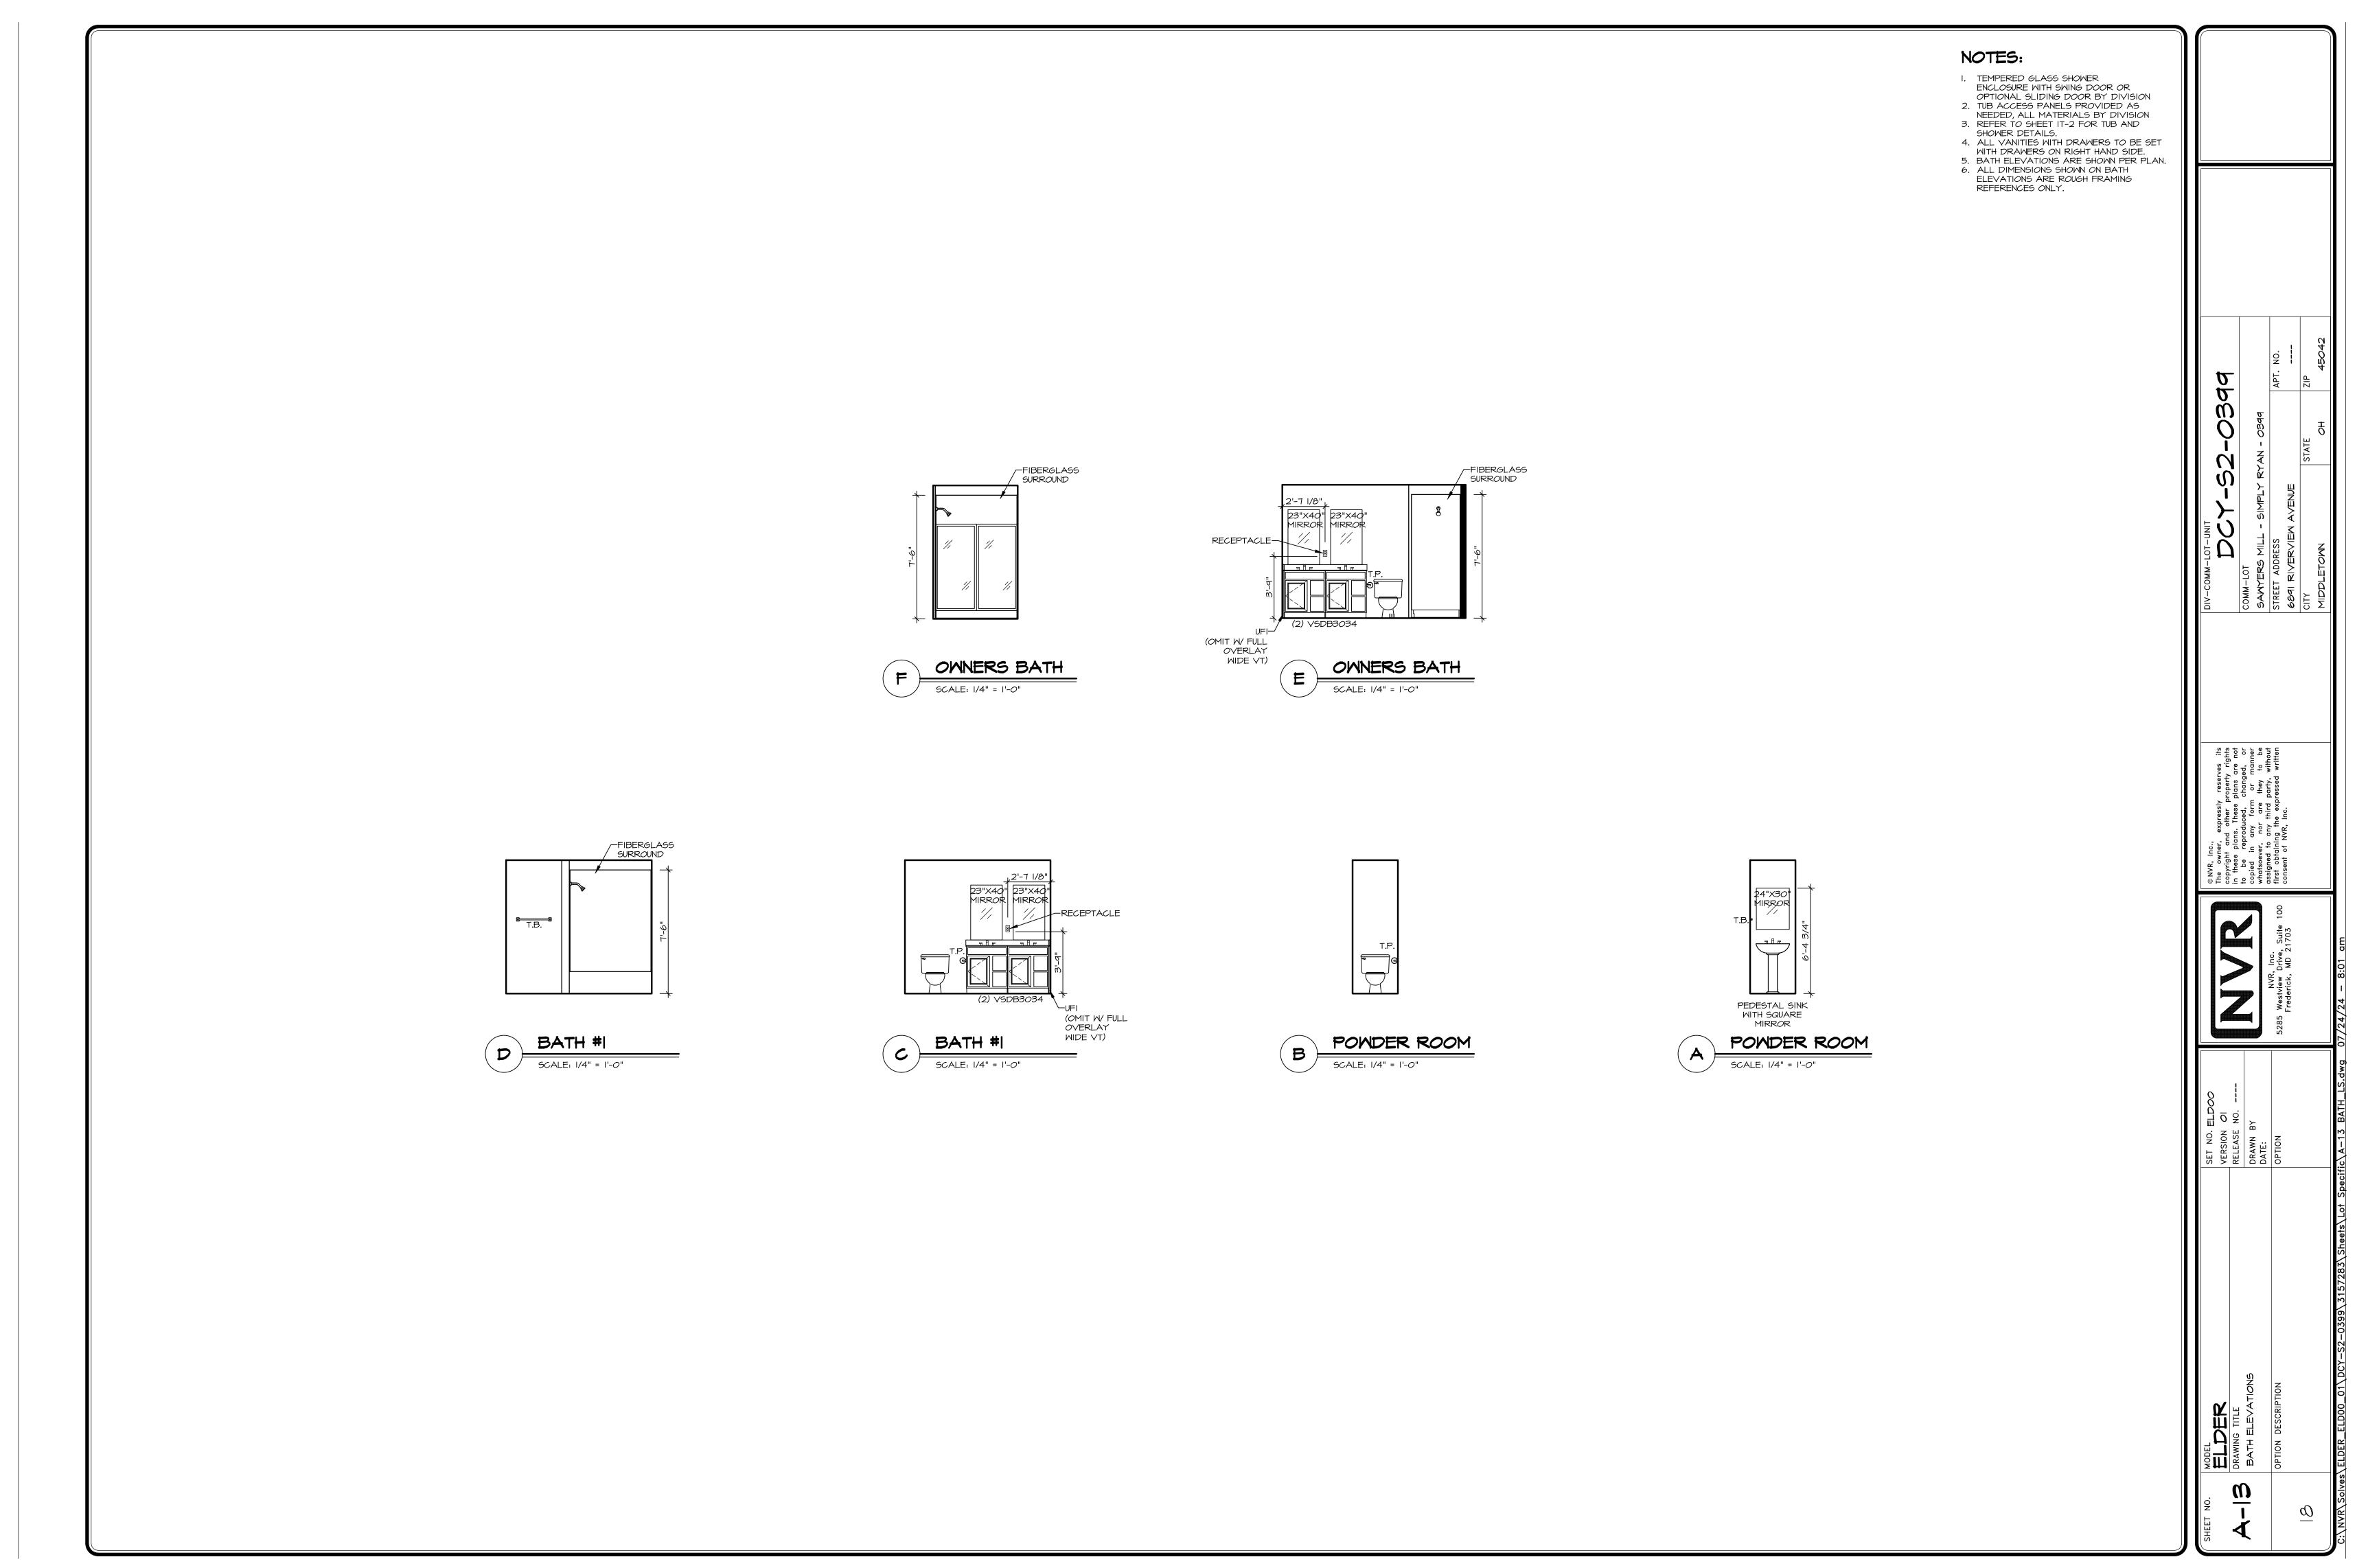

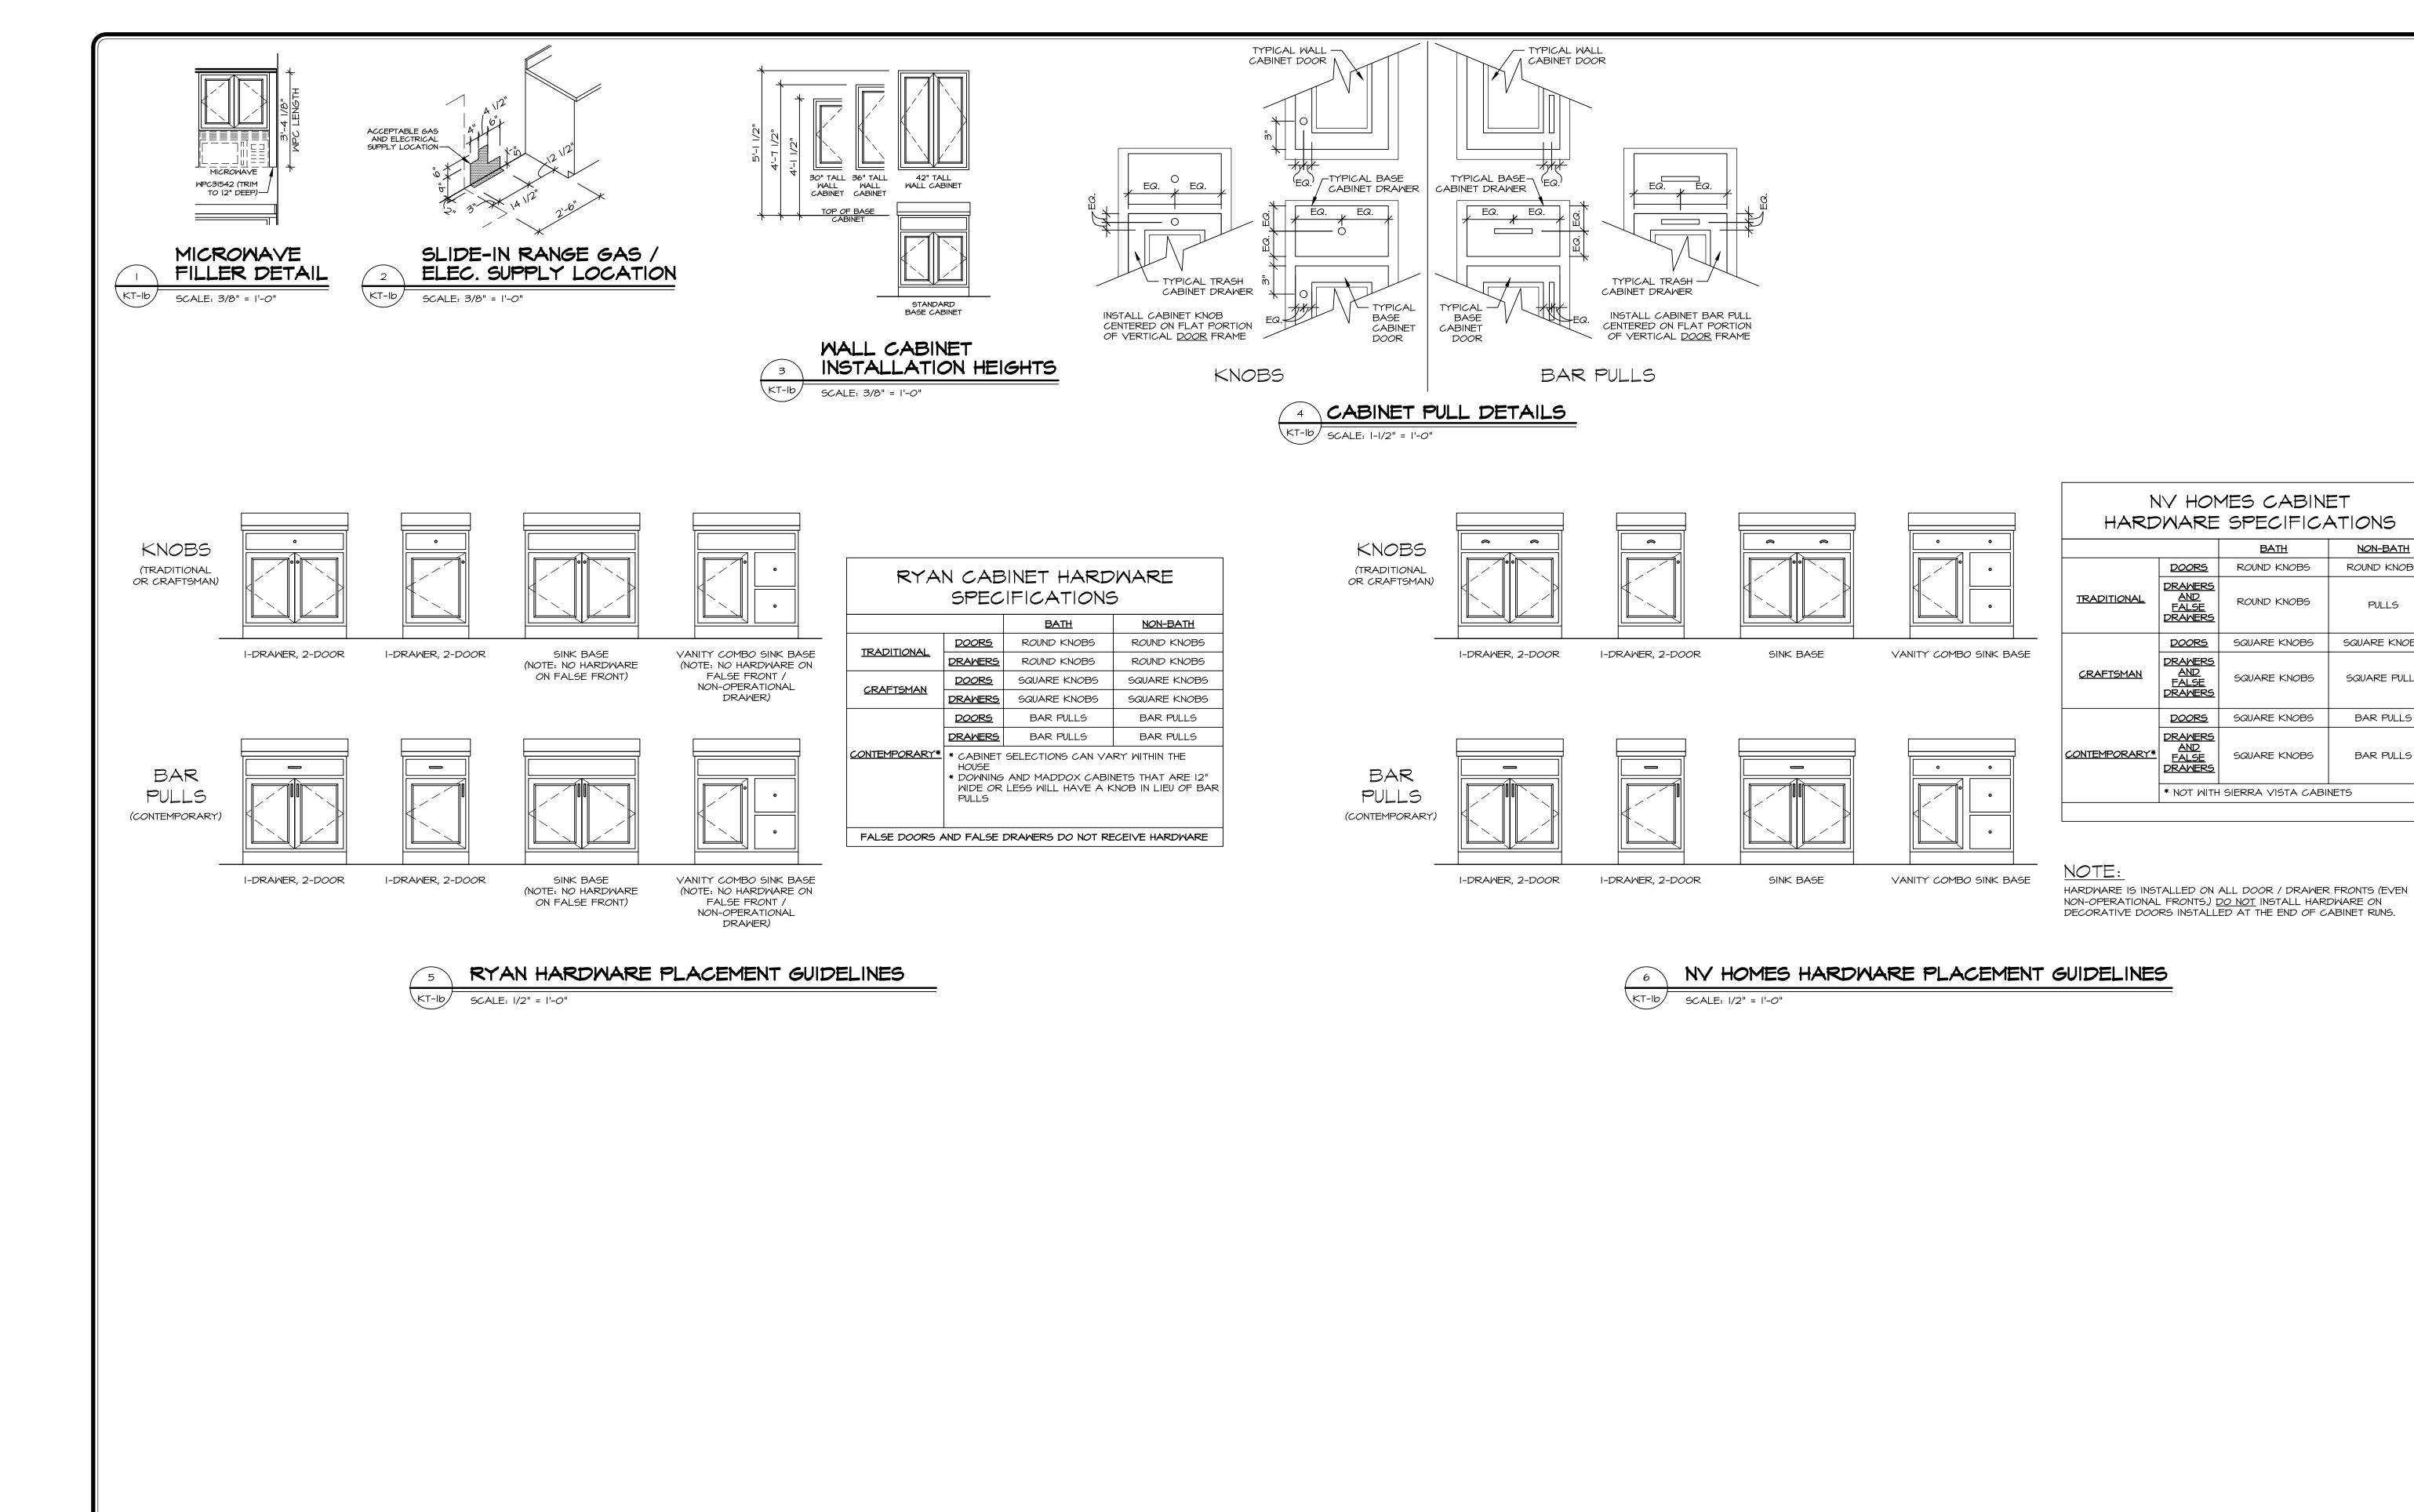

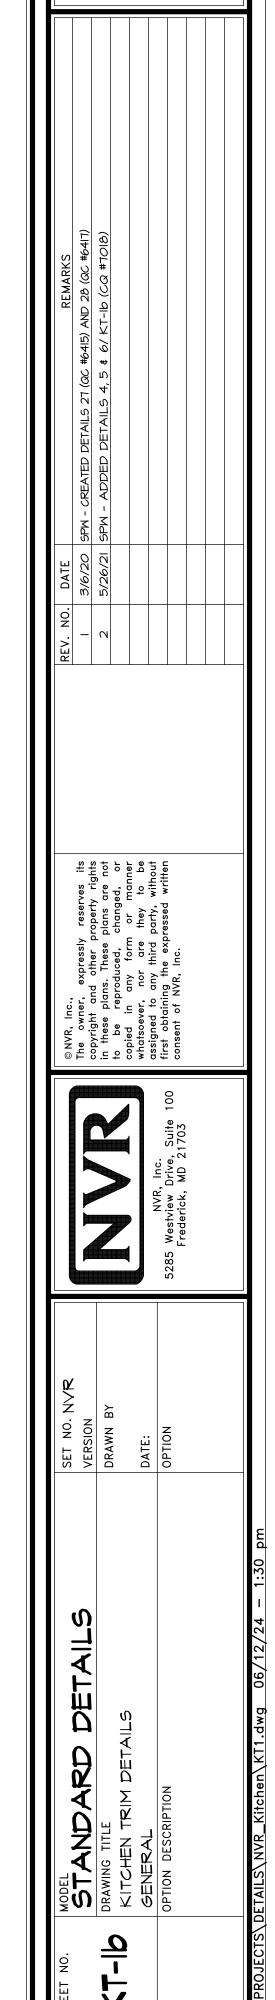

NON-BATH ROUND KNOBS

PULLS

SQUARE KNOBS

SQUARE PULLS

BAR PULLS

BAR PULLS