
S2 403 7021 RIVERVIEW AVENUE MIDDLETOWN, OH 45042

2 Story Basement
2 hose bibs - no valves required
Vent Kitchen
ice maker
2 tubs
WATER HEATER ELECTRIC 40 GALLON
Inside Water Meter setup

Gas Furnace

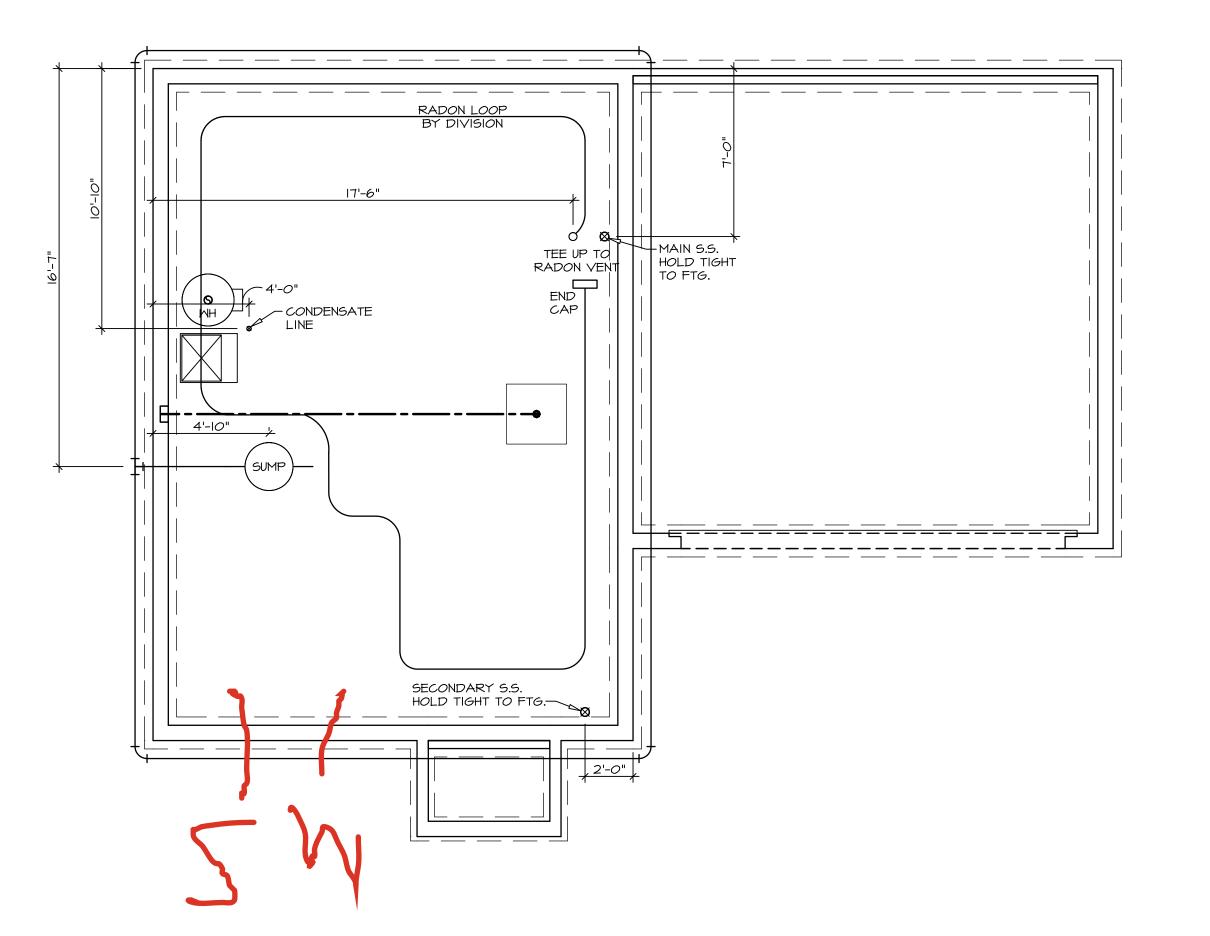



- PLUMBING NOTES:

  RADON REMEDIATION

  RADON LOOP:

   (4") PERFORATED HDPE "LOOP"

   MUST BE PLACED IN STONE BED SLIGHTLY HIGHER THAN ANY INTERIOR DRAINTILE

   LOOP TO BE SEPARATE FROM ANY DRAINTILE ELEMENTS

   TO BE CORRUGATED HDPE PIPE

   SCREWS TO BE INSTALLED THROUGH LOOP AT TEE UP INTO STACK

  STACK REQUIREMENTS:

   3" PVC STACK (4" IF BASEMENT IS GREATER THAN 2200 SQFT.)

   NO PART OF STACK IS TO BE HORIZONTAL (45° ELBOWS PERMITTED AS REQUIRED)

   PIPE TO BE PHYSICALLY LABELED IN THE FIELD AS "RADON VENT" OR OTHER

  JURISDICTIONALLY REQUIRED LANGUAGE (ON EVERY LEVEL OF HOUSE)


- JURISDICTIONALLY REQUIRED LANGUAGE (ON EVERY LEVEL OF HOUSE)

   ROOF TERMINATION TO BE IN TOP 1/3 OF ROOF

   SCREEN OR VENT CAP INSTALLED TO KEEP PESTS OUT OF RADON VENT AT ROOF TERMINATIO

ION.	
	DCY-52-0403  MILL - SIMPLY RYAN - 0403  RESS  FRVIEW AVENUE  STATE  OH  45042
	DIV-COMM-LOT-UNIT  DCY-52-04  COMM-LOT  SAMYERS MILL - SIMPLY RYAN - 0403  STREET ADDRESS  7021 RIVERVIEW AVENUE  CITY  MIDDLETOWN  OH
	© NVR, Inc., The owner, expressly reserves its copyright and other property rights in these plans. These plans are not to be reproduced, changed, or copied in any form or manner whatsoever, nor are they to be assigned to any third party, without first obtaining the expressed written consent of NVR, Inc.
	NVR, Inc. 5285 Westview Drive, Suite 100 Frederick, MD 21703 co
	SET NO. ASPOO VERSION OI RELEASE NO DRAWN BY DATE: OPTION
	ASPEN DRAWING TITLE PLUMBING OPTION DESCRIPTION


PLUMBING PLAN

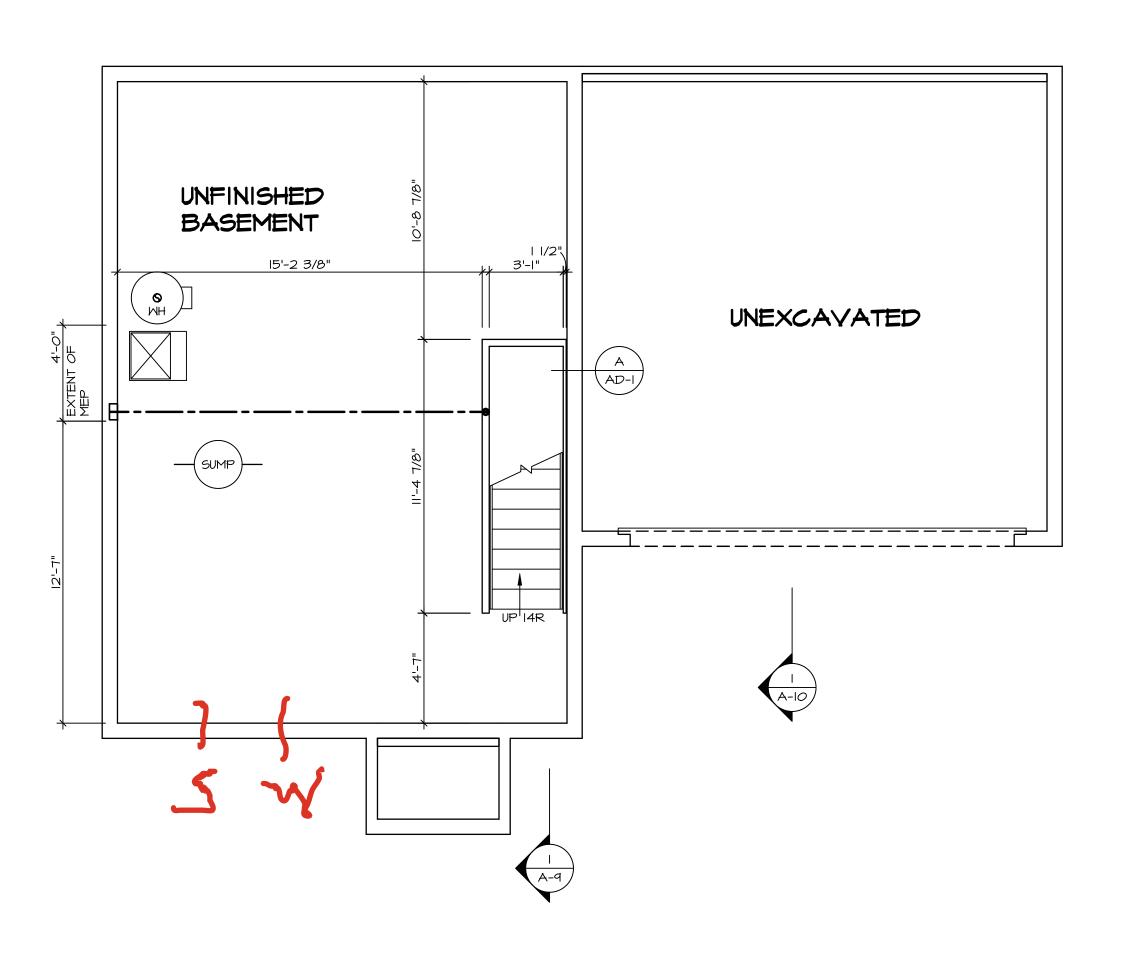

BASEMENT JACK SCHEDULE

IDENTIFIER DESCRIPTION ENG. NUM. REMARKS



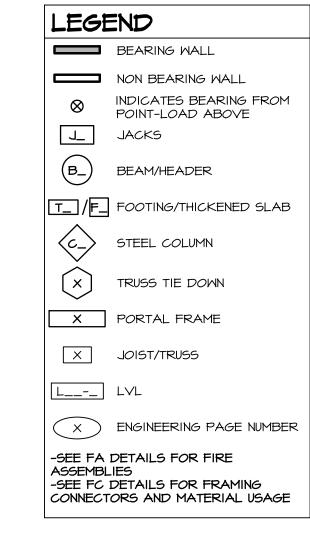

# FLOOR PLAN NOTES:

- ALL HEADERS ARE (2) 2x6 w/ 2x4 WALLS OR (3) 2x6 w 2x6 WALLS, UNLESS OTHERWISE NOTED.
   ALL HEADERS TO HAVE (I) 2x4 OR 2x6 JACK AND KING STUD EACH END, UNLESS OTHERWISE NOTED. MULTI-OPENING HEADERS TO HAVE (2) JACKS AT INTERMEDIATE BEARING, UNLESS OTHERWISE NOTED. NO ADDITIONAL FLOOR SYSTEM BLOCKING OR CONTINUOUS LOAD PATH JACKS ARE REQUIRED UNLESS OTHERWISE
- 3. ALL EXTERIOR WALLS TO BE 4" OR 6" AND ALL INTERIOR WALLS TO BE 3 I/2", UNLESS OTHERWISE NOT 4. HATCHED AREAS INDICATE DROPPED CEILINGS. ALL DROPPED CEILINGS ARE I2" UNLESS OTHERWISE NOTEI SEE ARCHITECTURAL DETAIL 8/IT-IB FOR 3/4" FIRE STOPPING AT BULKHEAD / CEILING PANELS 5. SEE "BRACED WALL PANEL DETAIL SHEET" FOR SPECI
- 5. SEE "BRACED WALL PANEL DETAIL SHEET" FOR SPECI WALL FRAMING LOCATIONS AND HEADER SIZES, IF APPLICABLE.
- 6. SEE STANDARD DETAIL CATEGORY "IT" SHEET(S) FOR
- INTERIOR TRIM DETAILS.

  7. SEE ARCHITECTURAL DETAIL SHEET "AD" FOR HOUSE SPECIFIC INTERIOR TRIM OPTION TABLE.
- 8. ALL HEADERS IN NON-BEARING WALLS SHALL BE A SINGLE FLAT 2X4 OR 2X6 ATTACHED TO CRIPPLES ABOVE, UNLESS OTHERWISE NOTED.
- 9. TANKED WATER HEATER SHOWN AS BASE CONDITION,
  OPTIONAL TANKLESS WATER HEATER IS AVAILABLE IN
  LIEU OF TANKED WATER HEATER.
- IO. INTERIOR HEADER HEIGHT FOR 8' CEILING WILL BE 6'-1
  9' CEILING WILL BE 7'-11", IO' CEILING WILL BE 8'-3",
  INTERIOR OTHERWISE NOTED
- UNLESS OTHERWISE NOTED.

  II. BASEMENT FINISH DIMENSIONS ASSUME A 1/2" GAP

  BETWEEN FRAME WALL AND CONCRETE WALL
- BETWEEN FRAME WALL AND CONCRETE WALL.

  12. ALL INTERIOR BEARING WALLS SHALL HAVE GYPSUM
  APPLIED TO AT LEAST ONE SIDE OR HAVE MID-HEIGHT
- BLOCKING INSTALLED.

  13. NON-BEARING WALLS OVER CONCRETE TO BE HELD 1/2
  SHORT OF FRAMING ABOVE.

# GYPSUM NOTES:

AT GARAGE:

GYPSUM BOARD AT COMMON WALLS, CEILINGS, BEAM WRAPS AND SUPPORTS PER STANDARD DETAIL **FA-I(b)** FIRE ASSEMBLIES OR AS REQUIRED BY LOCAL CODE.


AT STAIRS:

| | I/2" GYPSUM BOARD AT UNDERSIDE OF STAIRS AND WALLS | IN CLOSET

_AB	
1BER	API. NO.
	API
12 - SIMPLY RYAN - 0403	vo.
SAMYERS MIL	SIREEI ADDRESS
DTED.	<u> </u>
CIAL R	
	first obtaining the expressed written
© NVR, Inc., The owner, copyright and in these plans to be separate opied in arrangements whatsoever, nassigned to an	first obtaining the exp
NVR. Inc.	5285 Westview Drive, Suite 100
SET NO. ASPOOVERSION OI RELEASE NO DRAWN BY DATE:	OPTION

	FIRST FLOOR JACK S	SCHEDUL	.E
IDENTIFIER	DESCRIPTION	ENG. NUM.	REMARKS
IOIL	JACK - (2) 2X4 SPF STUD GRADE	1024	
JI02	JACK - (2) 2X4 SPF STUD GRADE	1024	
SOIL	JACK - (3) 2X4 SP#I	1016	
JIO4	JACK - (3) 2X4 SP#I	1016	
JI <i>0</i> 5	JACK - (2) 2X4 SPF STUD GRADE	1012	
JI06	JACK - (2) 2X4 SPF STUD GRADE	1012	
TOIL	JACK - (2) 2X4 SPF STUD GRADE	1012	
80IL	JACK - (2) 2X4 SPF STUD GRADE	1018	
POIL	JACK - (2) 2X4 SPF STUD GRADE	1018	
OIIL	JACK - (2) 2X4 SPF STUD GRADE	1012	

FIELD	INSTALLED FIRST FL	OOR BEAM	HEADER	SCHEDULE
IDENTIFIER	DESCRIPTION	LENGTH	ENG. NUM.	REMARKS

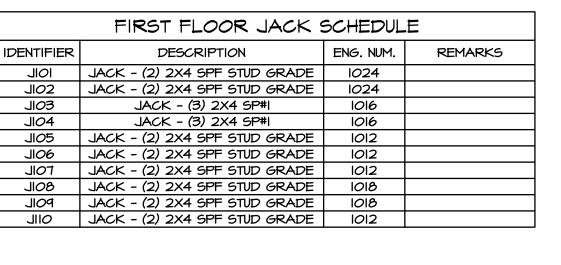



- ALL HEADERS ARE (2) 2x6 w/ 2x4 WALLS OR (3) 2x6 w/ 2x6 WALLS, UNLESS OTHERWISE NOTED.

  2. ALL HEADERS TO HAVE (1) 2x4 OR 2x6 JACK AND KING STUD EACH END, UNLESS OTHERWISE NOTED. MULTI-OPENING HEADERS TO HAVE (2) JACKS AT INTERMEDIATE BEARING, UNLESS OTHERWISE NOTED. NO ADDITIONAL FLOOR SYSTEM BLOCKING OR CONTINUOUS LOAD PATH JACKS ARE REQUIRED UNLESS OTHERWISE
- 3. ALL EXTERIOR WALLS TO BE 4" OR 6" AND ALL INTERIOR WALLS TO BE 3 1/2", UNLESS OTHERWISE NOTED.
- HATCHED AREAS INDICATE DROPPED CEILINGS. ALL DROPPED CEILINGS ARE 12" UNLESS OTHERWISE NOTED. SEE ARCHITECTURAL DETAIL 8/IT-IB FOR 3/4" FIRE STOPPING AT BULKHEAD / CEILING PANELS
  . SEE "BRACED WALL PANEL DETAIL SHEET" FOR SPECIAL
- APPLICABLE.
- . SEE STANDARD DETAIL CATEGORY "IT" SHEET(S) FOR INTERIOR TRIM DETAILS.
- . SEE ARCHITECTURAL DETAIL SHEET "AD" FOR HOUSE SPECIFIC INTERIOR TRIM OPTION TABLE.
- ABOVE, UNLESS OTHERWISE NOTED. I. TANKED WATER HEATER SHOWN AS BASE CONDITION, OPTIONAL TANKLESS WATER HEATER IS AVAILABLE IN
- LIEU OF TANKED WATER HEATER. D. INTERIOR HEADER HEIGHT FOR 8' CEILING WILL BE 6'-II",
- 9' CEILING WILL BE 7'-II", IO' CEILING WILL BE 8'-3", UNLESS OTHERWISE NOTED.

  BASEMENT FINISH DIMENSIONS ASSUME A 1/2" GAP
- BETWEEN FRAME WALL AND CONCRETE WALL. 12. ALL INTERIOR BEARING WALLS SHALL HAVE GYPSUM APPLIED TO AT LEAST ONE SIDE OR HAVE MID-HEIGHT BLOCKING INSTALLED.
- 13. NON-BEARING WALLS OVER CONCRETE TO BE HELD 1/2" SHORT OF FRAMING ABOVE.

## GYPSUM NOTES:

AT GARAGE:

GYPSUM BOARD AT COMMON WALLS, CEILINGS, BEAM WRAPS AND SUPPORTS PER STANDARD DETAIL FA-I(b) FIRE ASSEMBLIES OR AS REQUIRED BY LOCAL CODE.


AT STAIRS:

1/2" GYPSUM BOARD AT UNDERSIDE OF STAIRS AND WALLS


3-7	1	<u> </u>	
JOS STANCHION BY CONTRACTION BY CONT	1028) HB 1026		
	Sink   DW   Sink   Sink   DW   Sink   Sink   DW   Si	IQUE SIDE OF STAIRS AD-1, STAIR	=Oac
	6'-0" 8'-0" 6'-0" 20'-0"	2'-0"	



LEGEND BEARING WALL NON BEARING WALL INDICATES BEARING FROM POINT-LOAD ABOVE J\_ JACKS BEAM/HEADER T\_ /F\_ FOOTING/THICKENED SLAB STEEL COLUMN TRUSS TIE DOWN X PORTAL FRAME X JOIST/TRUSS L\_\_-\_ LVL X ENGINEERING PAGE NUMBER -SEE FA DETAILS FOR FIRE ASSEMBLIES -SEE FC DETAILS FOR FRAMING CONNECTORS AND MATERIAL USAGE WALL FRAMING LOCATIONS AND HEADER SIZES, IF . ALL HEADERS IN NON-BEARING WALLS SHALL BE A SINGLE FLAT 2X4 OR 2X6 ATTACHED TO CRIPPLES

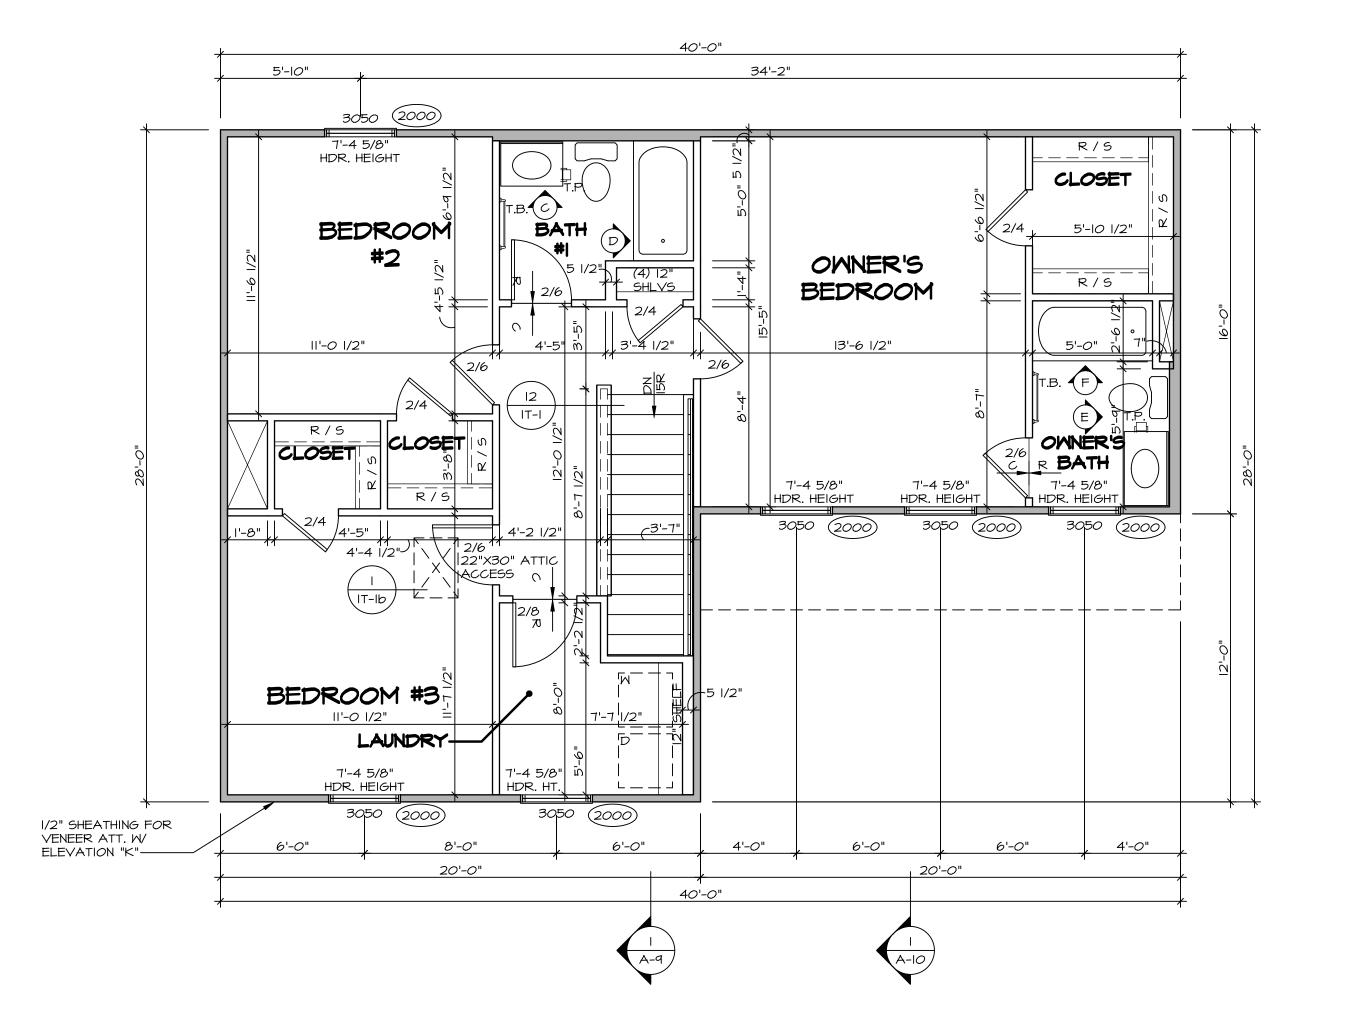



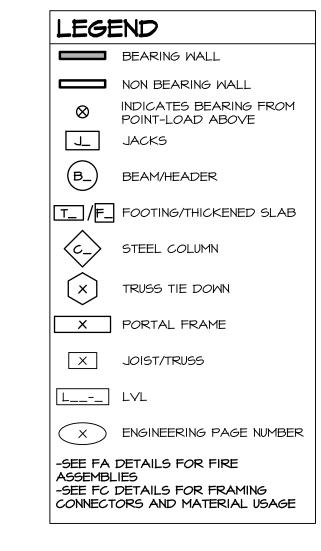

### FLOOR PLAN NOTES:

- ALL HEADERS ARE (2) 2x6 w/ 2x4 WALLS OR (3) 2x6 2x6 WALLS, UNLESS OTHERWISE NOTED. ALL HEADERS TO HAVE (1) 2x4 OR 2x6 JACK AND K STUD EACH END, UNLESS OTHERWISE NOTED. MULTI-OPENING HEADERS TO HAVE (2) JACKS AT INTERMEDIATE BEARING, UNLESS OTHERWISE NOTED. ADDITIONAL FLOOR SYSTEM BLOCKING OR CONTINUE LOAD PATH JACKS ARE REQUIRED UNLESS OTHERWIS NOTED.
- . ALL EXTERIOR WALLS TO BE 4" OR 6" AND ALL INTERIOR WALLS TO BE 3 1/2", UNLESS OTHERWISE NO . HATCHED AREAS INDICATE DROPPED CEILINGS. ALL DROPPED CEILINGS ARE 12" UNLESS OTHERWISE NOT SEE ARCHITECTURAL DETAIL 8/IT-IB FOR 3/4" FIRE STOPPING AT BULKHEAD / CEILING PANELS SEE "BRACED WALL PANEL DETAIL SHEET" FOR SPEC
- WALL FRAMING LOCATIONS AND HEADER SIZES, IF APPLICABLE. SEE STANDARD DETAIL CATEGORY "IT" SHEET(S) FOR
- INTERIOR TRIM DETAILS. SEE ARCHITECTURAL DETAIL SHEET "AD" FOR HOUSE
- SPECIFIC INTERIOR TRIM OPTION TABLE. ALL HEADERS IN NON-BEARING WALLS SHALL BE A
- SINGLE FLAT 2X4 OR 2X6 ATTACHED TO CRIPPLES ABOVE, UNLESS OTHERWISE NOTED. TANKED WATER HEATER SHOWN AS BASE CONDITION, OPTIONAL TANKLESS WATER HEATER IS AVAILABLE I
- LIEU OF TANKED WATER HEATER. D. INTERIOR HEADER HEIGHT FOR 8' CEILING WILL BE 6'-9' CEILING WILL BE 7'-II", IO' CEILING WILL BE 8'-3",
- UNLESS OTHERWISE NOTED. BASEMENT FINISH DIMENSIONS ASSUME A 1/2" GAP BETWEEN FRAME WALL AND CONCRETE WALL. 12. ALL INTERIOR BEARING WALLS SHALL HAVE GYPSUM
- APPLIED TO AT LEAST ONE SIDE OR HAVE MID-HEIGH BLOCKING INSTALLED. 13. NON-BEARING WALLS OVER CONCRETE TO BE HELD I SHORT OF FRAMING ABOVE.

# GYPSUM NOTES:


AT GARAGE:

GYPSUM BOARD AT COMMON WALLS, CEILINGS, BEAM WRAPS AND SUPPORTS PER STANDARD DETAIL **FA-I(b)** FIRE ASSEMBLIES OR AS REQUIRED BY LOCAL CODE.


AT STAIRS:

1/2" GYPSUM BOARD AT UNDERSIDE OF STAIRS AND WAL IN CLOSET


ROM		
ILAB		
MBER AGE	7-52-0403	SAMYERS MILL - SIMPLY RYAN - 0403
K6 W/ KING NO JOUS ISE	DIV-COMM-LOT-UNIT  COMM-LOT	SAMYERS MILL - S
OTED.  LL TED.  ECIAL  DR		
N, E IN 5'-II", M GHT	© NVR, Inc., The owner, expressly reserves its copyright and other property rights in these plans. These plans are not to be reproduced, changed, or copied in any form or manner	whatsoever, nor are they to be
	NVR	
ALLS	SET NO. ASPOO VERSION OI RELEASE NO	DATE:

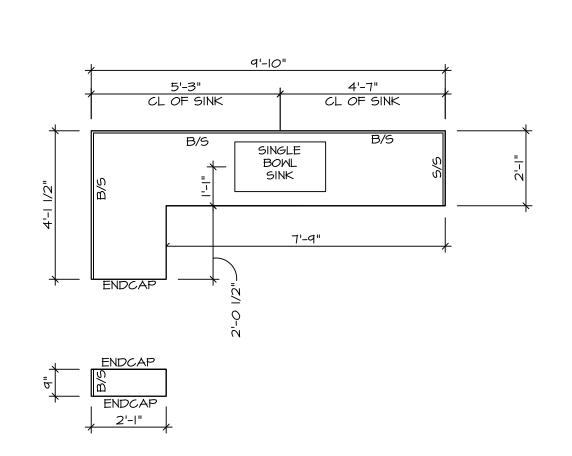


KITCHEN COUNTERTOP PLAN KC - 3639 A-12 SCALE: 3/8" = 1'-0"

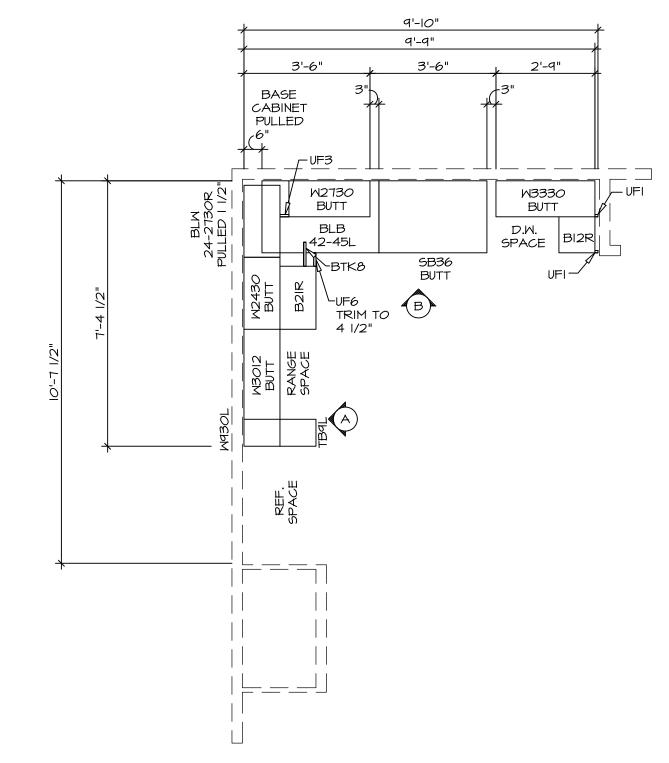

KITCHEN CABINET PLAN KC - 3639 A-12 SCALE: 3/8" = 1'-0"

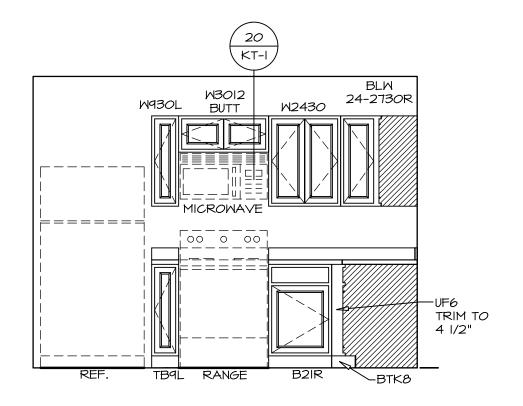



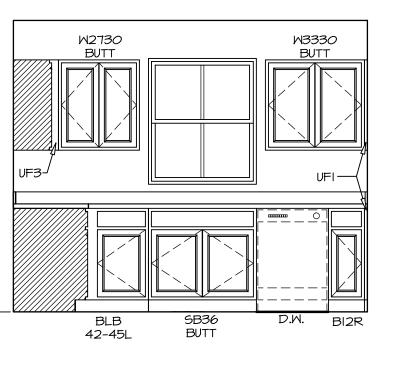



NOTES:

CABINETS ARE NOT REPRESENTATIVE OF ALL
STYLES AND ARE MEANT AS A GENERAL
DEPICTION OF THE INTENDED CABINET LAYOUT


KITCHEN NOTES:


I. CABINET LAYOUT (S) ARE BASED ON FINISHED DIMENSIONS TO DRYWALL.


2. IF KITCHEN PLANS/ELEVATIONS CALL-OUT STANDARD MOLDING, REFER TO STANDARD DETAIL (II/KT-I) FOR REPLACEMENT BASED ON CABINET STYLE.


3. ALL (UF#) FILLERS ARE TO BE "TRIM TO FIT" UNLESS OTHERWISE NOTED.


4. CABINET MUST BE SET, SHIMMED, LEVELED AND PLUMB W/ ADJOINING BASE CABINETS. 5. SET PRE-FINISHED SCRIBE MOLDING AT CABINET BULKHEADS AND AT ENDS (WHERE CABINET BURNEADS AND AT ENDS (WHERE CABINETS MEET DRYWALL.) PRE-FINISHED = SCRIBE MOLDING SHALL BE USED TO PAD OUT CABINET SIDES AT STILE FOR RETURN PIECES OF THE FACE-MOUNTED CABINET CROWN MOLDING.

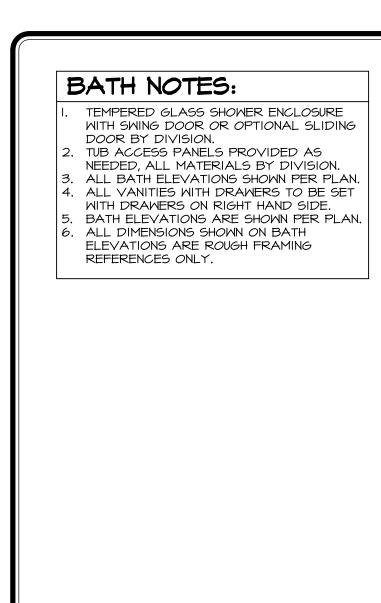


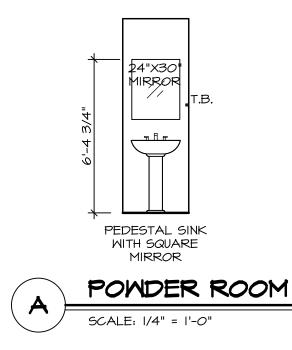


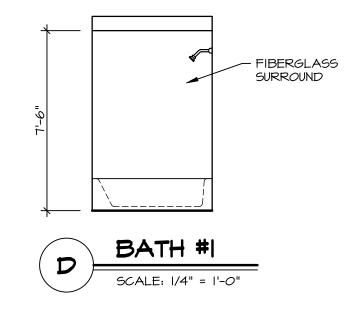

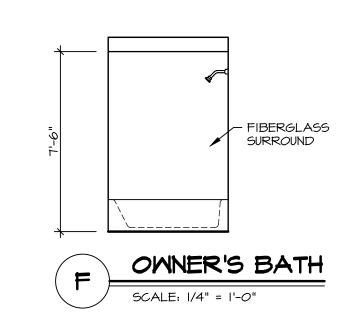

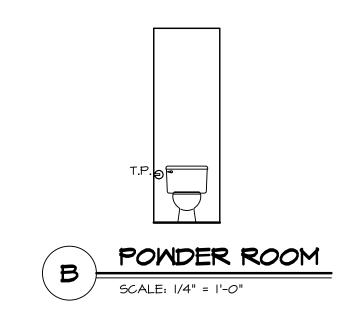

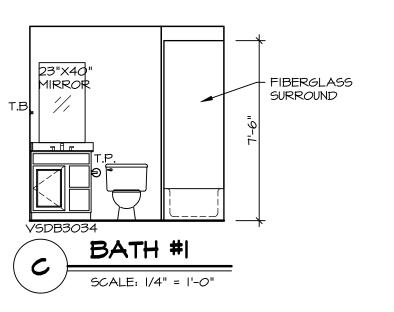

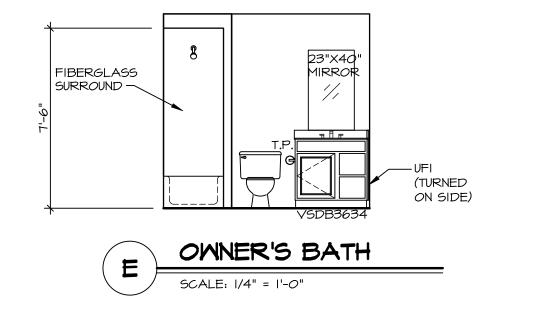

NIT 7-02-0409		1 - 0403	APT. NO.	-	STATE ZIP	77
DIV-COMM-LOT-UNIT	COMM-LOT	SAMYERS MILL - SIMPLY RYAN - 0403	STREET ADDRESS	1021 RIVERVIEM AVENUE	CITY	
its	not	be be	itten			
© NVR, Inc., The owner, expressly reserves its copyright and other property rights	in these plans. These plans are not to be reproduced, changed, or	whatsoever, nor are they to be	first obtaining the expressed written	consent of NVK, Inc.		
	\ \ \ \ \ \ \ \ \ \ \ \ \ \ \ \ \ \ \		NVR, Inc. 5285 Westview Drive, Suite 100	Frederick, MD 21703		
SET NO. ASPOO VERSION OI	RELEASE NO	DRAWN BY DATE:	OPTION	-	-	