
S2 411 6872 RIVULET DRIVE MIDDLETOWN, OH 45042

2 Story Basement
2 hose bibs - no valves required
Vent Kitchen
ice maker
2 tubs
WATER HEATER ELECTRIC 50 GALLON
Inside Water Meter setup

Gas Furnace

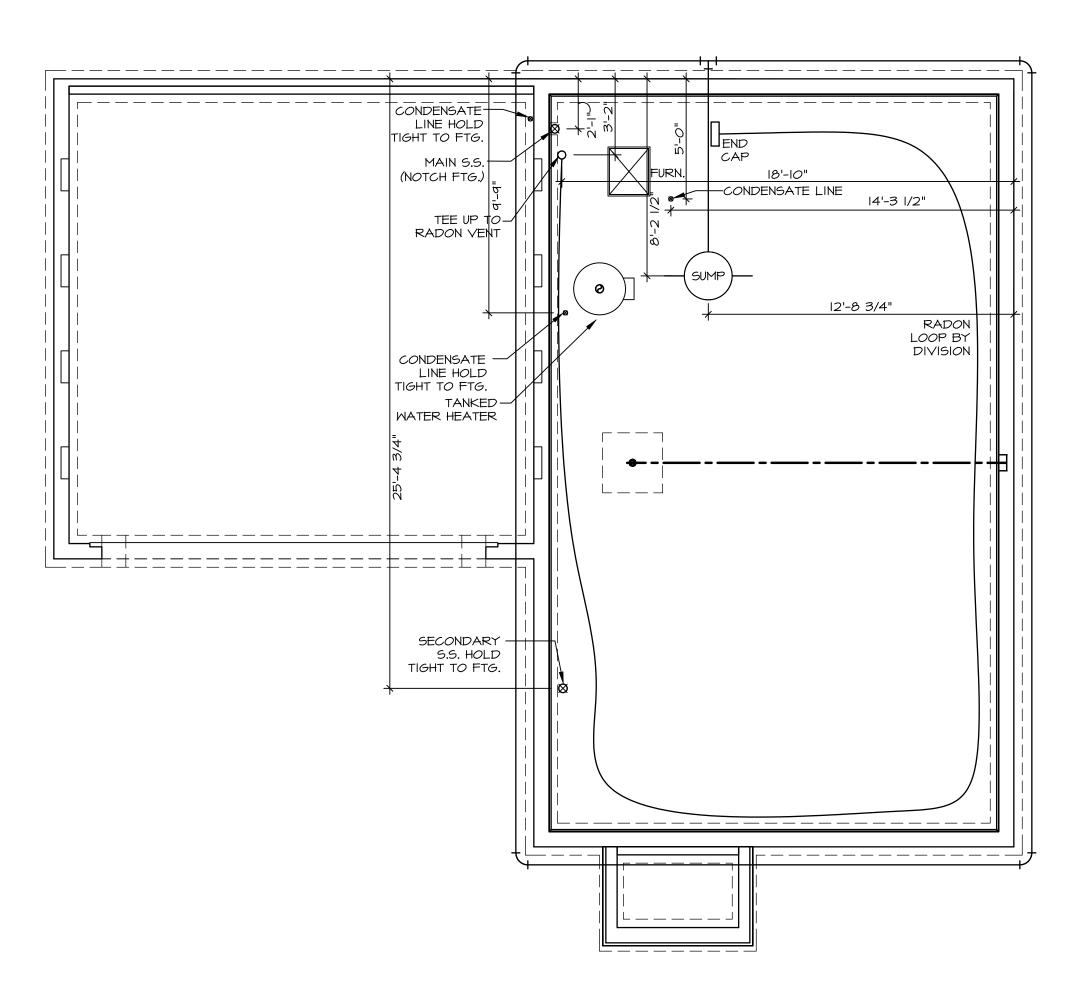

PLUMBING PLAN A-4 SCALE: 1/4" = 1'-0"

PLUMBING NOTES:

RADON REMEDIATION

RADON LOOP:

- (4") PERFORATED HDPE "LOOP"

- MUST BE PLACED IN STONE BED SLIGHTLY HIGHER THAN ANY INTERIOR DRAINTILE

- LOOP TO BE SEPARATE FROM ANY DRAINTILE ELEMENTS

- TO BE CORRUGATED HDPE PIPE

- SCREWS TO BE INSTALLED THROUGH LOOP AT TEE UP INTO STACK

STACK REQUIREMENTS:


- SCREWS TO BE INSTALLED THROUGH LOOP AT TEE UP INTO STACK

STACK REQUIREMENTS:
- 3" PVC STACK (4" IF BASEMENT IS GREATER THAN 2200 SQFT.)
- NO PART OF STACK IS TO BE HORIZONTAL (45° ELBOWS PERMITTED AS REQUIRED)
- PIPE TO BE PHYSICALLY LABELED IN THE FIELD AS "RADON VENT" OR OTHER

JURISDICTIONALLY REQUIRED LANGUAGE (ON EVERY LEVEL OF HOUSE)
- ROOF TERMINATION TO BE IN TOP 1/3 OF ROOF
- SCREEN OR VENT CAR INSTALLED TO KEEP PESTS OUT OF RADON VENT AT POOF TER

SCREEN OR VENT CAP INSTALLED TO KEEP PESTS OUT OF RADON VENT AT ROOF TERMINATION.

	=		APT. NO.	717
	DCY-52-04	27 AN - 0411	11441	SIAIE
	DIV-COMM-LOT-UNIT	COMM-LOT SAMYERS MILL - SIMPLY RYAN - 0411	STREET ADDRESS 6872 RIVULET DRIVE	
	© NVR, Inc., The owner, expressly reserves its copyright and other property rights in these plans. These plans are not	to be reproduced, changed, or copied in any form or manner whatsoever, nor are they to be assigned to any third party, without	first obtaining the expressed written consent of NVR, Inc.	
	© NVR, Inc., The owner, copyright an	to be copied i whatsoeve		
			NVK, Inc. 5285 Westview Drive, Suite 100 Frederick, MD 21703	
	SET NO. BRHOO VERSION OI	DRAWN BY	OPTION	
	MODEL MODEL TITLE	PLUMBING	OPTION DESCRIPTION	
		+		

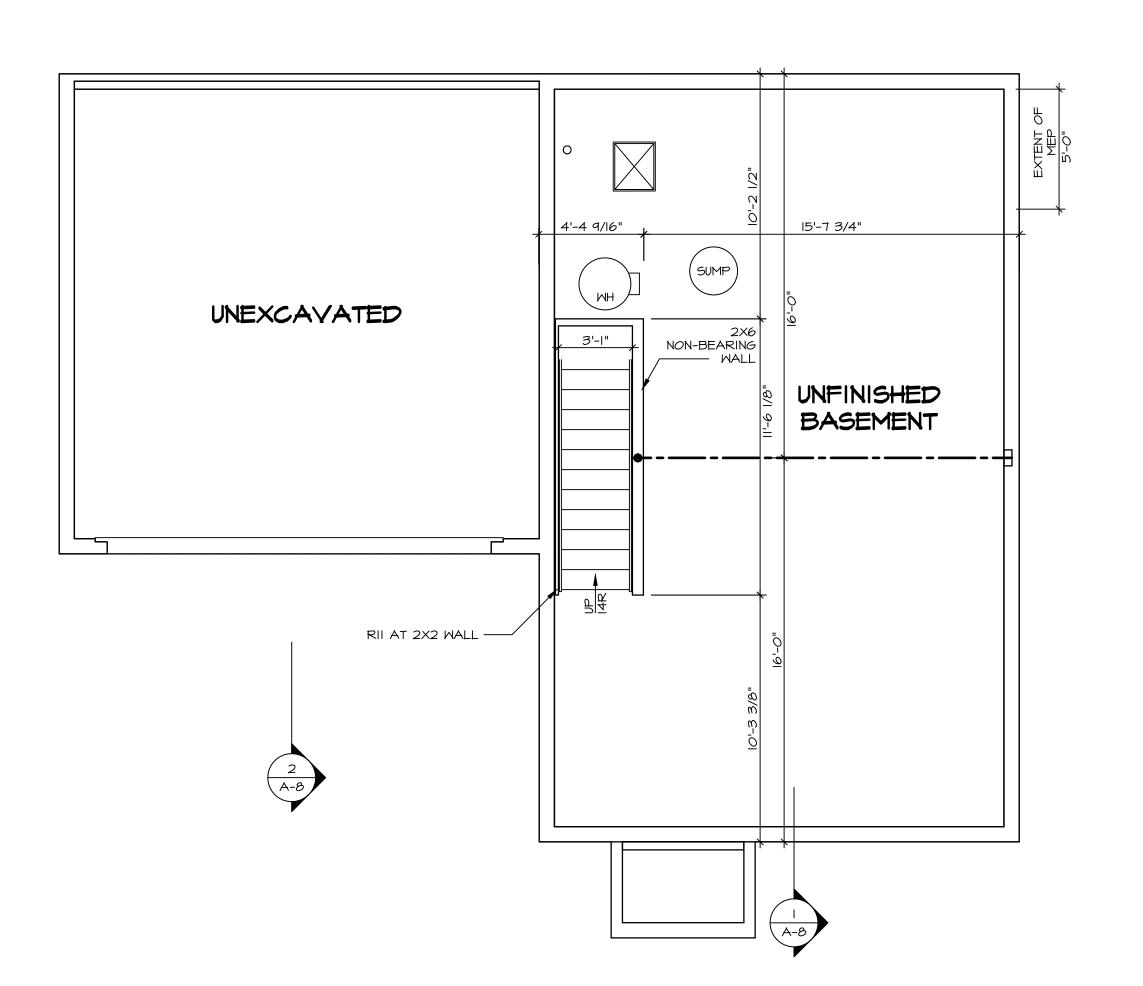

ALL WINDOWS HAVE 7'-4 5/8" HEADER HEIGHT UNLESS OTHERWISE NOTED

LEGEND BEARING WALL NON BEARING WALL INDICATES BEARING FROM POINT-LOAD ABOVE J_ JACKS BEAM/HEADER T_/F_ FOOTING/THICKENED SLAB STEEL COLUMN TRUSS TIE DOWN X PORTAL FRAME X JOIST/TRUSS L__-_ LVL X ENGINEERING PAGE NUMBER

> -SEE FA DETAILS FOR FIRE ASSEMBLIES
> -SEE FC DETAILS FOR FRAMING CONNECTORS AND MATERIAL USAGE

FLOOR PLAN NOTES:

2x6 WALLS, UNLESS OTHERWISE NOTED.

. ALL HEADERS TO HAVE (1) 2x4 OR 2x6 JACK AND KING STUD EACH END, UNLESS OTHERWISE NOTED. MULTI-OPENING HEADERS TO HAVE (2) JACKS AT INTERMEDIATE BEARING, UNLESS OTHERWISE NOTED. NO ADDITIONAL FLOOR SYSTEM BLOCKING OR CONTINUOUS LOAD PATH JACKS ARE REQUIRED UNLESS OTHERWISE ALL EXTERIOR WALLS TO BE 4" OR 6" AND ALL

ALL HEADERS ARE (2) 2x6 w/ 2x4 WALLS OR (3) 2x6 w/

INTERIOR WALLS TO BE 3 1/2", UNLESS OTHERWISE NOTED. . HATCHED AREAS INDICATE DROPPED CEILINGS. ALL DROPPED CEILINGS ARE 12" UNLESS OTHERWISE NOTED. SEE ARCHITECTURAL DETAIL 8/IT-IB FOR 3/4" FIRE STOPPING AT BULKHEAD / CEILING PANELS SEE "BRACED WALL PANEL DETAIL SHEET" FOR SPECIAL WALL FRAMING LOCATIONS AND HEADER SIZES, IF

APPLICABLE. SEE STANDARD DETAIL CATEGORY "IT" SHEET(S) FOR INTERIOR TRIM DETAILS. SEE ARCHITECTURAL DETAIL SHEET "AD" FOR HOUSE

SPECIFIC INTERIOR TRIM OPTION TABLE.

ALL HEADERS IN NON-BEARING WALLS SHALL BE A SINGLE FLAT 2X4 OR 2X6 ATTACHED TO CRIPPLES ABOVE, UNLESS OTHERWISE NOTED.

TANKED WATER HEATER SHOWN AS BASE CONDITION,
OPTIONAL TANKLESS WATER HEATER IS AVAILABLE IN

LIEU OF TANKED WATER HEATER. O. INTERIOR HEADER HEIGHT FOR 8' CEILING WILL BE 6'-II", 9' CEILING WILL BE 7'-II", IO' CEILING WILL BE 8'-3",

UNLESS OTHERWISE NOTED.

BASEMENT FINISH DIMENSIONS ASSUME A 1/2" GAP BETWEEN FRAME WALL AND CONCRETE WALL. 2. ALL INTERIOR BEARING WALLS SHALL HAVE GYPSUM APPLIED TO AT LEAST ONE SIDE OR HAVE MID-HEIGHT BLOCKING INSTALLED.

3. NON-BEARING WALLS OVER CONCRETE TO BE HELD 1/2" SHORT OF FRAMING ABOVE.

GYPSUM NOTES:

AT GARAGE:


GYPSUM BOARD AT COMMON WALLS, CEILINGS, BEAM WRAPS AND SUPPORTS PER STANDARD DETAIL FA-I(b) FIRE ASSEMBLIES OR AS REQUIRED BY LOCAL CODE.

AT STAIRS:

1/2" GYPSUM BOARD AT UNDERSIDE OF STAIRS AND WALLS

BASEMENT JACK SCHEDULE				
IDENTIFIER	DESCRIPTION	ENG. NUM.		

BASEMENT FLOOR PLAN A-5 SCALE: I/4" = I'-0"

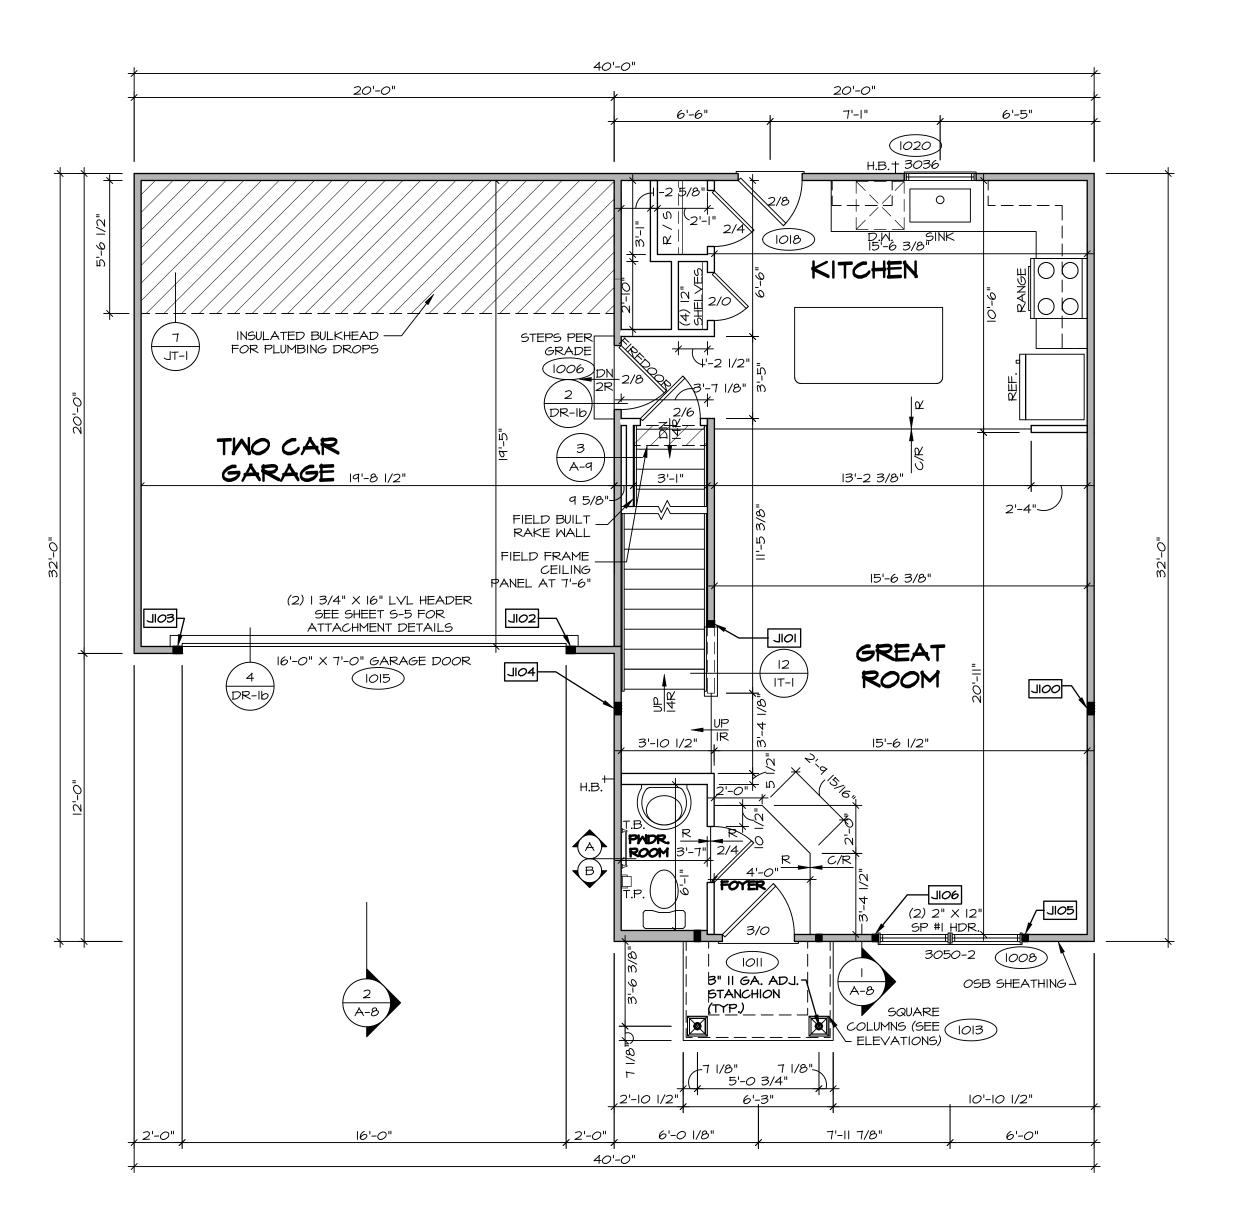



ALL WINDOWS HAVE 7'-4 5/8 HEIGHT UNLESS OTHERWISE NO

HEADER	1 = 6 =	-\
TED	LEGE	-ND
		BEARING WALL
		NON BEARING WALL
	\otimes	INDICATES BEARING FROM POINT-LOAD ABOVE
	7_	JACKS
	(B_	BEAM/HEADER
	T/F_	FOOTING/THICKENED SLAB
	⟨c_>	STEEL COLUMN
	×	TRUSS TIE DOWN
	X	PORTAL FRAME
	X	JOIST/TRUSS
	L	LVL
	X	ENGINEERING PAGE NUMBER
	ASSEMBL -SEE FC	DETAILS FOR FIRE LIES DETAILS FOR FRAMING ORS AND MATERIAL USAGE

FLOOR PLAN NOTES:

- ALL HEADERS ARE (2) 2x6 w/ 2x4 WALLS OR (3) 2x6 w/ 2x6 WALLS, UNLESS OTHERWISE NOTED. ALL HEADERS TO HAVE (I) 2x4 OR 2x6 JACK AND KING STUD EACH END, UNLESS OTHERWISE NOTED. MULTI-OPENING HEADERS TO HAVE (2) JACKS AT INTERMEDIATE BEARING, UNLESS OTHERWISE NOTED. NO ADDITIONAL FLOOR SYSTEM BLOCKING OR CONTINUOUS LOAD PATH JACKS ARE REQUIRED UNLESS OTHERWISE
- ALL EXTERIOR WALLS TO BE 4" OR 6" AND ALL INTERIOR WALLS TO BE 3 1/2", UNLESS OTHERWISE NOTES HATCHED AREAS INDICATE DROPPED CEILINGS. ALL DROPPED CEILINGS ARE 12" UNLESS OTHERWISE NOTED. SEE ARCHITECTURAL DETAIL 8/IT-IB FOR 3/4" FIRE STOPPING AT BULKHEAD / CEILING PANELS . SEE "BRACED WALL PANEL DETAIL SHEET" FOR SPECIAL WALL FRAMING LOCATIONS AND HEADER SIZES, IF
- APPLICABLE.
- SEE STANDARD DETAIL CATEGORY "IT" SHEET(S) FOR INTERIOR TRIM DETAILS.
- SEE ARCHITECTURAL DETAIL SHEET "AD" FOR HOUSE SPECIFIC INTERIOR TRIM OPTION TABLE. . ALL HEADERS IN NON-BEARING WALLS SHALL BE A SINGLE FLAT 2X4 OR 2X6 ATTACHED TO CRIPPLES ABOVE, UNLESS OTHERWISE NOTED.
- TANKED WATER HEATER SHOWN AS BASE CONDITION, OPTIONAL TANKLESS WATER HEATER IS AVAILABLE IN LIEU OF TANKED WATER HEATER.
- D. INTERIOR HEADER HEIGHT FOR 8' CEILING WILL BE 6'-II", 9' CEILING WILL BE 7'-II", IO' CEILING WILL BE 8'-3", UNLESS OTHERWISE NOTED.
- BASEMENT FINISH DIMENSIONS ASSUME A 1/2" GAP BETWEEN FRAME WALL AND CONCRETE WALL. 2. ALL INTERIOR BEARING WALLS SHALL HAVE GYPSUM APPLIED TO AT LEAST ONE SIDE OR HAVE MID-HEIGHT
- BLOCKING INSTALLED. 3. NON-BEARING WALLS OVER CONCRETE TO BE HELD 1/2" SHORT OF FRAMING ABOVE.

GYPSUM NOTES:

AT GARAGE:


GYPSUM BOARD AT COMMON WALLS, CEILINGS, BEAM WRAPS AND SUPPORTS PER STANDARD DETAIL FA-I(b) FIRE ASSEMBLIES OR AS REQUIRED BY LOCAL CODE.

AT STAIRS:

1/2" GYPSUM BOARD AT UNDERSIDE OF STAIRS AND WALLS IN CLOSET

NVR, Inc., e owner, expressly reserves its pyright and other property rights these plans. These plans are not	",		9 6-7	ER	3	1
be reproduced, changed, or		сомм-гот				
latsoever, nor are they to be		SAMYERS MILL - SIMPLY RYAN - 0411	'AN - 0411			
st obtaining the expressed written		STREET ADDRESS		APT. NO.		
nsent of NVK, Inc.		6872 RIVULET DRIVE		!		
		CITY	STATE	ZIP		
			5	777		

© NVF The copyr in th to b copie whats assig

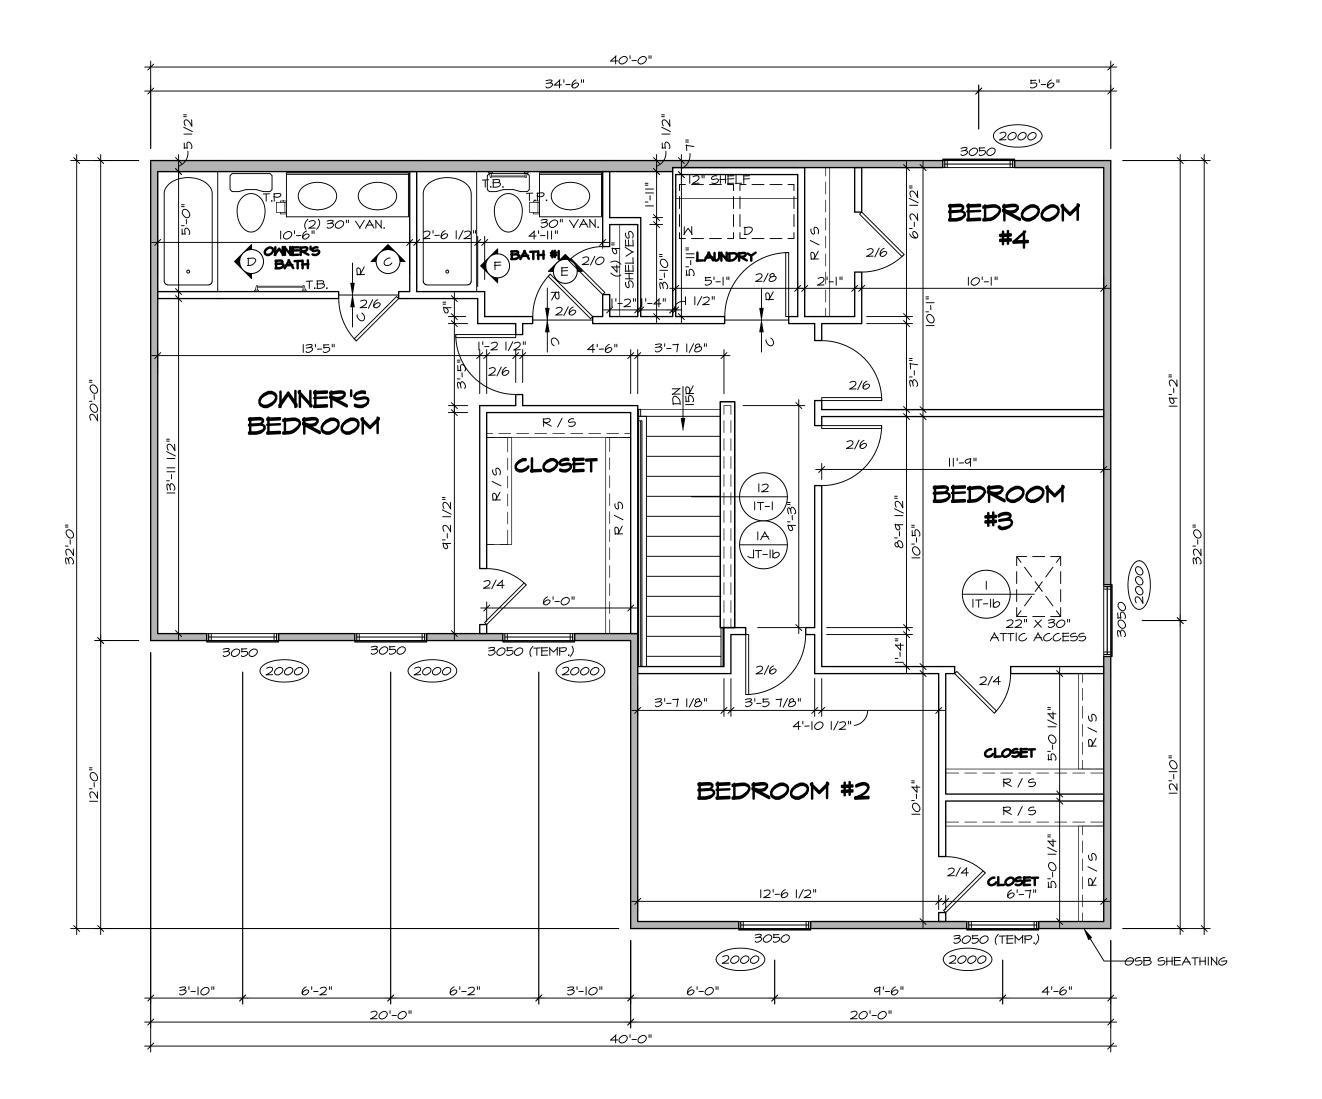







ALL WINDOWS HAVE 7'-4 5/8" HE, HEIGHT UNLESS OTHERWISE NOTES

	-	
" HEADER IOTED	LEGE	END .
		BEARING WALL
		NON BEARING WALL
	8	INDICATES BEARING FROM POINT-LOAD ABOVE
	7_	JACKS
	B_	BEAM/HEADER
	T_ /F_	FOOTING/THICKENED SLAB
	⟨c_>	STEEL COLUMN
	$\langle \times \rangle$	TRUSS TIE DOWN
	X	PORTAL FRAME
	X	JOIST/TRUSS
	L	LVL
	X	ENGINEERING PAGE NUMBER
	ASSEMBL -SEE FC I	DETAILS FOR FIRE IES DETAILS FOR FRAMING ORS AND MATERIAL USAGE

FLOOR PLAN NOTES:

- ALL HEADERS ARE (2) 2x6 w/ 2x4 WALLS OR (3) 2x6 2x6 WALLS, UNLESS OTHERWISE NOTED.
 ALL HEADERS TO HAVE (I) 2x4 OR 2x6 JACK AND KIN STUD EACH END, UNLESS OTHERWISE NOTED.
 MULTI-OPENING HEADERS TO HAVE (2) JACKS AT INTERMEDIATE BEARING, UNLESS OTHERWISE NOTED. NADDITIONAL FLOOR SYSTEM BLOCKING OR CONTINUOU LOAD PATH JACKS ARE REQUIRED UNLESS OTHERWISE NOTED.
- 3. ALL EXTERIOR WALLS TO BE 4" OR 6" AND ALL INTERIOR WALLS TO BE 3 I/2", UNLESS OTHERWISE NOTE!
 4. HATCHED AREAS INDICATE DROPPED CEILINGS. ALL DROPPED CEILINGS ARE I2" UNLESS OTHERWISE NOTED. SEE ARCHITECTURAL DETAIL 8/IT-IB FOR 3/4" FIRE STOPPING AT BULKHEAD / CEILING PANELS
- 5. SEE "BRACED WALL PANEL DETAIL SHEET" FOR SPECIAL WALL FRAMING LOCATIONS AND HEADER SIZES, IF APPLICABLE.
- 6. SEE STANDARD DETAIL CATEGORY "IT" SHEET(S) FOR INTERIOR TRIM DETAILS.
 7. SEE ARCHITECTURAL DETAIL SHEET "AD" FOR HOUSE SPECIFIC INTERIOR TRIM OPTION TABLE.
- 8. ALL HEADERS IN NON-BEARING WALLS SHALL BE A SINGLE FLAT 2X4 OR 2X6 ATTACHED TO CRIPPLES ABOVE, UNLESS OTHERWISE NOTED.
 9. TANKED WATER HEATER SHOWN AS BASE CONDITION,
- OPTIONAL TANKLESS WATER HEATER IS AVAILABLE IN LIEU OF TANKED WATER HEATER.

 10. INTERIOR HEADER HEIGHT FOR 8' CEILING WILL BE 6'-11 9' CEILING WILL BE 7'-11", 10' CEILING WILL BE 8'-3",
- UNLESS OTHERWISE NOTED.

 II. BASEMENT FINISH DIMENSIONS ASSUME A 1/2" GAP BETWEEN FRAME WALL AND CONCRETE WALL.

 I2. ALL INTERIOR BEARING WALLS SHALL HAVE GYPSUM APPLIED TO AT LEAST ONE SIDE OR HAVE MID-HEIGHT BLOCKING INSTALLED.
- 13. NON-BEARING WALLS OVER CONCRETE TO BE HELD 1/2" SHORT OF FRAMING ABOVE.

GYPSUM NOTES:

AT GARAGE:

GYPSUM BOARD AT COMMON WALLS, CEILINGS, BEAM WRAPS AND SUPPORTS PER STANDARD DETAIL **FA-I(b)** FIRE ASSEMBLIES OR AS REQUIRED BY LOCAL CODE.

AT STAIRS:

1/2" GYPSUM BOARD AT UNDERSIDE OF STAIRS AND WALLS IN CLOSET


ROM								
_AB								
1BER					APT. NO.		0	45042
4GE		4			AP		ZIP	
6 m/	1	2-0 0-7 0		RYAN - 0411			STATE	<u>Q</u>
NO OUS SE OTED. L	TINC	DCY-82-04				DRIVE		
OTED. L ED. CIAL	DIV-COMM-LOT-UNIT	П	COMM-LOT	SAWYERS MILL - SIMPLY	STREET ADDRESS	6872 RIVULET DRIVE	CITY	MIDDLETOWN
N, IN '-II",				5-	107			


NVR, Inc. 5285 Westview Drive, Suite 100 Frederick, MD 21703

DRAWN BY
DATE:
OPTION


OOR PLAN

DRAWING TITLE SECOND FLOC

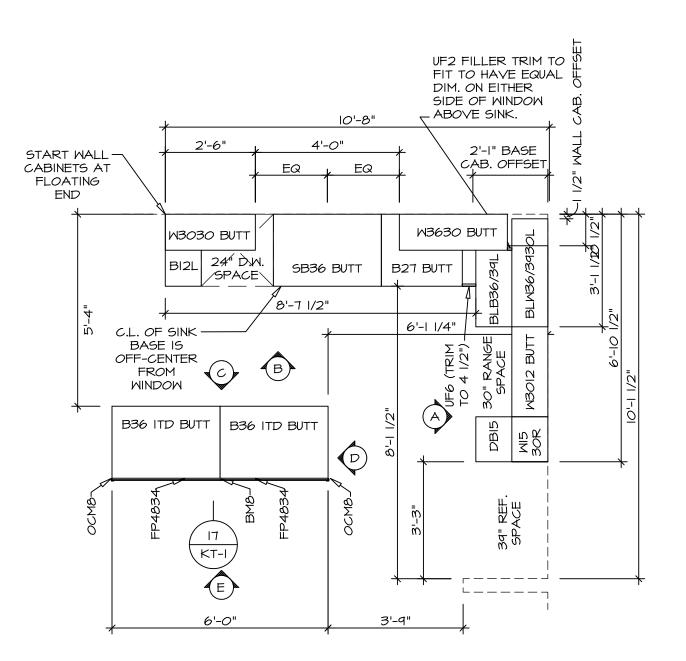

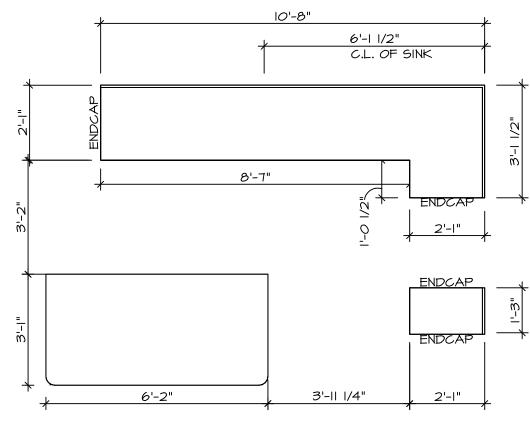

KITCHEN COUNTERTOP PLAN KT-3638

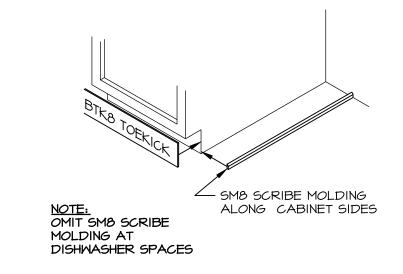

NOTES:
CABINETS ARE NOT REPRESENTATIVE OF ALL
STYLES AND ARE MEANT AS A GENERAL
DEPICTION OF THE INTENDED CABINET LAYOUT

. CABINET LAYOUT (S) ARE BASED ON FINISHED

DIMENSIONS TO DRYWALL.

2. IF KITCHEN PLANS/ELEVATIONS CALL-OUT STANDARD MOLDING, REFER TO STANDARD

DETAIL (II/KT-I) FOR REPLACEMENT BASED ON CABINET STYLE.


3. ALL (UF#) FILLERS ARE TO BE "TRIM TO FIT" UNLESS OTHERWISE NOTED.

AND PLUMB W/ ADJOINING BASE CABINETS.
5. SET PRE-FINISHED SCRIBE MOLDING AT


CABINET BULKHEADS AND AT ENDS (WHERE CABINETS MEET DRYWALL.) PRE-FINISHED SCRIBE MOLDING SHALL BE USED TO PAD OUT CABINET SIDES AT STILE FOR RETURN PIECES OF THE FACE-MOUNTED CABINET CROWN MOLDING.

KITCHEN NOTES:


TOEKICK / SCRIBE DETAIL SCALE: 3/4" = 1'-0"

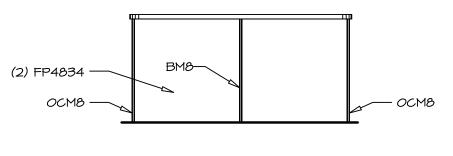


SCALE: 3/8" = 1'-0"

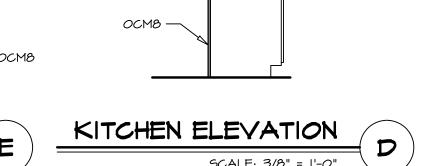



SCALE: 3/8" = 1'-0"

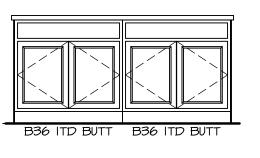

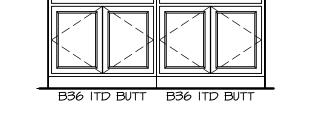




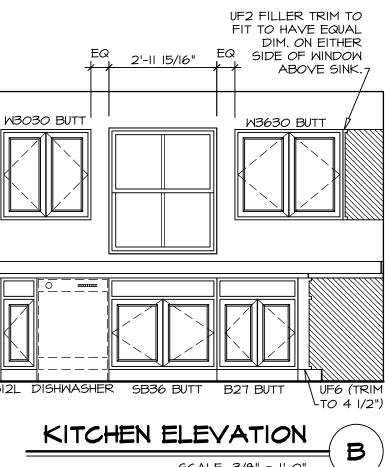


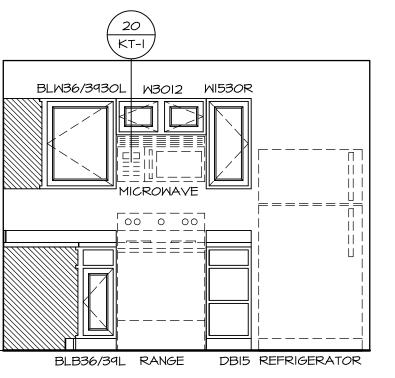


DEDOO/S IE 14 NOE DDIS INCI	TRIOLITY (TOTA
KITCHEN ELEVATION	\triangle
SCALE: 3/8" = 1'-0"	

KITCHEN CABINET PLAN KC-3638

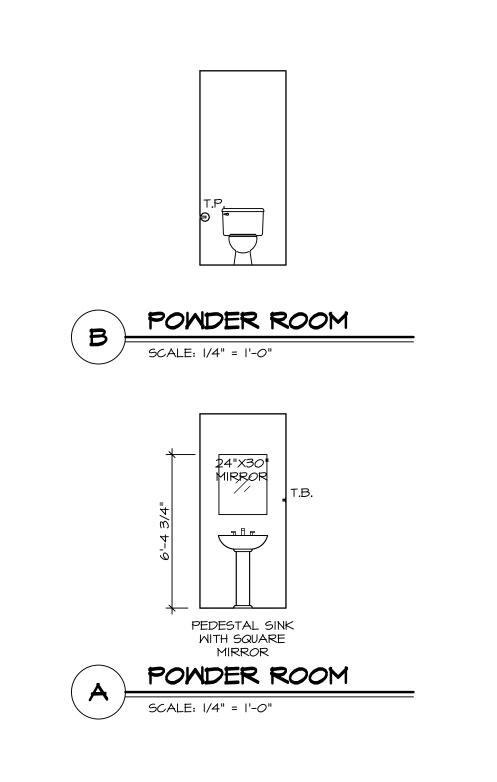


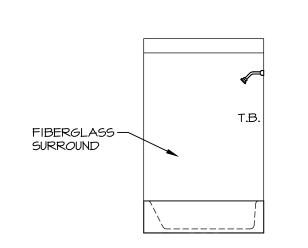




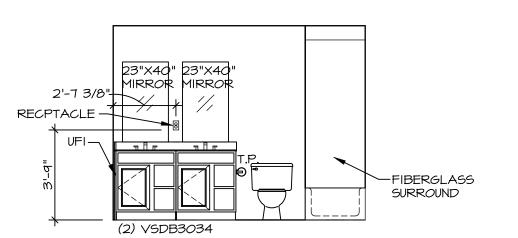



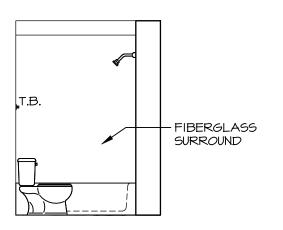



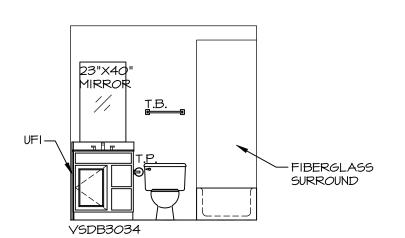

BATH # I
SCALE: 1/4" = 1'-0"

BATH NOTES:

TEMPERED GLASS SHOWER ENCLOSURE WITH SWING DOOR OR OPTIONAL SLIDING DOOR BY DIVISION.
 TUB ACCESS PANELS PROVIDED AS NEEDED, ALL MATERIALS BY DIVISION.
 ALL BATH ELEVATIONS SHOWN PER PLAN.
 ALL VANITIES WITH DRAWERS TO BE SET WITH DRAWERS ON RIGHT HAND SIDE.
 BATH ELEVATIONS ARE SHOWN PER PLAN.
 ALL DIMENSIONS SHOWN ON BATH ELEVATIONS ARE ROUGH FRAMING REFERENCES ONLY.

_		APT. NO.	ZIP
2-04	'AN - 0411		STATE
DCY-52-04	COMM-LOT SAMYERS MILL - SIMPLY RYAN - 0411	STREET ADDRESS 6872 RIVULET DRIVE	CITY
© NVR, Inc., The owner, expressly reserves its copyright and other property rights in these plans. These plans are not	to be reproduced, changed, or copied in any form or manner whatsoever, nor are they to be assigned to any third party, without		
		NVK, Inc. 5285 Westview Drive, Suite 100 Frederick, MD 21703	
SET NO. BRHOO VERSION OI RELEASE NO	DRAWN BY	OPTION	