
S2 412 6870 RIVULET DRIVE MIDDLETOWN, OH 45042

2 Story Basement
2 hose bibs - no valves required
Vent Kitchen
ice maker
1 tub
1 shower
WATER HEATER ELECTRIC 50 GALLON
Inside Water Meter setup

Gas Furnace

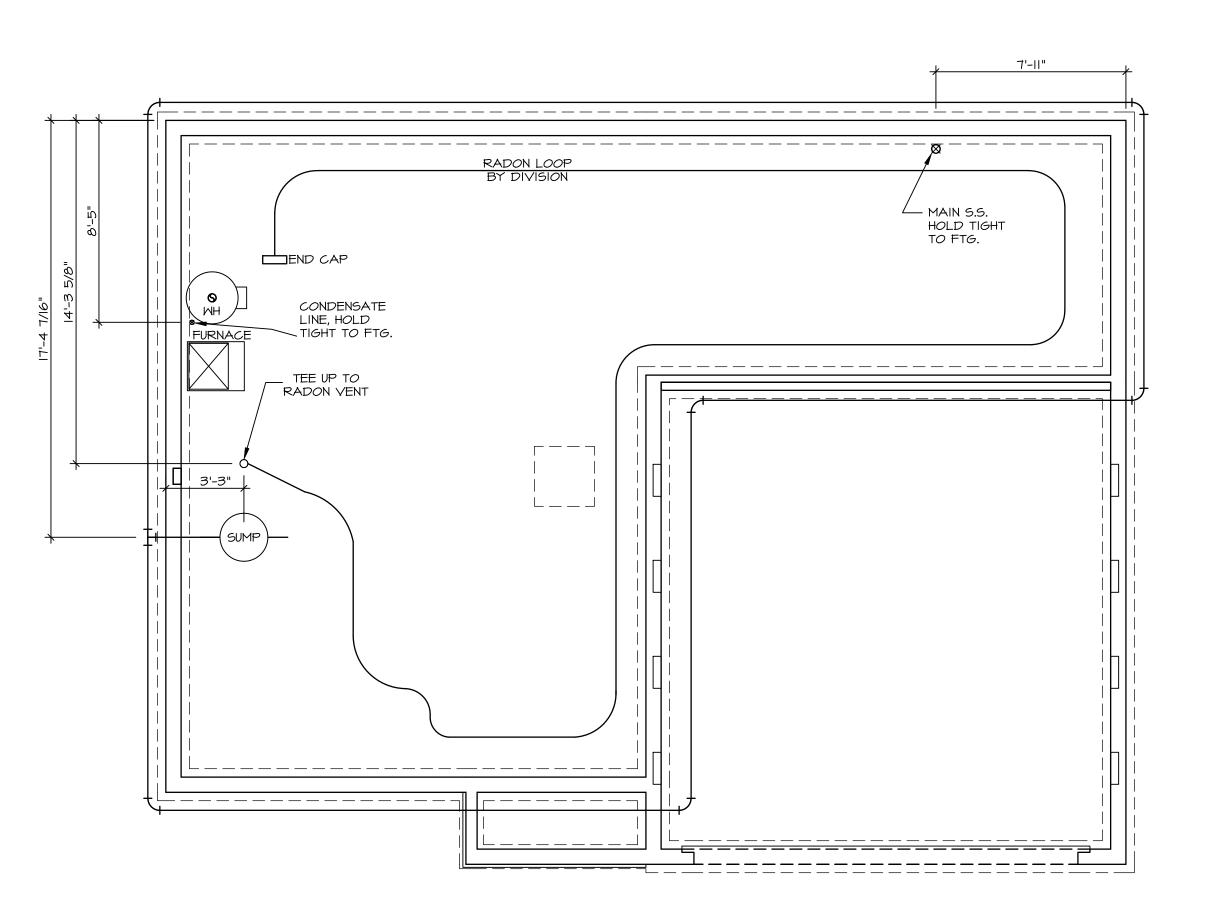



PLUMBING NOTES:

RADON REMEDIATION

RADON LOOP:

- (4") PERFORATED HDPE "LOOP"

- MUST BE PLACED IN STONE BED SLIGHTLY HIGHER THAN ANY INTERIOR DRAINTILE

- LOOP TO BE SEPARATE FROM ANY DRAINTILE ELEMENTS

TO BE CORRUGATED HDPE PIPE

SCREWS TO BE INSTALLED THROUGH LOOP AT TEE UP INTO STACK STACK REQUIREMENTS:


3" PVC STACK (4" IF BASEMENT IS GREATER THAN 2200 SQFT.) NO PART OF STACK IS TO BE HORIZONTAL (45° ELBOWS PERMITTED AS REQUIRED)
PIPE TO BE PHYSICALLY LABELED IN THE FIELD AS "RADON VENT" OR OTHER

JURISDICTIONALLY REQUIRED LANGUAGE (ON EVERY LEVEL OF HOUSE)
ROOF TERMINATION TO BE IN TOP 1/3 OF ROOF


SCREEN OR VENT CAP INSTALLED TO KEEP PESTS OUT OF RADON VENT AT ROOF TERMINATION.

7			APT. NO.	-	ZIP	45042
7CY-52-04 2				STATE	O T	
DIV-COMM-LOT-UNIT	COMM-LOT	SAMYERS MILL - SIMPLY RYAN - 0412	STREET ADDRESS	6870 RIVULET DRIVE	CITY	MIDDLETOWN
its ghts	or or	De De	itten			
©NVR, Inc., The owner, expressly reserves its copyright and other property rights	in these plans. These plans are not to be reproduced, changed, or	whatsoever, nor are they to be	first obtaining the expressed written	consent of NVK, Inc.		
				Frederick, MD 21703		
SET NO. CDROO VERSION OI	RELEASE NO	DATE:	OPTION			
DAR	ING TITLE)	DESCRIPTION			

	BASEMENT JACK SO	CHEDULE	
IDENTIFIER	DESCRIPTION	ENG. NUM.	REMARKS

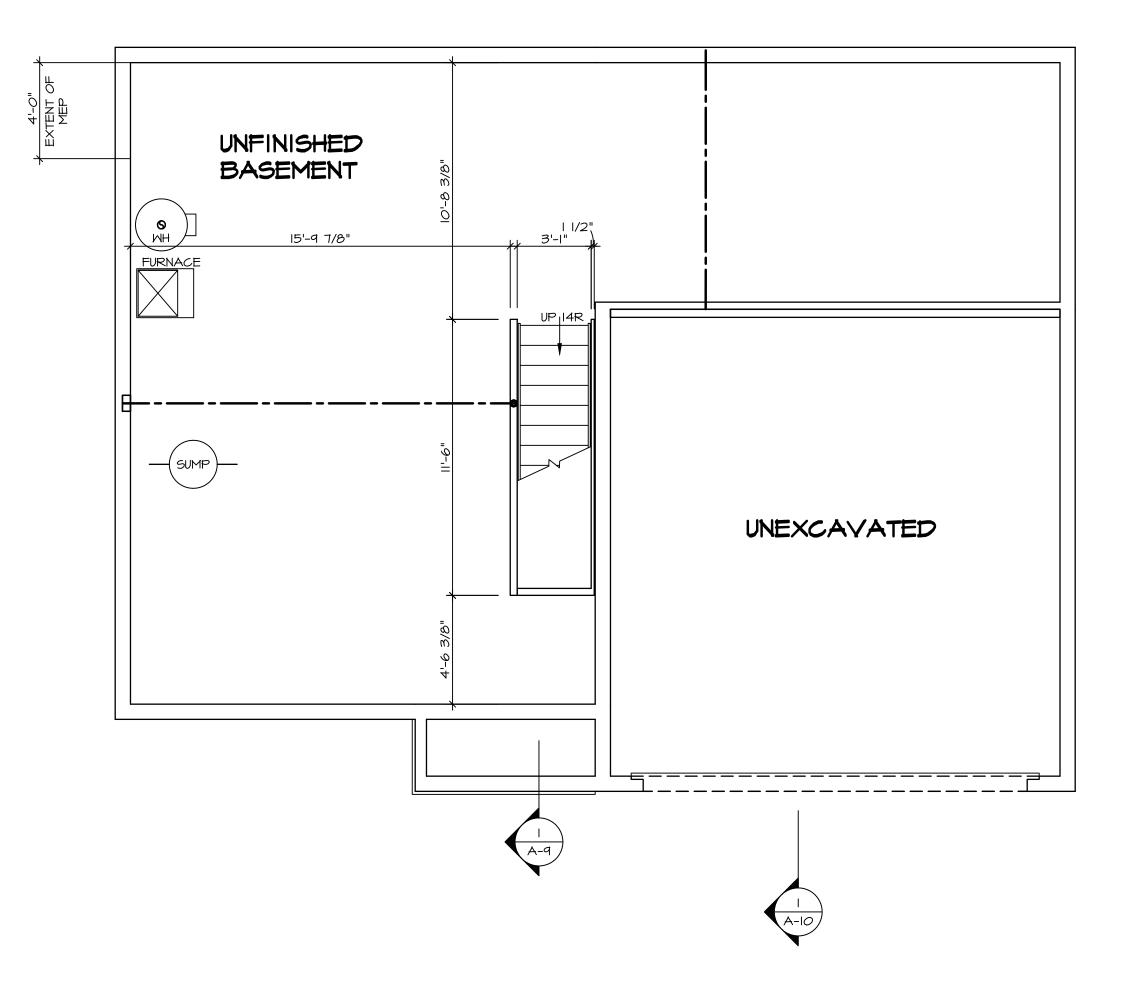



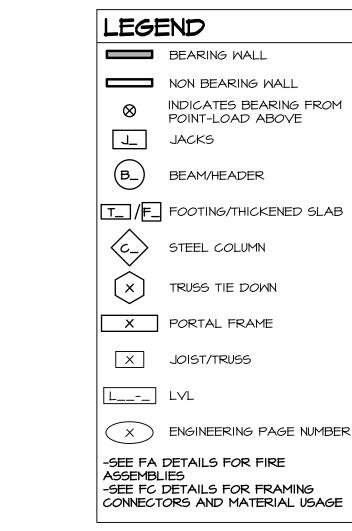

FLOOR PLAN NOTES:

- ALL HEADERS ARE (2) 2x6 w/ 2x4 WALLS OR (3) 2x6 w/ 2x6 WALLS, UNLESS OTHERWISE NOTED.
 ALL HEADERS TO HAVE (I) 2x4 OR 2x6 JACK AND KING STUD EACH END, UNLESS OTHERWISE NOTED. MULTI-OPENING HEADERS TO HAVE (2) JACKS AT INTERMEDIATE BEARING, UNLESS OTHERWISE NOTED. NO ADDITIONAL FLOOR SYSTEM BLOCKING OR CONTINUOUS LOAD PATH JACKS ARE REQUIRED UNLESS OTHERWISE NOTED.
- 3. ALL EXTERIOR WALLS TO BE 4" OR 6" AND ALL INTERIOR WALLS TO BE 3 1/2", UNLESS OTHERWISE NOT ALL INTERIOR WALLS TO BE 3 1/2", UNLESS OTHERWISE NOT DROPPED CEILINGS ARE 12" UNLESS OTHERWISE NOT SEE ARCHITECTURAL DETAIL 8/IT-IB FOR 3/4" FIRE STOPPING AT BULKHEAD / CEILING PANELS
- 5. SEE "BRACED WALL PANEL DETAIL SHEET" FOR SPECIAL WALL FRAMING LOCATIONS AND HEADER SIZES, IF APPLICABLE.

 6. SEE STANDARD DETAIL CATEGORY "IT" SHEET(S) FOR
- 6. SEE STANDARD DETAIL CATEGORY "IT" SHEET(S) FO INTERIOR TRIM DETAILS.7. SEE ARCHITECTURAL DETAIL SHEET "AD" FOR HOUSE
- SPECIFIC INTERIOR TRIM OPTION TABLE.

 8. ALL HEADERS IN NON-BEARING WALLS SHALL BE A SINGLE FLAT 2X4 OR 2X6 ATTACHED TO CRIPPLES
- ABOVE, UNLESS OTHERWISE NOTED.

 9. TANKED WATER HEATER SHOWN AS BASE CONDITIONAL TANKLESS WATER HEATER IS AVAILABLE LIEU OF TANKED WATER HEATER.
- IO. INTERIOR HEADER HEIGHT FOR 8' CEILING WILL BE 6'-I
 9' CEILING WILL BE 7'-II", IO' CEILING WILL BE 8'-3",
 UNLESS OTHERWISE NOTED.
 II. BASEMENT FINISH DIMENSIONS ASSUME A I/2" GAP
- BETWEEN FRAME WALL AND CONCRETE WALL.

 12. ALL INTERIOR BEARING WALLS SHALL HAVE GYPSUM
 APPLIED TO AT LEAST ONE SIDE OR HAVE MID-HEIGHT
 BLOCKING INSTALLED.

 13. NON-BEARING WALLS OVER CONCRETE TO BE HELD 1/2"
- 13. NON-BEARING WALLS OVER CONCRETE TO BE HELD 1/2" SHORT OF FRAMING ABOVE.

GYPSUM NOTES:

AT GARAGE:

GYPSUM BOARD AT COMMON WALLS, CEILINGS, BEAM WRAPS AND SUPPORTS PER STANDARD DETAIL FA-I(b) FIRE ASSEMBLIES OR AS REQUIRED BY LOCAL CODE.

AT STAIRS:

1/2" GYPSUM BOARD AT UNDERSIDE OF STAIRS AND WALLS IN CLOSET


ED SLAB								
E NUMBER IING L USAGE		\sim I			APT. NO.	}	۵	45042
		<u>, , , , , , , , , , , , , , , , , , , </u>			Ā		ZIP	
		4		a				
3) 2x6 w/		0		40				Ç
AND KING			ı Z	ı Z			STATE	
AT TED. NO NTINUOUS HERWISE SE NOTED. ALL NOTED. FIRE	DIV-COMM-LOT-UNIT	DCY-82-04 12		MILL - SIMPLY RYAN - 0412	RESS	6870 RIVULET DRIVE	S	NM
R SPECIAL o, IF	COMM-I		COMM-LOT	SAMYERS MII	STREET ADDRESS	0 ≥×		MIDDLETOWN
5) FOR	DIV-		COMI	₹ S	STRE	68	CITY	$\frac{\Sigma}{7}$
HOUSE					1		1	
BE A PLES								
PITION, ABLE IN								
BE 6'-II", '-3",								
AP								
PSUM -HEIGHT								

NVR, Inc. 5285 Westview Drive, Suite 100 Frederick, MD 21703

SET NO. CDROO
VERSION OI
RELEASE NO. ---DRAWN BY
DATE:
ON
OPTION

DRAWING TITLE
BASEMENT FLOOR PLAN

FIRST FLOOR JACK SCHEDULE						
IDENTIFIER	DESCRIPTION	ENG. NUM.	REMARKS			
IOIL	JACK - (3) 2X4 SPF STUD GRADE	1019				
JIO2	JACK - (2) 2X4 SPF STUD GRADE	1019				
EOIL	JACK - (2) 2X4 SPF STUD GRADE	1014				
JI04	JACK - (2) 2X4 SPF STUD GRADE	1014				
JI <i>0</i> 5	JACK - (2) 2X4 SPF STUD GRADE	1012				
JI06	JACK - (4) 2X4 SP#I	1025				
10IC	JACK - (4) 2X4 SP#I	1025				
80IL	JACK - (2) 2X4 SPF STUD GRADE	1008				
POIL	JACK - (2) 2X4 SPF STUD GRADE	1008				
SIL OI	JACK - (2) 2X4 SPF STUD GRADE	1010				
<u></u>	JACK - (2) 2X4 SPF STUD GRADE	1010				
JII2	JACK - (4) 2X4 SPF STUD GRADE	1006				
SIL	JACK - (4) 2X4 SPF STUD GRADE	1006				
JII4	JACK - (4) 2X4 SPF STUD GRADE	1006				
ZIIL ZIIL	JACK - (4) 2X4 SPF STUD GRADE	1006				

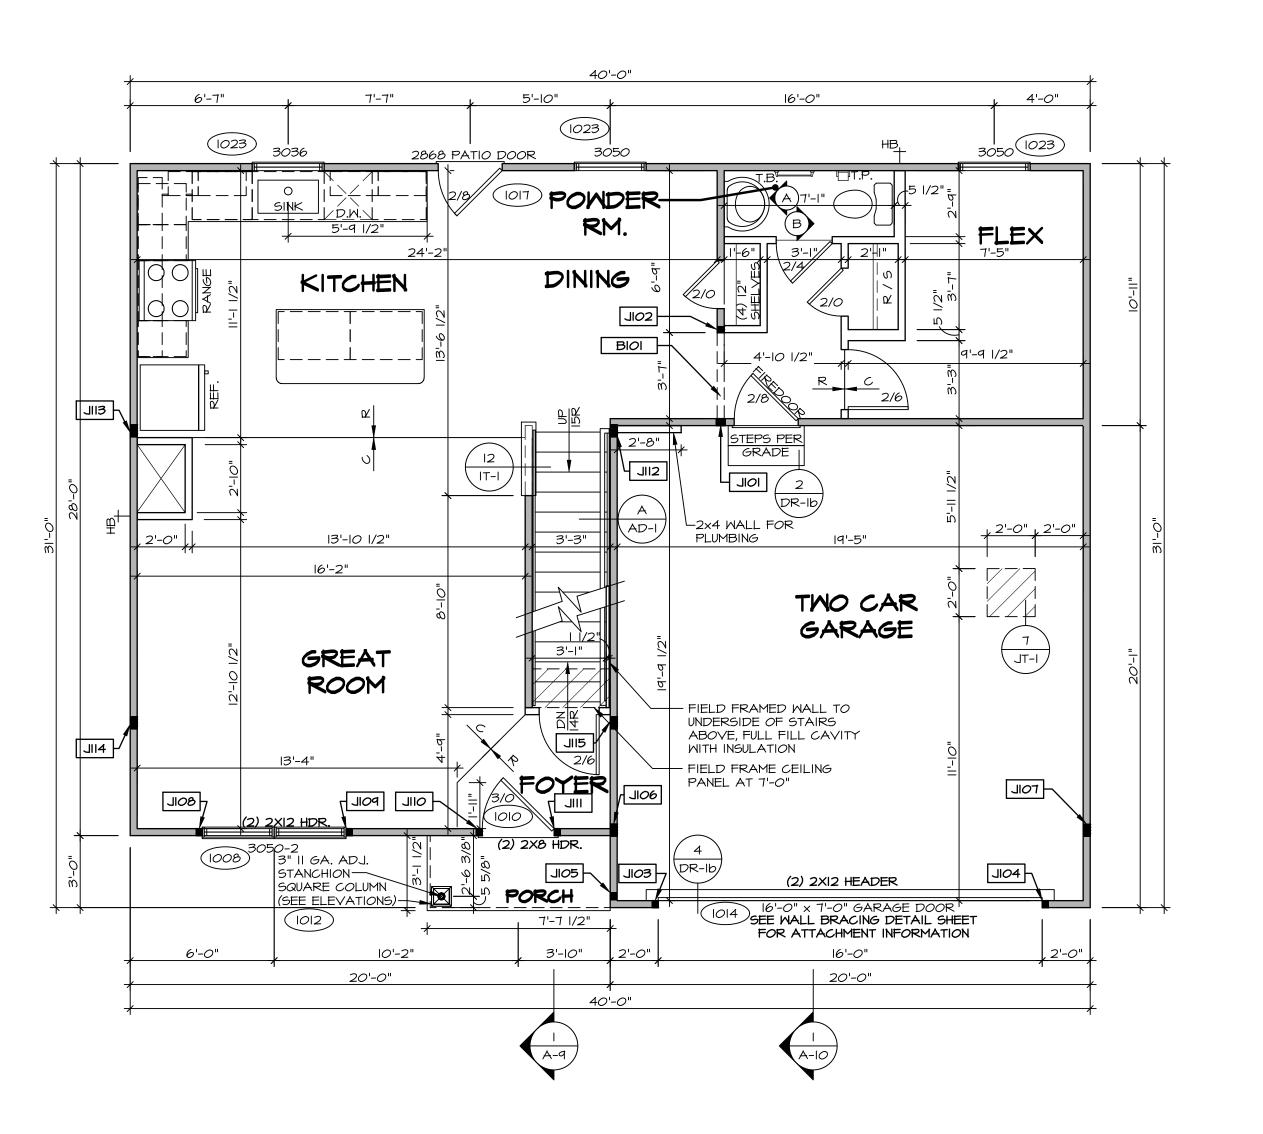



LEGE	IND
	BEARING WALL
	NON BEARING WALL
\otimes	INDICATES BEARING FROM POINT-LOAD ABOVE
J_	JACKS
B_	BEAM/HEADER
T_ /F_	FOOTING/THICKENED SLAB
⟨c_>	STEEL COLUMN
$\stackrel{\times}{\bigcirc}$	TRUSS TIE DOWN
X	PORTAL FRAME
X	JOIST/TRUSS
L	LVL
X	ENGINEERING PAGE NUMBER
ASSEMBL -SEE FC 1	DETAILS FOR FIRE IES DETAILS FOR FRAMING ORS AND MATERIAL USAGE

FLOOR PLAN NOTES:

- ALL HEADERS ARE (2) 2x6 w/ 2x4 WALLS OR (3) 2x6 w/ 2x6 WALLS, UNLESS OTHERWISE NOTED.
 ALL HEADERS TO HAVE (I) 2x4 OR 2x6 JACK AND KING STUD EACH END, UNLESS OTHERWISE NOTED.
 MULTI-OPENING HEADERS TO HAVE (2) JACKS AT INTERMEDIATE BEARING, UNLESS OTHERWISE NOTED. NO ADDITIONAL FLOOR SYSTEM BLOCKING OR CONTINUOUS LOAD PATH JACKS ARE REQUIRED UNLESS OTHERWISE NOTED.
- 3. ALL EXTERIOR WALLS TO BE 4" OR 6" AND ALL INTERIOR WALLS TO BE 3 I/2", UNLESS OTHERWISE NOTE 4. HATCHED AREAS INDICATE DROPPED CEILINGS. ALL DROPPED CEILINGS ARE I2" UNLESS OTHERWISE NOTED. SEE ARCHITECTURAL DETAIL 8/IT-IB FOR 3/4" FIRE STOPPING AT BULKHEAD / CEILING PANELS
- 5. SEE "BRACED WALL PANEL DETAIL SHEET" FOR SPECIAL WALL FRAMING LOCATIONS AND HEADER SIZES, IF APPLICABLE.
 6. SEE STANDARD DETAIL CATEGORY "IT" SHEET(S) FOR
- 9. SEE STANDARD DETAIL CATEGORT TO SHEET (9) FOR INTERIOR TRIM DETAILS.
 7. SEE ARCHITECTURAL DETAIL SHEET "AD" FOR HOUSE SPECIFIC INTERIOR TRIM OPTION TABLE.
- 8. ALL HEADERS IN NON-BEARING WALLS SHALL BE A SINGLE FLAT 2X4 OR 2X6 ATTACHED TO CRIPPLES ABOVE, UNLESS OTHERWISE NOTED.
 9. TANKED WATER HEATER SHOWN AS BASE CONDITION OPTIONAL TANKLESS WATER HEATER IS AVAILABLE
- LIEU OF TANKED WATER HEATER.

 10. INTERIOR HEADER HEIGHT FOR 8' CEILING WILL BE 6'9' CEILING WILL BE 7'-11", 10' CEILING WILL BE 8'-3",
 UNLESS OTHERWISE NOTED.
- II. BASEMENT FINISH DIMENSIONS ASSUME A 1/2" GAP
 BETWEEN FRAME WALL AND CONCRETE WALL.

 12. ALL INTERIOR BEARING WALLS SHALL HAVE GYPSUM
 APPLIED TO AT LEAST ONE SIDE OR HAVE MID-HEIG
- BLOCKING INSTALLED.

 13. NON-BEARING WALLS OVER CONCRETE TO BE HELI SHORT OF FRAMING ABOVE.

GYPSUM NOTES:

AT GARAGE:

A | GAKAGE:

GYPSUM BOARD AT COMMON WALLS, CEILINGS, BEAM

WRAPS AND SUPPORTS PER STANDARD DETAIL FA-I(b)

FIRE ASSEMBLIES OR AS REQUIRED BY LOCAL CODE.

AT STAIRS:


1/2" GYPSUM BOARD AT UNDERSIDE OF STAIRS AND WALLS
IN CLOSET

30 VE								
ENED SLAB								
N								
=								
AGE NUMBER								
RE						ON		
RAMING RIAL USAGE			N			APT.	·	ZIP
			4		SIMPLY RYAN - 0412			
R (3) 2x6 w/			Ò					
K AND KING								STATE
S AT NOTED. NO CONTINUOUS OTHERWISE			-52-0412		PLY RY			
ALL RWISE NOTED. GS. ALL IISE NOTED. 4" FIRE		DIV-COMM-LOT-UNIT	ロの人		1	RESS	6870 RIVULET DRIVE	
FOR SPECIAL ZES, IF		OMM-L		-L0T	SAMYERS MILL	STREET ADDRESS	Ø ≥	
ET(S) FOR		N-C		COMM-LOT	SAN.	STREE	5870	CITY
R HOUSE						107		
L BE A XIPPLES								
ONDITION, AILABLE IN								
LL BE 6'-11", E 8'-3",								
" GAP 								
GYPSUM 1ID-HEIGHT			s s ±		- w ±			
E HELD 1/2"						written		
			reser ropert) plans	chang	they	the expressed		
			ressly her p	ed,	are fire	e exp	κ, Inc.	
DE 4.54			exp ot	ğ	פיקי	۽ ۽	r.	

NVR, Inc.
5285 Westview Drive, Suite 100
Frederick, MD 21703

SET NO. CDROO
VERSION OI
RELEASE NO. ---DRAWN BY
DATE:
OPTION

DRAWING TITLE
FIRST FLOOR PLAN
OPTION DESCRIPTION

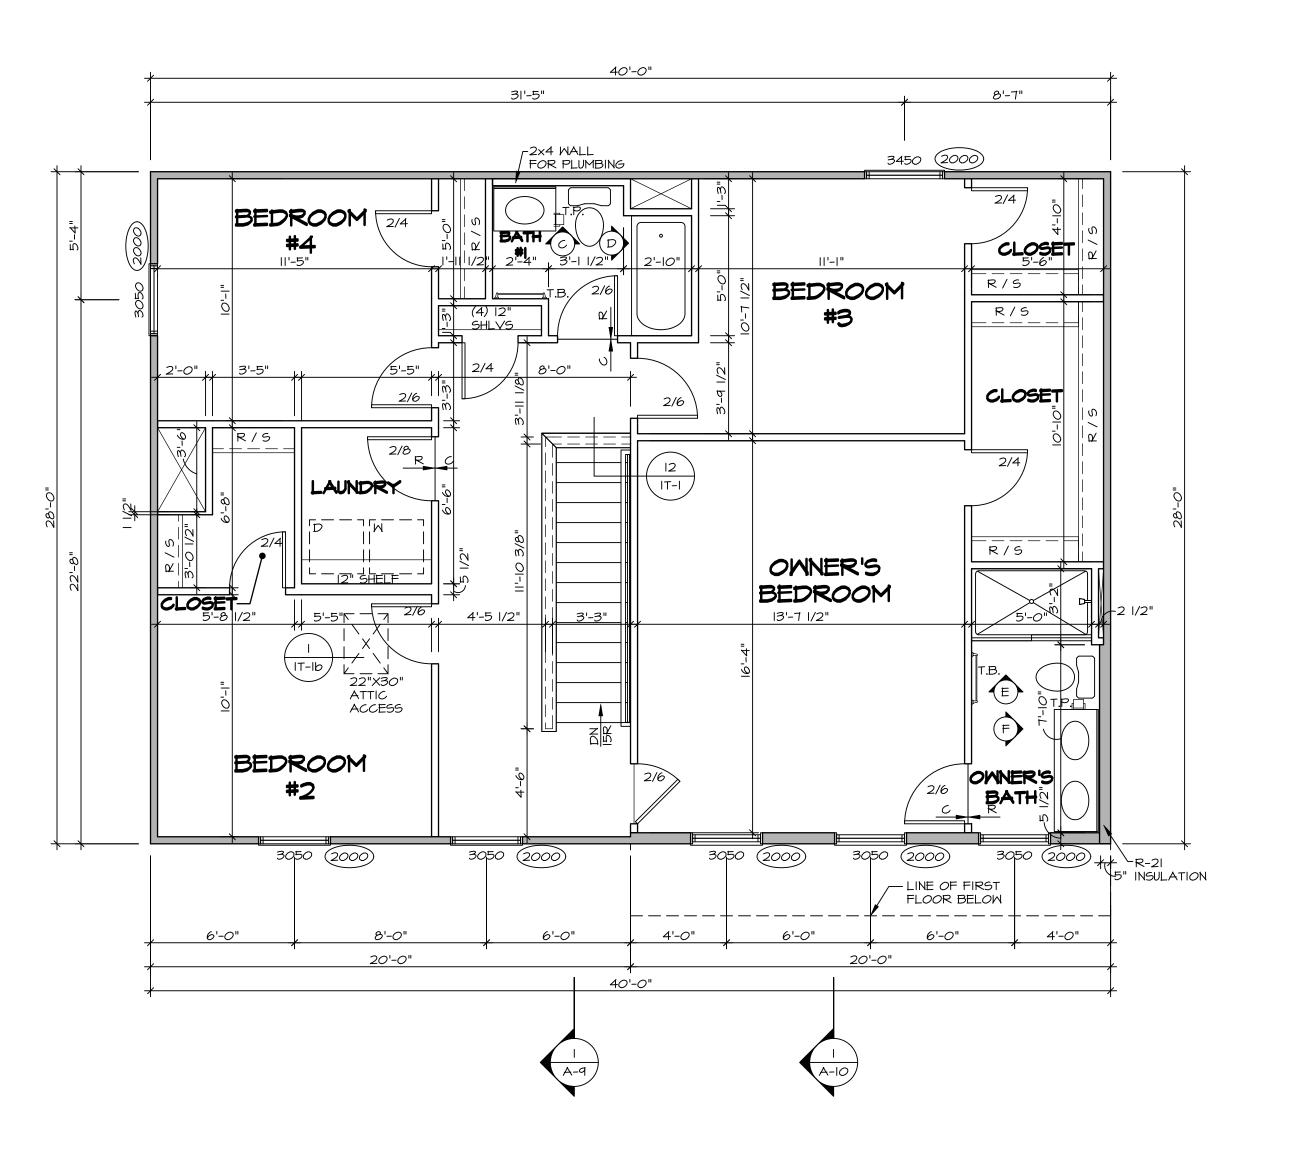



	LEGE	ND .
		BEARING WALL
		NON BEARING WALL
	⊗	INDICATES BEARING FROM POINT-LOAD ABOVE JACKS
	B_	BEAM/HEADER
	T/F_	FOOTING/THICKENED SLAB
	$\langle c \rangle$	STEEL COLUMN
	\times	TRUSS TIE DOWN
	X	PORTAL FRAME
	X	JOIST/TRUSS
	L	LYL
	X	ENGINEERING PAGE NUMBER
	ASSEMBL -SEE FC	DETAILS FOR FIRE IES DETAILS FOR FRAMING ORS AND MATERIAL USAGE
000 0	A S I S I A	

FLOOR PLAN NOTES:

- ALL HEADERS ARE (2) 2x6 w/ 2x4 WALLS OR (3) 2x6 w/ 2x6 WALLS, UNLESS OTHERWISE NOTED. 2. ALL HEADERS TO HAVE (1) 2x4 OR 2x6 JACK AND KING STUD EACH END, UNLESS OTHERWISE NOTED. MULTI-OPENING HEADERS TO HAVE (2) JACKS AT INTERMEDIATE BEARING, UNLESS OTHERWISE NOTED. NO ADDITIONAL FLOOR SYSTEM BLOCKING OR CONTINUOUS LOAD PATH JACKS ARE REQUIRED UNLESS OTHERWISE
- 3. ALL EXTERIOR WALLS TO BE 4" OR 6" AND ALL INTERIOR WALLS TO BE 3 1/2", UNLESS OTHERWISE NOTED. HATCHED AREAS INDICATE DROPPED CEILINGS. ALL DROPPED CEILINGS ARE 12" UNLESS OTHERWISE NOTED. SEE ARCHITECTURAL DETAIL 8/IT-IB FOR 3/4" FIRE STOPPING AT BULKHEAD / CEILING PANELS
- . SEE "BRACED WALL PANEL DETAIL SHEET" FOR SPECIAL WALL FRAMING LOCATIONS AND HEADER SIZES, IF APPLICABLE. . SEE STANDARD DETAIL CATEGORY "IT" SHEET(S) FOR
- INTERIOR TRIM DETAILS.
 SEE ARCHITECTURAL DETAIL SHEET "AD" FOR HOUSE SPECIFIC INTERIOR TRIM OPTION TABLE.
- 3. ALL HEADERS IN NON-BEARING WALLS SHALL BE A SINGLE FLAT 2X4 OR 2X6 ATTACHED TO CRIPPLES ABOVE, UNLESS OTHERWISE NOTED. . TANKED WATER HEATER SHOWN AS BASE CONDITION, OPTIONAL TANKLESS WATER HEATER IS AVAILABLE IN
- LIEU OF TANKED WATER HEATER. 10. INTERIOR HEADER HEIGHT FOR 8' CEILING WILL BE 6'-II", 9' CEILING WILL BE 7'-II", 10' CEILING WILL BE 8'-3", UNLESS OTHERWISE NOTED.
- II. BASEMENT FINISH DIMENSIONS ASSUME A 1/2" GAP BETWEEN FRAME WALL AND CONCRETE WALL.

 12. ALL INTERIOR BEARING WALLS SHALL HAVE GYPSUM APPLIED TO AT LEAST ONE SIDE OR HAVE MID-HEIGHT
- BLOCKING INSTALLED. 13. NON-BEARING WALLS OVER CONCRETE TO BE HELD 1/2" SHORT OF FRAMING ABOVE.


GYPSUM NOTES:

AT GARAGE:


GYPSUM BOARD AT COMMON WALLS, CEILINGS, BEAM WRAPS AND SUPPORTS PER STANDARD DETAIL FA-I(b) FIRE ASSEMBLIES OR AS REQUIRED BY LOCAL CODE.

AT STAIRS:


1/2" GYPSUM BOARD AT UNDERSIDE OF STAIRS AND WALLS IN CLOSET

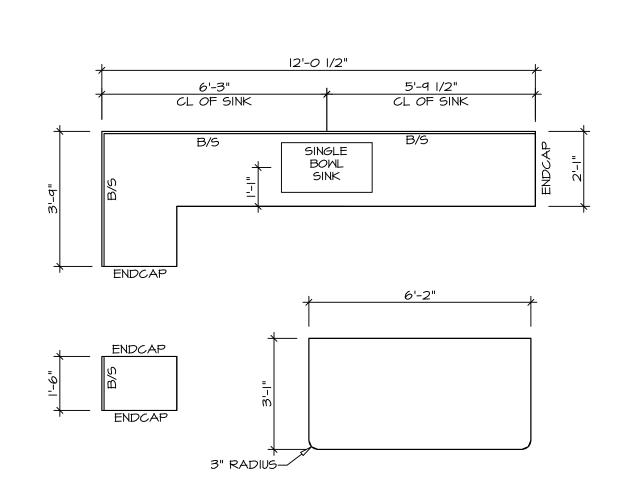

KITCHEN COUNTERTOP PLAN KC - 3640

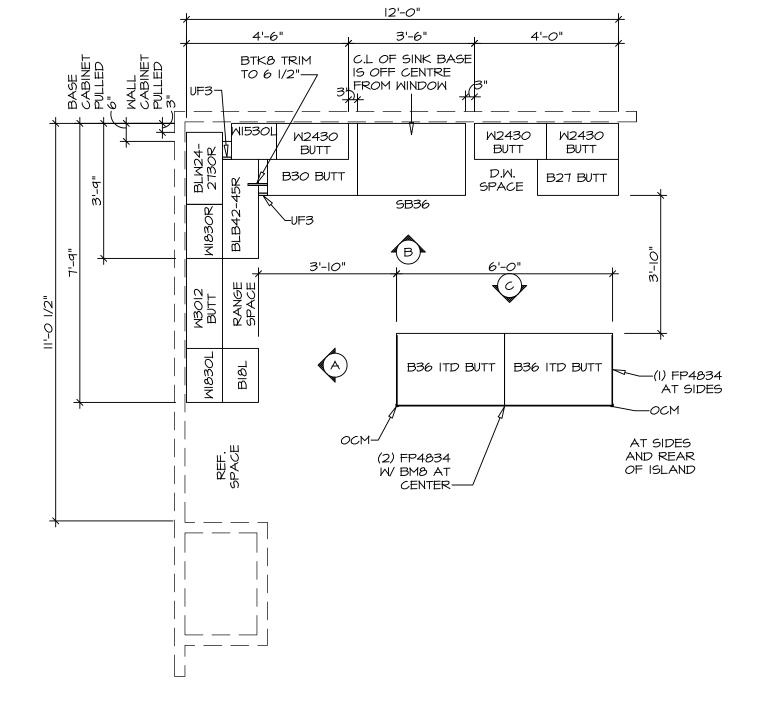


KITCHEN CABINET PLAN KC - 3640 SCALE: 3/8" = 1'-0"

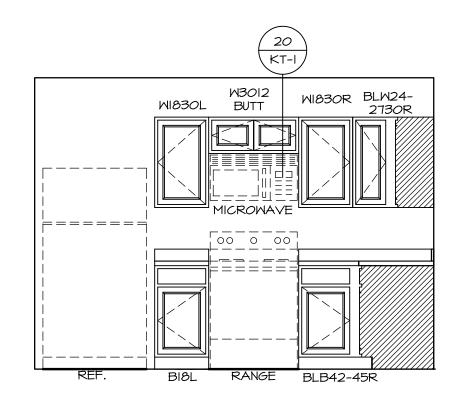


SCALE: 3/8" = 1'-0"



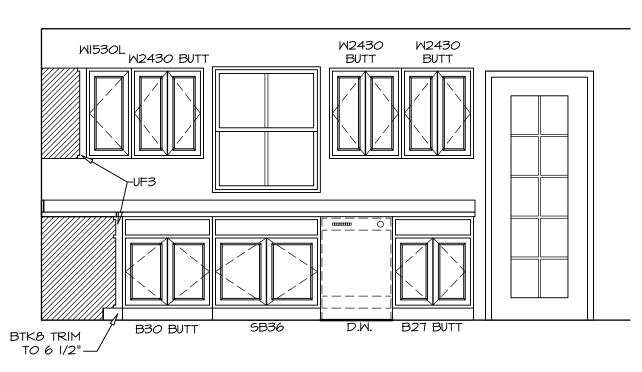



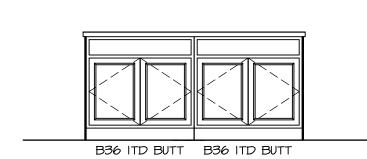



KITCHEN NOTES:

I. CABINET LAYOUT (S) ARE BASED ON FINISHED DIMENSIONS TO DRYWALL.


2. IF KITCHEN PLANS/ELEVATIONS CALL-OUT STANDARD MOLDING, REFER TO STANDARD DETAIL (II/KT-I) FOR REPLACEMENT BASED ON CABINET STYLE.

3. ALL (UF#) FILLERS ARE TO BE "TRIM TO FIT"

UNLESS OTHERWISE NOTED.


4. CABINET MUST BE SET, SHIMMED, LEVELED AND PLUMB W/ ADJOINING BASE CABINETS. 5. SET PRE-FINISHED SCRIBE MOLDING AT
CABINET BULKHEADS AND AT ENDS (WHERE
CABINETS MEET DRYWALL.) PRE-FINISHED=
SCRIBE MOLDING SHALL BE USED TO PAD OUT CABINET SIDES AT STILE FOR RETURN PIECES OF THE FACE-MOUNTED CABINET CROWN MOLDING.

NOTES:
CABINETS ARE NOT REPRESENTATIVE OF ALL
STYLES AND ARE MEANT AS A GENERAL
DEPICTION OF THE INTENDED CABINET LAYOUT

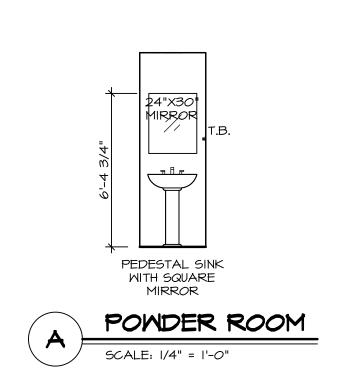






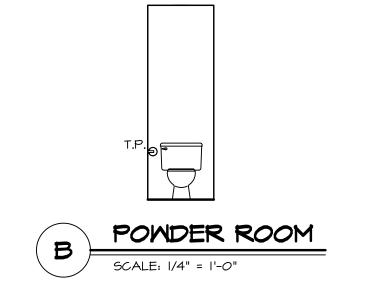




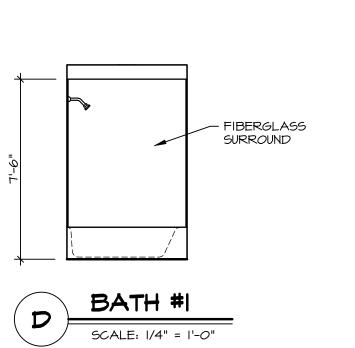

BATH NOTES:

TEMPERED GLASS SHOWER ENCLOSURE WITH SWING DOOR OR OPTIONAL SLIDING DOOR BY DIVISION.
 TUB ACCESS PANELS PROVIDED AS NEEDED, ALL MATERIALS BY DIVISION.
 ALL BATH ELEVATIONS SHOWN PER PLAN.
 ALL VANITIES WITH DRAWERS TO BE SET WITH DRAWERS ON RIGHT HAND SIDE.
 BATH ELEVATIONS ARE SHOWN PER PLAN.
 ALL DIMENSIONS SHOWN ON BATH ELEVATIONS ARE ROUGH FRAMING REFERENCES ONLY.

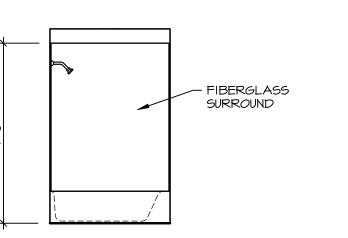

23"X40" MIRROR

BATH #I

SCALE: 1/4" = 1'-0"

FIBERGLASS SURROUND