S2 418 6856 RIVULET DRIVE MIDDLETOWN, OH 45042

2 Story Basement - 3 pc rough

3 bath house

2 hose bibs - no valves required

Vent Kitchen


ice maker

2 tubs

1 shower

WATER HEATER ELECTRIC 50 GALLON Inside Water Meter setup

Gas Furnace and range

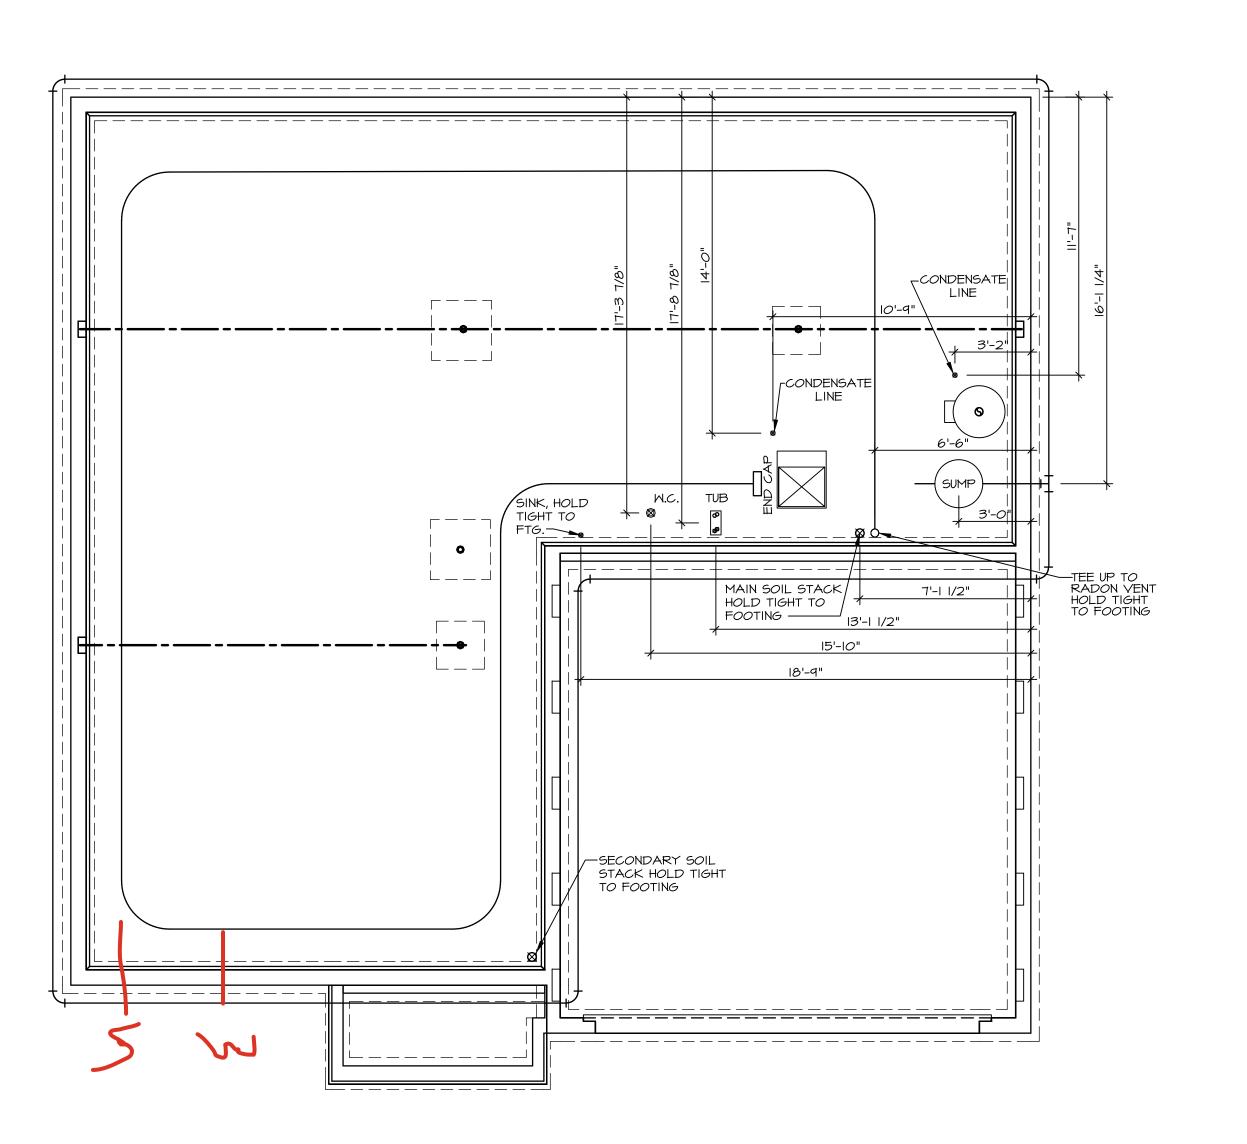



PLUMBING NOTES: RADON REMEDIATION

RADON REMEDIATION
RADON LOOP:

- (4") PERFORATED HDPE "LOOP"

- MUST BE PLACED IN STONE BED SLIGHTLY HIGHER THAN ANY INTERIOR DRAINTILE

- LOOP TO BE SATER LIDDE BIDE

TO BE CORRUGATED HDPE PIPE

- SCREWS TO BE INSTALLED THROUGH LOOP AT TEE UP INTO STACK

STACK REQUIREMENTS:


- 3" PVC STACK (4" IF BASEMENT IS GREATER THAN 2200 SQFT.)


NO PART OF STACK IS TO BE HORIZONTAL (45° ELBOWS PERMITTED AS REQUIRED)

PIPE TO BE PHYSICALLY LABELED IN THE FIELD AS "RADON VENT" OR OTHER JURISDICTIONALLY REQUIRED LANGUAGE (ON EVERY LEVEL OF HOUSE)

ROOF TERMINATION TO BE IN TOP 1/3 OF ROOF SCREEN OR VENT CAP INSTALLED TO KEEP PESTS OUT OF RADON VENT AT ROOF TERMINATION.

a		APT. NO.	ZIP 45042
7-UNIT	PLY RYAN - 0418		STATE
DIV-COMM-LOT-UNIT	COMM-LOT SAWYERS MILL - SIMPLY RYAN - 0418	STREET ADDRESS 6856 RIVULET DRIVE	CITY MIDDLETOWN
© NVR, Inc., The owner, expressly reserves its copyright and other property rights	to be reproduced, changed, or copied in any form or manner whatsoever, nor are they to be	ussigned to any finite party, without first obtaining the expressed written consent of NVR, Inc.	
© NVR, Inc., The owner, copyright an	to be re copied in whatsoever		
		NVR, Inc. 5285 Westview Drive, Suite 100 Frederick, MD 21703	
SET NO. HZLOO VERSION OI	DRAWN BY DATE:	OPTION	
MODEL HAZEL	DRAWING HILE	OPTION DESCRIPTION	

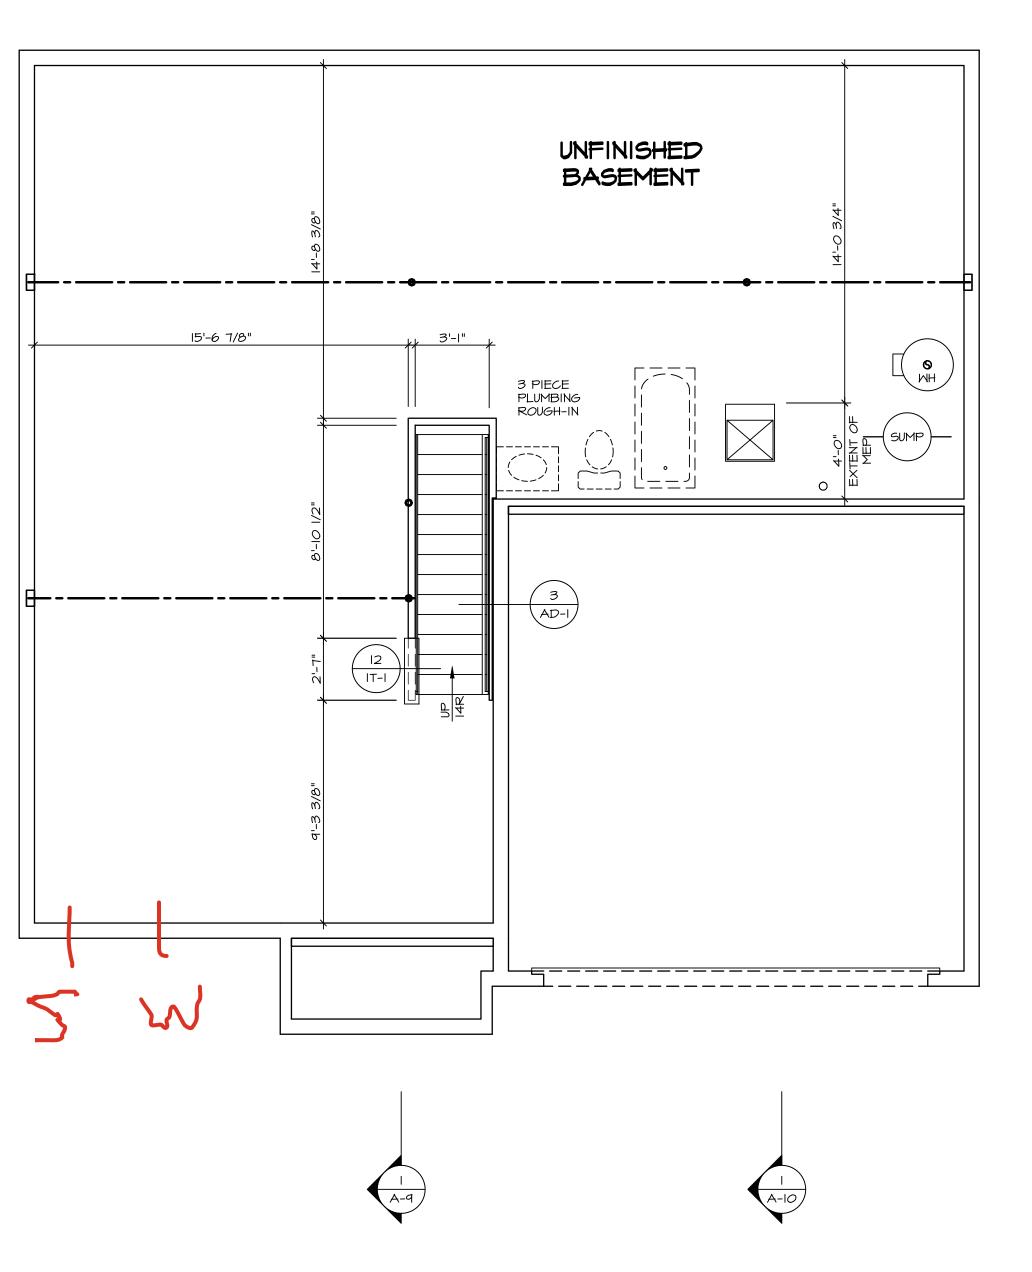

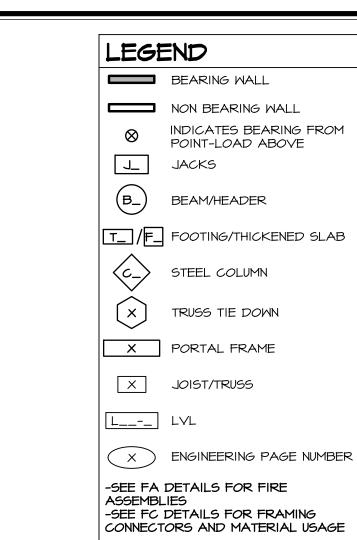

FLOOR PLAN NOTES:

- ALL HEADERS ARE (2) 2x6 w/ 2x4 WALLS OR (3) 2x6 w/ 2x6 WALLS, UNLESS OTHERWISE NOTED. ALL HEADERS TO HAVE (1) 2x4 OR 2x6 JACK AND KING STUD EACH END, UNLESS OTHERWISE NOTED. MULTI-OPENING HEADERS TO HAVE (2) JACKS AT INTERMEDIATE BEARING, UNLESS OTHERWISE NOTED. NO ADDITIONAL FLOOR SYSTEM BLOCKING OR CONTINUOUS LOAD PATH JACKS ARE REQUIRED UNLESS OTHERWISE NOTED.
- ALL EXTERIOR WALLS TO BE 4" OR 6" AND ALL INTERIOR WALLS TO BE 3 I/2", UNLESS OTHERWISE NOTED.

 1. HATCHED AREAS INDICATE DROPPED CEILINGS. ALL
 DROPPED CEILINGS ARE I2" UNLESS OTHERWISE NOTED. SEE ARCHITECTURAL DETAIL 8/IT-IB FOR 3/4" FIRE STOPPING AT BULKHEAD / CEILING PANELS
- SEE "BRACED WALL PANEL DETAIL SHEET" FOR SPECIAL WALL FRAMING LOCATIONS AND HEADER SIZES, IF APPLICABLE. 5. SEE STANDARD DETAIL CATEGORY "IT" SHEET(S) FOR INTERIOR TRIM DETAILS.
- . SEE ARCHITECTURAL DETAIL SHEET "AD" FOR HOUSE SPECIFIC INTERIOR TRIM OPTION TABLE.
- 5PECIFIC INTERIOR TRIM OPTION TABLE.

 8. ALL HEADERS IN NON-BEARING WALLS SHALL BE A SINGLE FLAT 2X4 OR 2X6 ATTACHED TO CRIPPLES ABOVE, UNLESS OTHERWISE NOTED.

 1. TANKED WATER HEATER SHOWN AS BASE CONDITION, OPTIONAL TANKLESS WATER HEATER IS AVAILABLE IN LIEU OF TANKED WATER HEATER. D. INTERIOR HEADER HEIGHT FOR 8' CEILING WILL BE 6'-II",
- 9' CEILING WILL BE 7'-11", 10' CEILING WILL BE 8'-3", UNLESS OTHERWISE NOTED. BASEMENT FINISH DIMENSIONS ASSUME A 1/2" GAP BETWEEN FRAME WALL AND CONCRETE WALL. 2. ALL INTERIOR BEARING WALLS SHALL HAVE GYPSUM APPLIED TO AT LEAST ONE SIDE OR HAVE MID-HEIGHT
- BLOCKING INSTALLED. 13. NON-BEARING WALLS OVER CONCRETE TO BE HELD 1/2" SHORT OF FRAMING ABOVE.

GYPSUM NOTES:

AT GARAGE:

GYPSUM BOARD AT COMMON WALLS, CEILINGS, BEAM WRAPS AND SUPPORTS PER STANDARD DETAIL **FA-I(b)** FIRE ASSEMBLIES OR AS REQUIRED BY LOCAL CODE.

AT STAIRS:

1/2" GYPSUM BOARD AT UNDERSIDE OF STAIRS AND WALLS IN CLOSET

© NVR, I The ow copyrigh in these to be copied whatsoev assigned first obt
NVR, Inc. 5285 Westview Drive, Suite 100 Frederick, MD 21703


				52		
VERSION O	RELEASE NO	DRAWN BY	DATE:	OPTION		

BASEMENT FLOOR PLAN SCALE: 1/4" = 1'-0"


FIRST FLOOR JACK SCHEDULE				
IDENTIFIER	DESCRIPTION	ENG. NUM.	REMARKS	
IOIL	JACK - (4) 2X4 SP#I	1014		
JI02	JACK - (4) 2X4 SP#I	1014		
JI06	JACK - (2) 2X4 SPF STUD GRADE	1021		
TOIL	JACK - (2) 2X4 SPF STUD GRADE	1002		
80IL	JACK - (2) 2X4 SPF STUD GRADE	1004		
OIIL	JACK - (2) 2X4 SPF STUD GRADE	1006		
IIL	JACK - (2) 2X4 SPF STUD GRADE	1008		
EIIL	JACK - (2) 2X4 SPF STUD GRADE	1027		
JII4	JACK - (2) 2X4 SPF STUD GRADE	1027		
JII5	JACK - (5) 2X4 SPF STUD GRADE	2004		
1116	JACK - (2) 2X4 SPF STUD GRADE	1021		
JI20	JACK - (2) 2X4 SPF STUD GRADE	1019		
JI2I	JACK - (2) 2X4 SPF STUD GRADE	1019		
JI24	JACK - (5) 2X6 SP#I	1012		
JI25	JACK - (5) 2X4 SP#I	1012		
JI26	JACK - (5) 2X6 SP#I	2004		

FIELD	INSTALLED FIRST FL	OOR BEAM/	HEADER	SCHEDULE
IDENTIFIER	DESCRIPTION	LENGTH	ENG. NUM.	REMARKS

STEEL COLUMN SCHEDULE				
IDENTIFIER	STYLE	HEIGHT	ENG. NUM.	REMARKS
CIOI	STANCHION PORCH - 3 IN DIA IIGA ADJ	8'-9 3/8"	1019	FBA, FCA
CIO2	STANCHION PORCH - 3 IN DIA IIGA ADJ	8'-9 3/8"	1019	FBA, FCA

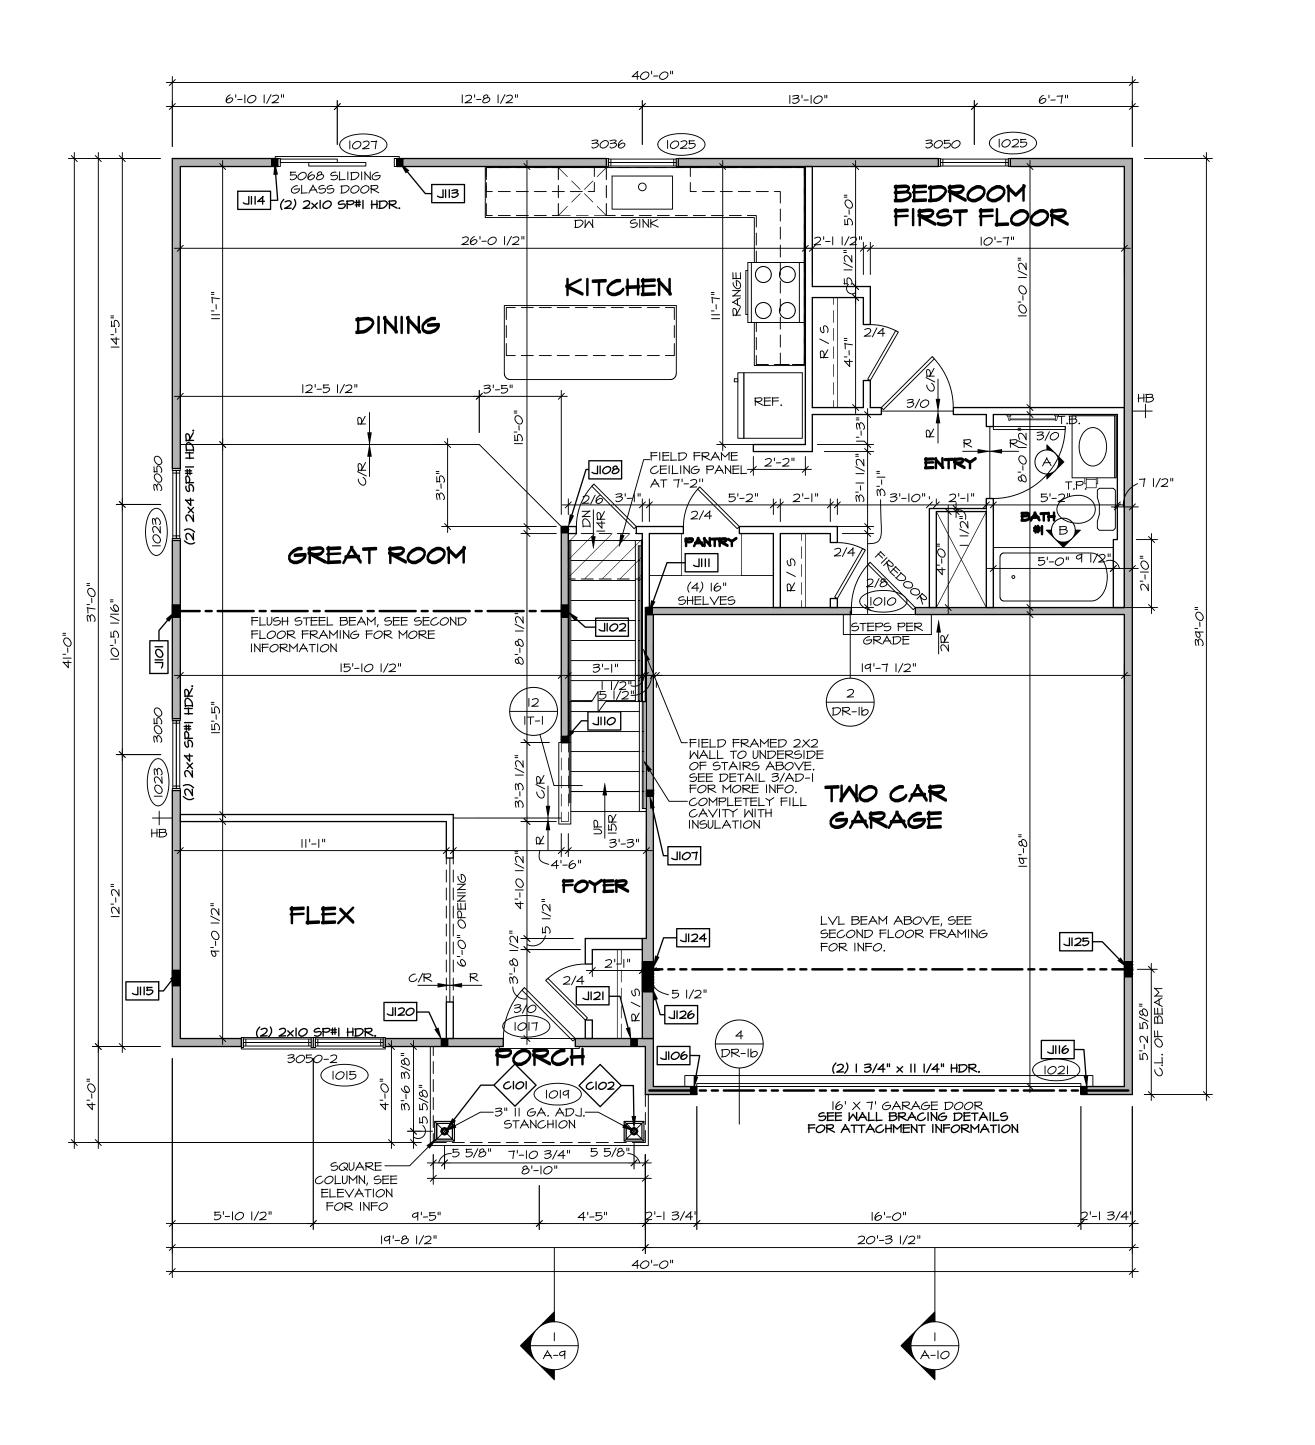



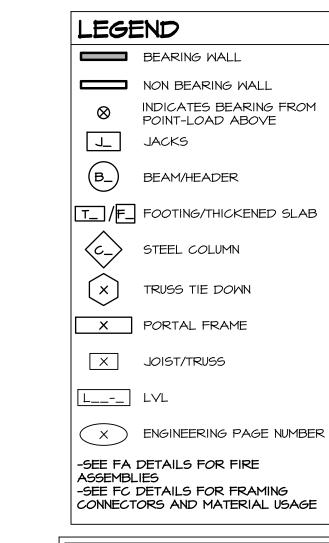

ALL WINDOWS HAVE 7'-0 I/2" HEADER HEIGHT UNLESS OTHERWISE NOTED

FLOOR PLAN NOTES:

- ALL HEADERS ARE (2) 2x6 w/ 2x4 WALLS OR (3) 2x6 w/ 2x6 WALLS, UNLESS OTHERWISE NOTED. ALL HEADERS TO HAVE (1) 2x4 OR 2x6 JACK AND KING STUD EACH END, UNLESS OTHERWISE NOTED. MULTI-OPENING HEADERS TO HAVE (2) JACKS AT INTERMEDIATE BEARING, UNLESS OTHERWISE NOTED. NO ADDITIONAL FLOOR SYSTEM BLOCKING OR CONTINUOUS
- ALL EXTERIOR WALLS TO BE 4" OR 6" AND ALL INTERIOR WALLS TO BE 3 1/2", UNLESS OTHERWISE NOTED. . HATCHED AREAS INDICATE DROPPED CEILINGS. ALL DROPPED CEILINGS ARE 12" UNLESS OTHERWISE NOTED.

LOAD PATH JACKS ARE REQUIRED UNLESS OTHERWISE

- SEE ARCHITECTURAL DETAIL 8/IT-IB FOR 3/4" FIRE STOPPING AT BULKHEAD / CEILING PANELS SEE "BRACED WALL PANEL DETAIL SHEET" FOR SPECIAL WALL FRAMING LOCATIONS AND HEADER SIZES, IF
- APPLICABLE. SEE STANDARD DETAIL CATEGORY "IT" SHEET(S) FOR INTERIOR TRIM DETAILS.
- SEE ARCHITECTURAL DETAIL SHEET "AD" FOR HOUSE SPECIFIC INTERIOR TRIM OPTION TABLE. . ALL HEADERS IN NON-BEARING WALLS SHALL BE A
- SINGLE FLAT 2X4 OR 2X6 ATTACHED TO CRIPPLES ABOVE, UNLESS OTHERWISE NOTED. TANKED WATER HEATER SHOWN AS BASE CONDITION,
- OPTIONAL TANKLESS WATER HEATER IS AVAILABLE IN LIEU OF TANKED WATER HEATER.). INTERIOR HEADER HEIGHT FOR 8' CEILING WILL BE 6'-II", 9' CEILING WILL BE 7'-II", IO' CEILING WILL BE 8'-3",
- UNLESS OTHERWISE NOTED. BASEMENT FINISH DIMENSIONS ASSUME A 1/2" GAP BETWEEN FRAME WALL AND CONCRETE WALL. 2. ALL INTERIOR BEARING WALLS SHALL HAVE GYPSUM
- APPLIED TO AT LEAST ONE SIDE OR HAVE MID-HEIGHT BLOCKING INSTALLED. 3. NON-BEARING WALLS OVER CONCRETE TO BE HELD 1/2" SHORT OF FRAMING ABOVE.

GYPSUM NOTES:


AT GARAGE:


GYPSUM BOARD AT COMMON WALLS, CEILINGS, BEAM WRAPS AND SUPPORTS PER STANDARD DETAIL FA-I(b) FIRE ASSEMBLIES OR AS REQUIRED BY LOCAL CODE.

AT STAIRS:

1/2" GYPSUM BOARD AT UNDERSIDE OF STAIRS AND WALLS

SECOND FLOOR JACK SCHEDULE				
IDENTIFIER	DESCRIPTION	ENG. NUM.	REMARKS	
J20I	JACK - (5) 2X4 SPF STUD GRADE	2004	EXTEND THROUGH TOP PLATE	
J202	JACK - (5) 2X4 SPF STUD GRADE	2004	EXTEND THROUGH TOP PLATE	

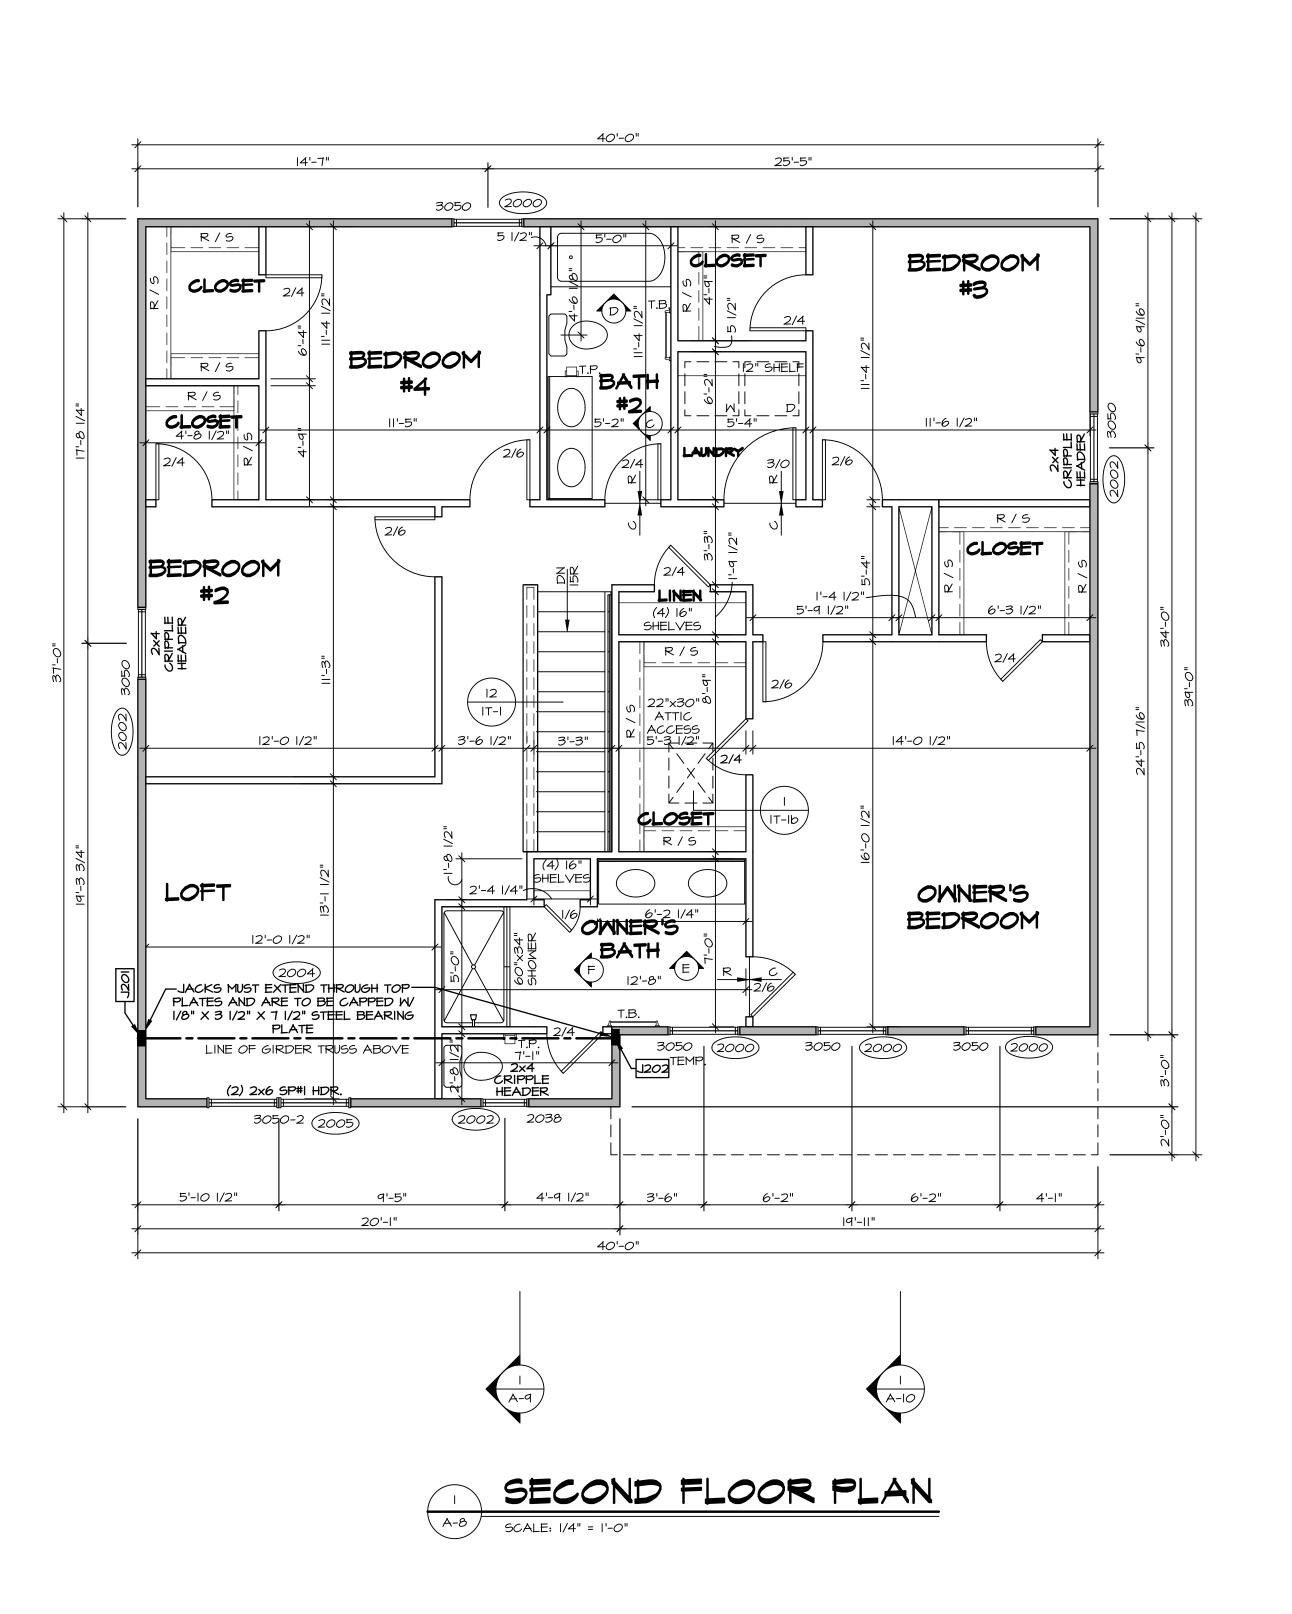

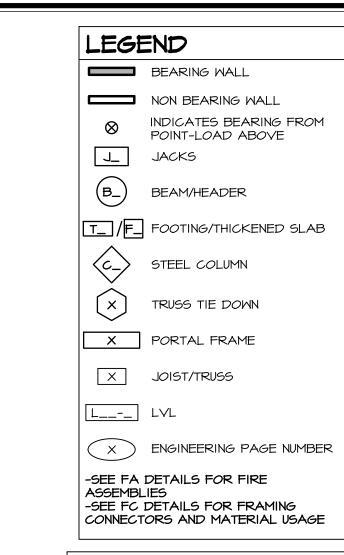

ALL WINDOWS HAVE 7'-4 5/8" HEADER HEIGHT UNLESS OTHERWISE NOTED

FLOOR PLAN NOTES:

- ALL HEADERS ARE (2) 2x6 W/ 2x4 WALLS OR (3) 2x6 W/ 2x6 WALLS, UNLESS OTHERWISE NOTED.

 ALL HEADERS TO HAVE (1) 2x4 OR 2x6 JACK AND KING STUD EACH END, UNLESS OTHERWISE NOTED. MULTI-OPENING HEADERS TO HAVE (2) JACKS AT INTERMEDIATE BEARING, UNLESS OTHERWISE NOTED. NO ADDITIONAL FLOOR SYSTEM BLOCKING OR CONTINUOUS
- ALL EXTERIOR WALLS TO BE 4" OR 6" AND ALL INTERIOR WALLS TO BE 3 1/2", UNLESS OTHERWISE NOTED. . HATCHED AREAS INDICATE DROPPED CEILINGS. ALL DROPPED CEILINGS ARE 12" UNLESS OTHERWISE NOTED.

LOAD PATH JACKS ARE REQUIRED UNLESS OTHERWISE

- SEE ARCHITECTURAL DETAIL 8/IT-IB FOR 3/4" FIRE STOPPING AT BULKHEAD / CEILING PANELS
 . SEE "BRACED WALL PANEL DETAIL SHEET" FOR SPECIAL WALL FRAMING LOCATIONS AND HEADER SIZES, IF
- APPLICABLE. SEE STANDARD DETAIL CATEGORY "IT" SHEET(S) FOR INTERIOR TRIM DETAILS.
- SEE ARCHITECTURAL DETAIL SHEET "AD" FOR HOUSE SPECIFIC INTERIOR TRIM OPTION TABLE.
- ALL HEADERS IN NON-BEARING WALLS SHALL BE A SINGLE FLAT 2X4 OR 2X6 ATTACHED TO CRIPPLES
- ABOVE, UNLESS OTHERWISE NOTED.

 TANKED WATER HEATER SHOWN AS BASE CONDITION, OPTIONAL TANKLESS WATER HEATER IS AVAILABLE IN LIEU OF TANKED WATER HEATER.
- P. INTERIOR HEADER HEIGHT FOR 8' CEILING WILL BE 6'-II", 9' CEILING WILL BE 7'-II", IO' CEILING WILL BE 8'-3",
- UNLESS OTHERWISE NOTED. BASEMENT FINISH DIMENSIONS ASSUME A 1/2" GAP BETWEEN FRAME WALL AND CONCRETE WALL.

 2. ALL INTERIOR BEARING WALLS SHALL HAVE GYPSUM
 APPLIED TO AT LEAST ONE SIDE OR HAVE MID-HEIGHT
- BLOCKING INSTALLED. 3. NON-BEARING WALLS OVER CONCRETE TO BE HELD 1/2" SHORT OF FRAMING ABOVE.

GYPSUM NOTES:


AT GARAGE:


GYPSUM BOARD AT COMMON WALLS, CEILINGS, BEAM WRAPS AND SUPPORTS PER STANDARD DETAIL FA-I(b) FIRE ASSEMBLIES OR AS REQUIRED BY LOCAL CODE.

AT STAIRS:

1/2" GYPSUM BOARD AT UNDERSIDE OF STAIRS AND WALLS IN CLOSET


	reserves its perty rights ans are not ranged, or manner hey to be seed written steed written reserves its perty without steed written reserves its perty rights without reserves its reserved by the perty reserves reserved.
	© NVR, Inc., The owner, expressly reserves its copyright and other property rights in these plans. These plans are not to be reproduced, changed, or copied in any form or manner whatsoever, nor are they to be assigned to any third party, without first obtaining the expressed written consent of NVR, Inc.

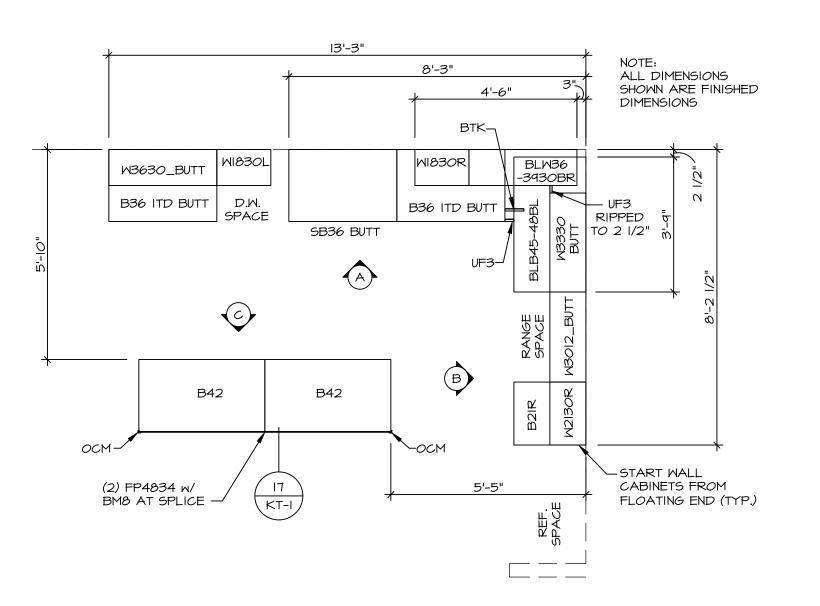


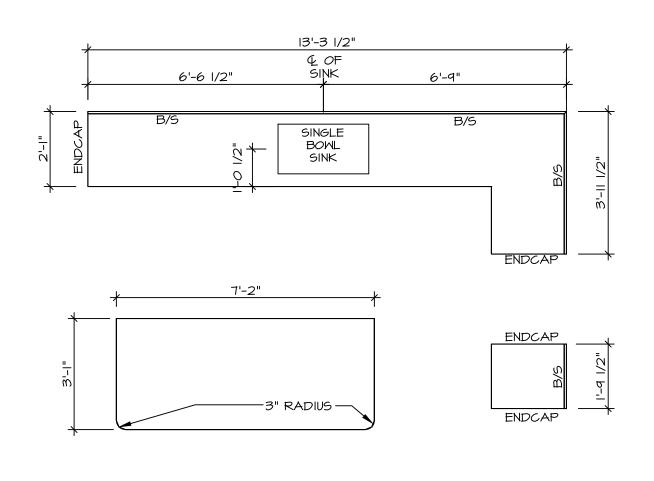


KITCHEN CABINET PLAN (KC-3899) SCALE: 3/8" = 1'-0"

KITCHEN COUNTERTOP PLAN (KT-3899) A-12 SCALE: 3/8" = 1'-0"

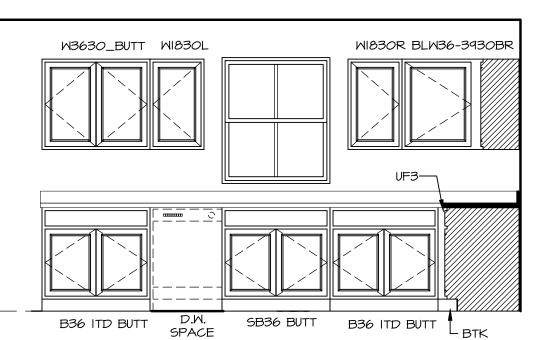

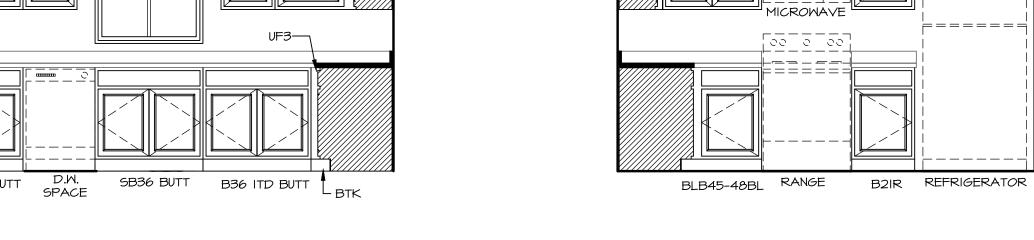

UF3 RIPPED TO 2 1/2"-

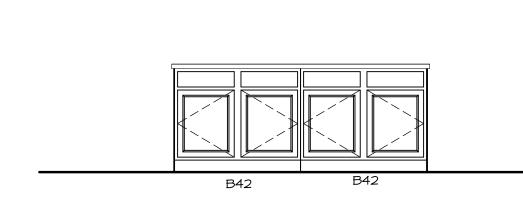





20 KT-I

M3330 BUTT M3012_BUTT



NOTES:
CABINETS ARE NOT REPRESENTATIVE OF ALL STYLES AND ARE MEANT AS A GENERAL DEPICTION OF THE INTENDED CABINET LAYOUT

KITCHEN NOTES:

- I. CABINET LAYOUT (S) ARE BASED ON FINISHED DIMENSIONS TO DRYWALL.

 2. IF KITCHEN PLANS/ELEVATIONS CALL-OUT STANDARD MOLDING, REFER TO STANDARD DETAIL (II/KT-I) FOR REPLACEMENT BASED ON CABINET STYLE.
- 5. SET PRE-FINISHED SCRIBE MOLDING AT CABINET BULKHEADS AND AT ENDS (WHERE CABINETS MEET DRYWALL.) PRE-FINISHED=

3. ALL (UF#) FILLERS ARE TO BE "TRIM TO FIT"
UNLESS OTHERWISE NOTED.
4. CABINET MUST BE SET, SHIMMED, LEVELED
AND PLUMB W/ ADJOINING BASE CABINETS. SCRIBE MOLDING SHALL BE USED TO PAD OUT CABINET SIDES AT STILE FOR RETURN PIECES OF THE FACE-MOUNTED CABINET CROWN MOLDING.

