
S2 424 6844 RIVULET DRIVE MIDDLETOWN, OH 45042

2 Story Basement - 3pc rough in 2 hose bibs - no valves required Vent Kitchen ice maker 2 tub2 WATER HEATER ELECTRIC 50 GALLON Inside Water Meter setup

Gas Furnace and Range

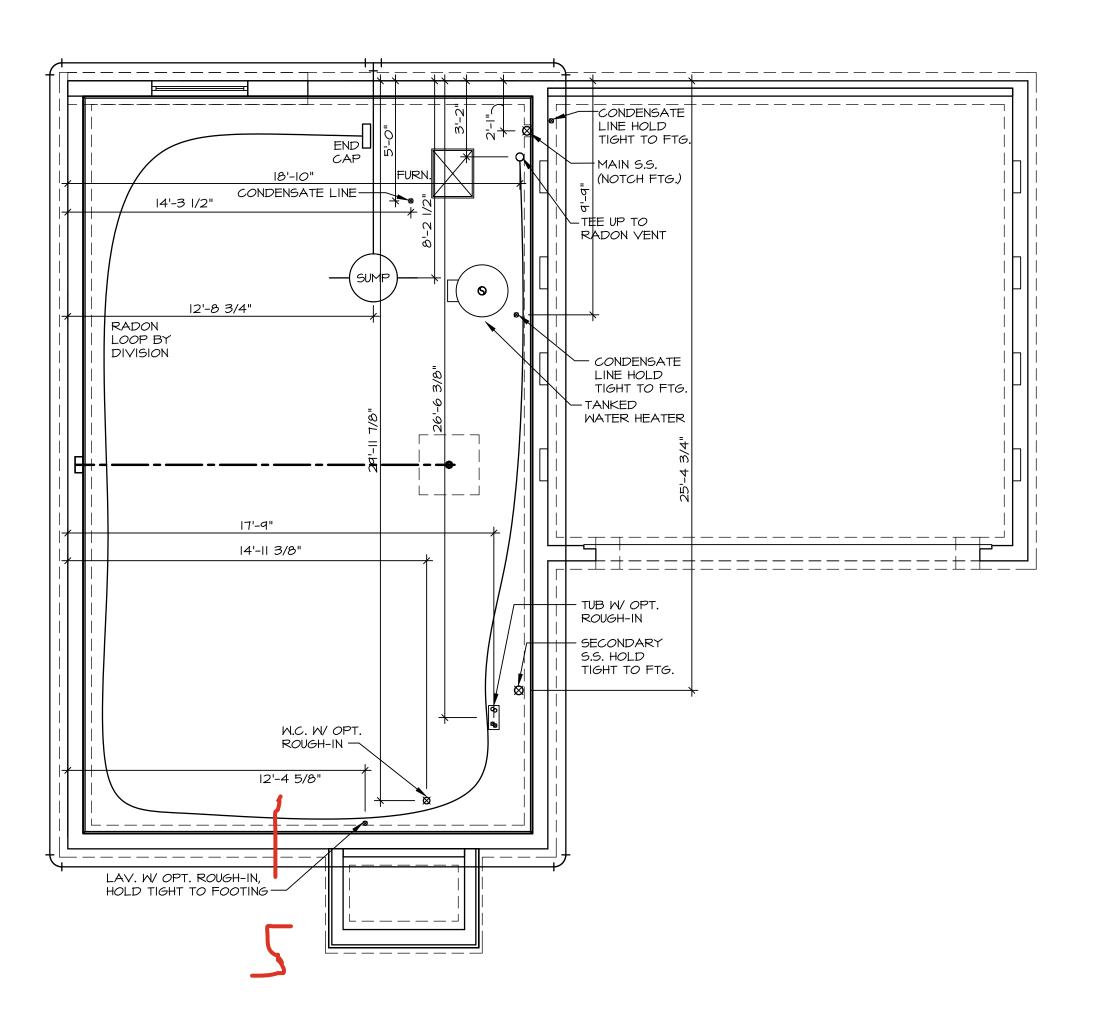



PLUMBING NOTES:

RADON REMEDIATION

RADON LOOP:

- (4") PERFORATED HDPE "LOOP"

- MUST BE PLACED IN STONE BED SLIGHTLY HIGHER THAN ANY INTERIOR DRAINTILE

- LOOP TO BE SEPARATE FROM ANY DRAINTILE ELEMENTS


- TO BE CORRIGATED HDPE PIPE

- TO BE CORRUGATED HDPE PIPE - SCREWS TO BE INSTALLED THROUGH LOOP AT TEE UP INTO STACK STACK REQUIREMENTS:

- 3" PVC STACK (4" IF BASEMENT IS GREATER THAN 2200 SQFT.) NO PART OF STACK IS TO BE HORIZONTAL (45° ELBOWS PERMITTED AS REQUIRED)
PIPE TO BE PHYSICALLY LABELED IN THE FIELD AS "RADON VENT" OR OTHER

JURISDICTIONALLY REQUIRED LANGUAGE (ON EVERY LEVEL OF HOUSE)
- ROOF TERMINATION TO BE IN TOP 1/3 OF ROOF

SCREEN OR VENT CAP INSTALLED TO KEEP PESTS OUT OF RADON VENT AT ROOF TERMINATION.

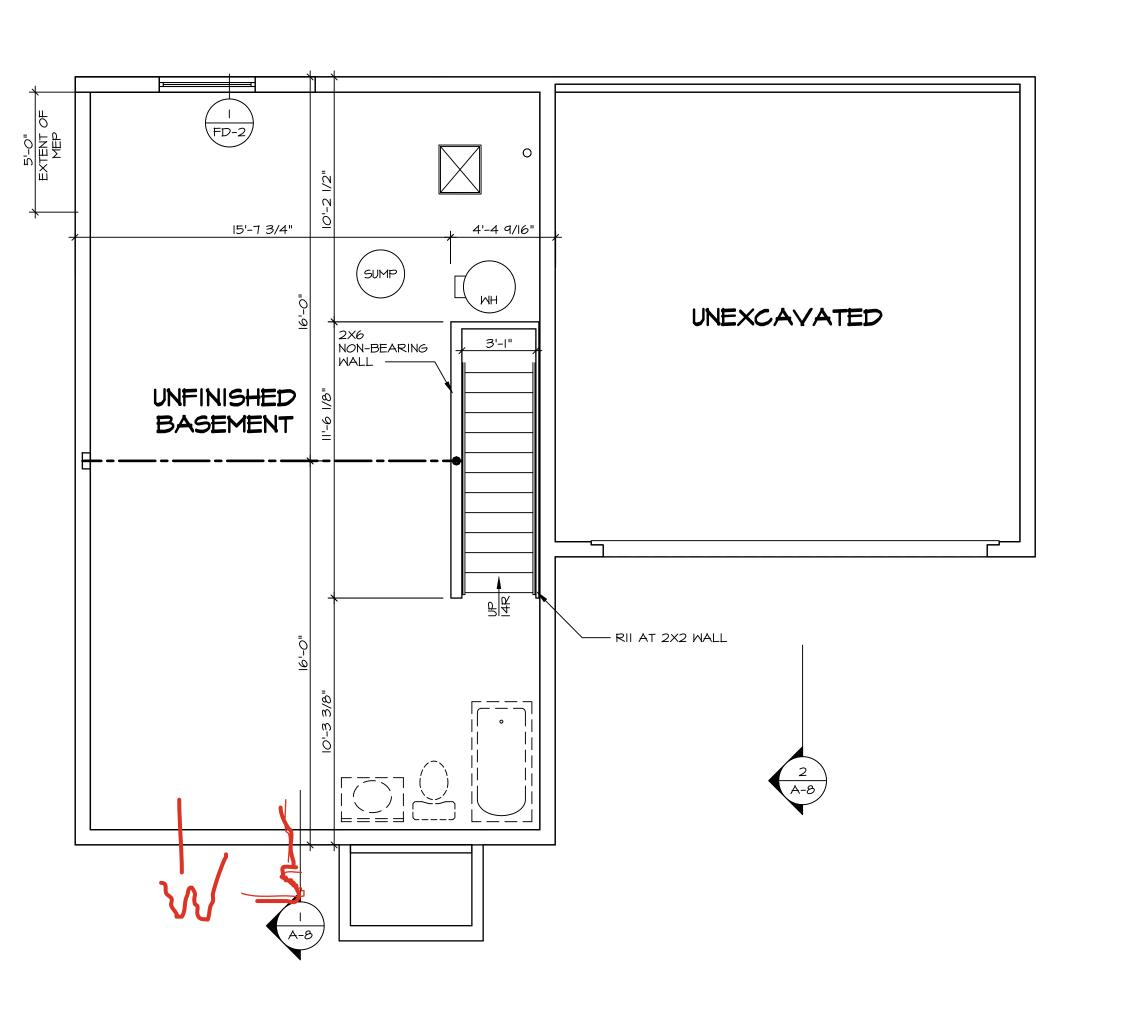

ALL WINDOWS HAVE 7'-4 5/8" HEADER HEIGHT UNLESS OTHERWISE NOTED

LEGEND BEARING WALL NON BEARING WALL INDICATES BEARING FROM POINT-LOAD ABOVE J_ JACKS BEAM/HEADER T_/F_ FOOTING/THICKENED SLAB STEEL COLUMN TRUSS TIE DOWN X PORTAL FRAME X JOIST/TRUSS L__-_ LVL X ENGINEERING PAGE NUMBER -SEE FA DETAILS FOR FIRE ASSEMBLIES
-SEE FC DETAILS FOR FRAMING CONNECTORS AND MATERIAL USAGE

FLOOR PLAN NOTES:

ALL HEADERS ARE (2) 2x6 w/ 2x4 WALLS OR (3) 2x6 w/ 2x6 WALLS, UNLESS OTHERWISE NOTED.

. ALL HEADERS TO HAVE (1) 2x4 OR 2x6 JACK AND KING STUD EACH END, UNLESS OTHERWISE NOTED. MULTI-OPENING HEADERS TO HAVE (2) JACKS AT INTERMEDIATE BEARING, UNLESS OTHERWISE NOTED. NO ADDITIONAL FLOOR SYSTEM BLOCKING OR CONTINUOUS LOAD PATH JACKS ARE REQUIRED UNLESS OTHERWISE

ALL EXTERIOR WALLS TO BE 4" OR 6" AND ALL INTERIOR WALLS TO BE 3 1/2", UNLESS OTHERWISE NOTED. . HATCHED AREAS INDICATE DROPPED CEILINGS. ALL DROPPED CEILINGS ARE 12" UNLESS OTHERWISE NOTED. SEE ARCHITECTURAL DETAIL 8/IT-IB FOR 3/4" FIRE STOPPING AT BULKHEAD / CEILING PANELS SEE "BRACED WALL PANEL DETAIL SHEET" FOR SPECIAL WALL FRAMING LOCATIONS AND HEADER SIZES, IF

APPLICABLE. SEE STANDARD DETAIL CATEGORY "IT" SHEET(S) FOR INTERIOR TRIM DETAILS. SEE ARCHITECTURAL DETAIL SHEET "AD" FOR HOUSE

SPECIFIC INTERIOR TRIM OPTION TABLE. ALL HEADERS IN NON-BEARING WALLS SHALL BE A SINGLE FLAT 2X4 OR 2X6 ATTACHED TO CRIPPLES ABOVE, UNLESS OTHERWISE NOTED.

TANKED WATER HEATER SHOWN AS BASE CONDITION,

OPTIONAL TANKLESS WATER HEATER IS AVAILABLE IN LIEU OF TANKED WATER HEATER. O. INTERIOR HEADER HEIGHT FOR 8' CEILING WILL BE 6'-II", 9' CEILING WILL BE 7'-II", IO' CEILING WILL BE 8'-3",

UNLESS OTHERWISE NOTED. BASEMENT FINISH DIMENSIONS ASSUME A 1/2" GAP BETWEEN FRAME WALL AND CONCRETE WALL. . ALL INTERIOR BEARING WALLS SHALL HAVE GYPSUM APPLIED TO AT LEAST ONE SIDE OR HAVE MID-HEIGHT BLOCKING INSTALLED.

3. NON-BEARING WALLS OVER CONCRETE TO BE HELD 1/2" SHORT OF FRAMING ABOVE.

GYPSUM NOTES:

AT GARAGE:

GYPSUM BOARD AT COMMON WALLS, CEILINGS, BEAM WRAPS AND SUPPORTS PER STANDARD DETAIL FA-I(b) FIRE ASSEMBLIES OR AS REQUIRED BY LOCAL CODE.


AT STAIRS:

1/2" GYPSUM BOARD AT UNDERSIDE OF STAIRS AND WALLS IN CLOSET

BASEMENT JACK SCHEDULE					
DENTIFIER	FIER DESCRIPTION				

BASEMENT FLOOR PLAN A-5 SCALE: 1/4" = 1'-0"

FIRST FLOOR JACK SCHEDULE				
IDENTIFIER	DESCRIPTION	ENG. NUM.		
OOIL	JACK - (4) 2X4 SPF STUD GRADE	1004		
OIL	JACK - (2) 2X4 SPF STUD GRADE	1002		
JI02	JACK - (3) 2X4 SPF STUD GRADE	1015		
EOIL	JACK - (3) 2X4 SPF STUD GRADE	1015		
JI04	JACK - (4) 2X4 SPF STUD GRADE	1004		
JI <i>0</i> 5	JACK - (2) 2X4 SPF STUD GRADE	1008		
JI06	JACK - (2) 2X4 SPF STUD GRADE	1008		

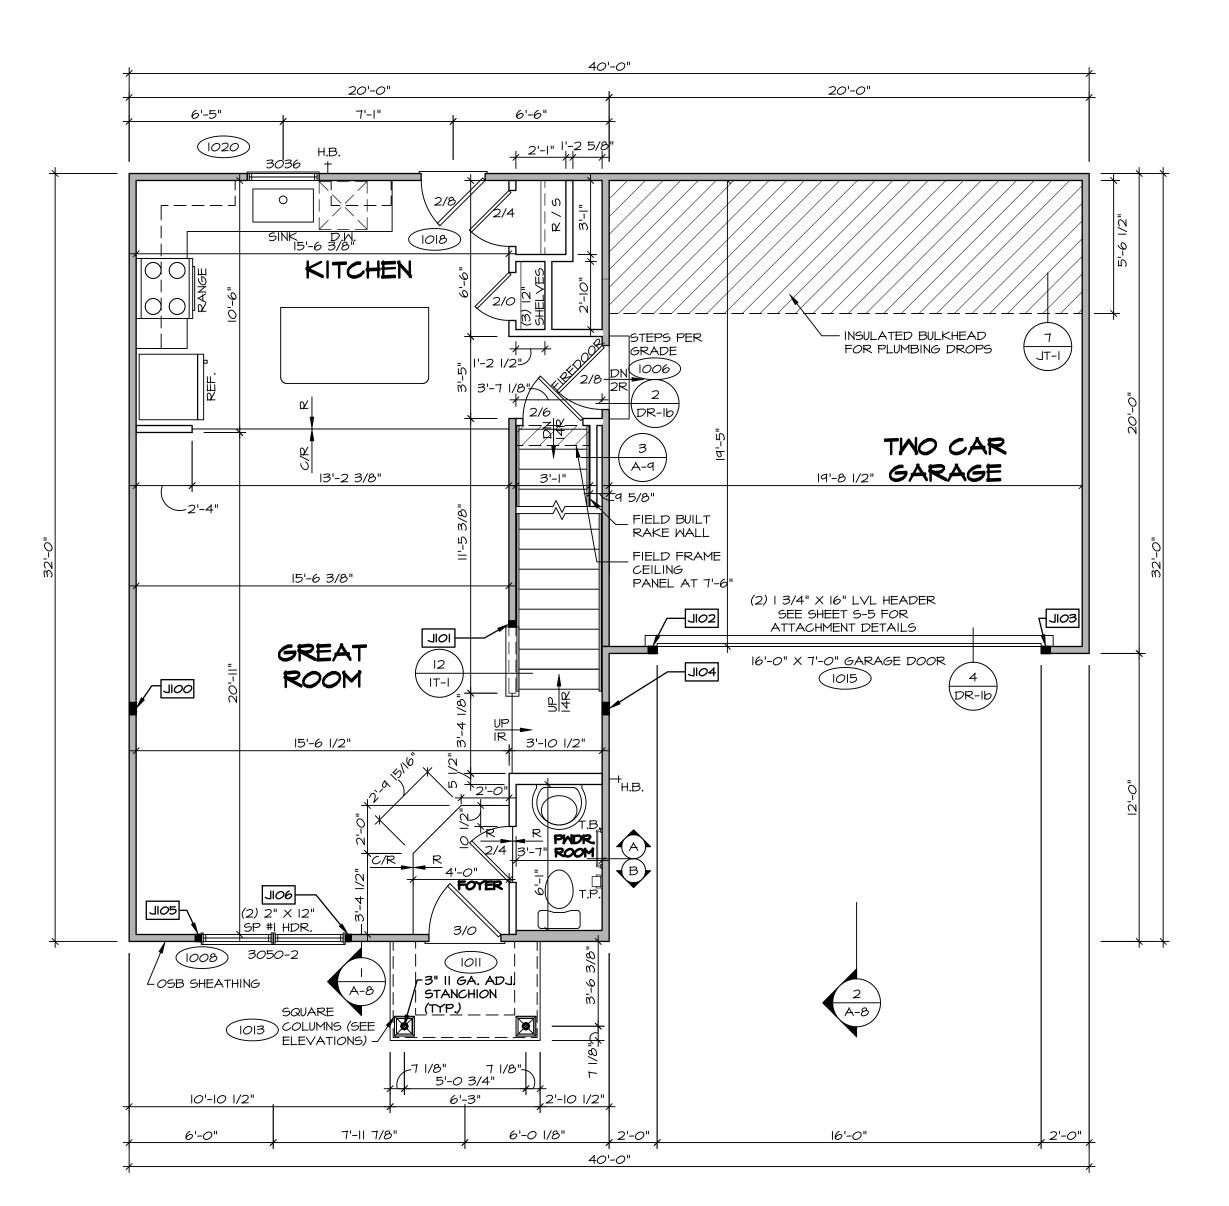

FIRST FLOOR PLAN

SCALE: 1/4" = 1'-0"

ALL WINDOWS HAVE 7'-4 5/8" HEAD! HEIGHT UNLESS OTHERWISE NOTED

HEADER TED	LEGE	IND
		BEARING WALL
		NON BEARING WALL
	8	INDICATES BEARING FROM POINT-LOAD ABOVE
	J_	JACKS
	B_	BEAM/HEADER
	T_/F_	FOOTING/THICKENED SLAB
	⟨c_>	STEEL COLUMN
	\times	TRUSS TIE DOWN
	X	PORTAL FRAME
	X	JOIST/TRUSS
	L	LVL
	X	ENGINEERING PAGE NUMBER
	ASSEMBL -SEE FC 1	DETAILS FOR FIRE IES DETAILS FOR FRAMING ORS AND MATERIAL USAGE

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5. SEE "BRACED WALL PANEL DETAIL SHEET" FOR SPECIMALL FRAMING LOCATIONS AND HEADER SIZES, IF

APPLICABLE.

6. SEE STANDARD DETAIL CATEGORY "IT" SHEET(S) FOR

INTERIOR TRIM DETAILS.

7. SEE ARCHITECTURAL DETAIL SHEET "AD" FOR HOUSE SPECIFIC INTERIOR TRIM OPTION TABLE.

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II. BASEMENT FINISH DIMENSIONS ASSUME A I/2" GAP BETWEEN FRAME WALL AND CONCRETE WALL.
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SHORT OF FRAMING ABOVE.

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1/2" GYPSUM BOARD AT UNDERSIDE OF STAIRS AND WALLS

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1 PHT 1/2"	© NVR, Inc., The owner, expressly reserves its copyright and other property rights in these plans. These plans are not	copied in any form or manner whatsoever, nor are they to be	first obtaining the expressed written	נסוואפון סן אלא, ווכי	
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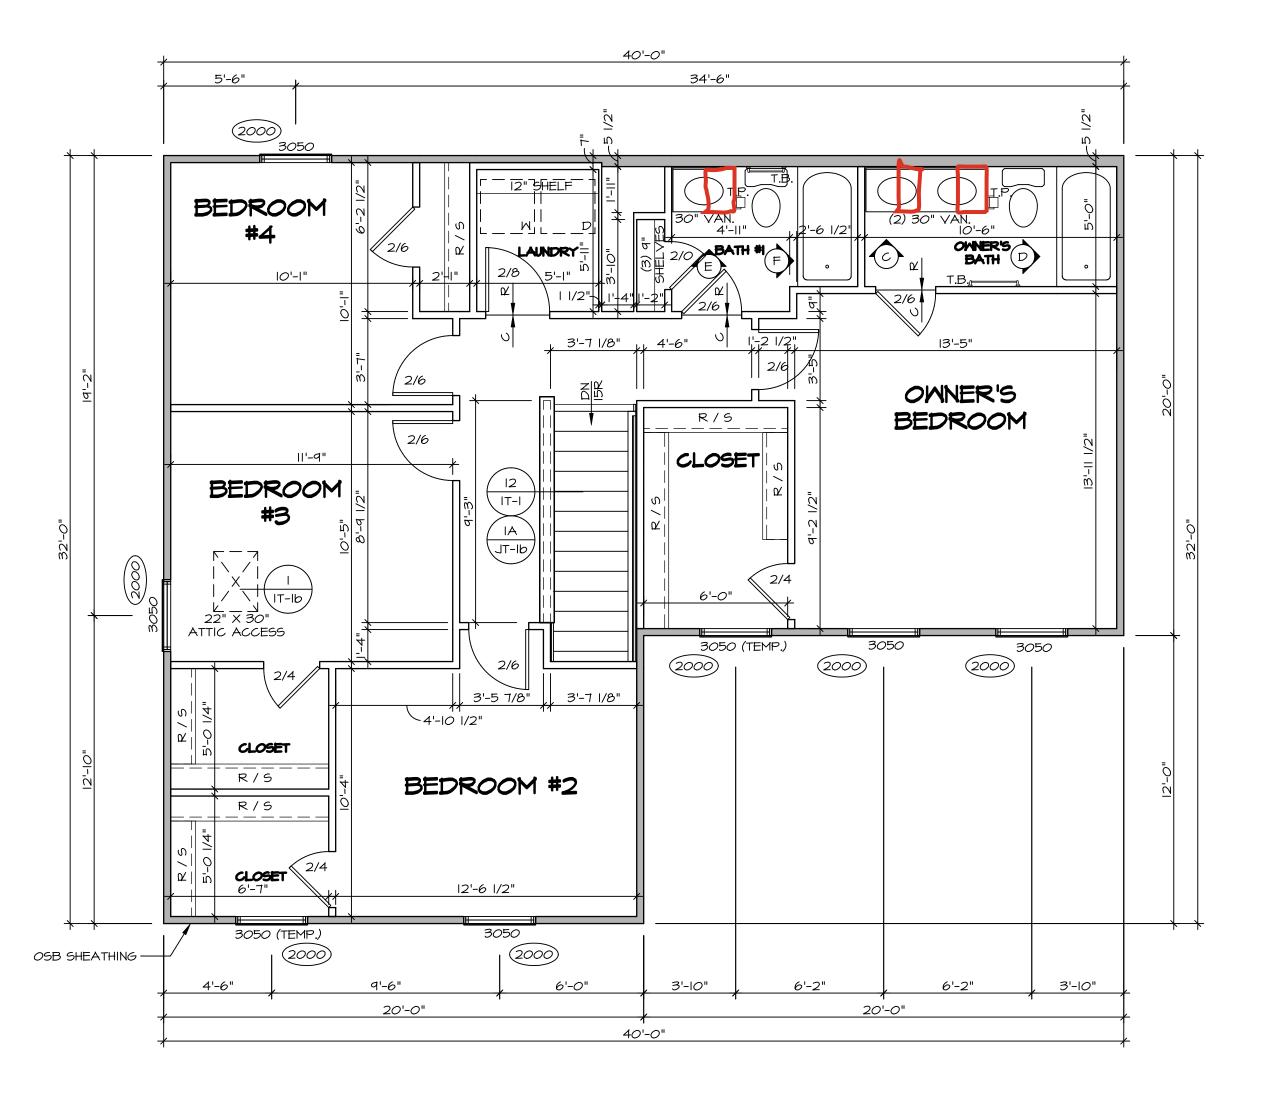
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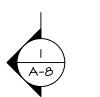
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DATE:

OPTION

DRAWING TITLE
FIRST FLOOR PLAN









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EADER ED	LEGE	ND .
		BEARING WALL
		NON BEARING WALL
	8	INDICATES BEARING FROM POINT-LOAD ABOVE
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AT STAIRS:

1/2" GYPSUM BOARD AT UNDERSIDE OF STAIRS AND WALLS IN CLOSET

so its its DIV-COMM-LOT-UNIT DCY-52-0424

COMM-LOT SAMYERS MILL - SIMPLY RYAN - 0424

STREET ADDRESS

6844 RIVULET DRIVE

CITY

STATE


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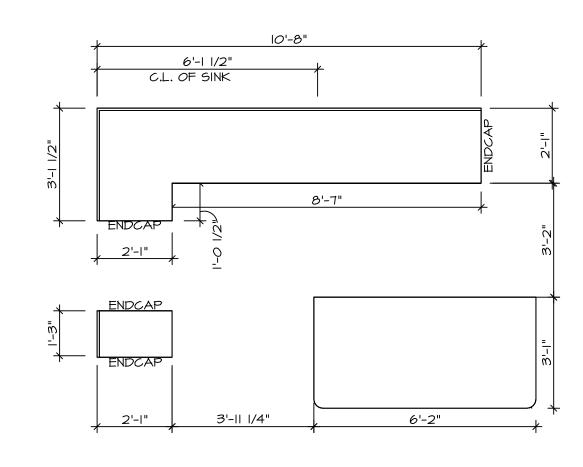
NVR, Inc.
5285 Westview Drive, Suite 100
Frederick, MD 21703
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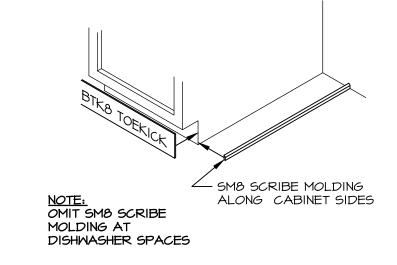
L-A





KITCHEN CABINET PLAN KC-3638



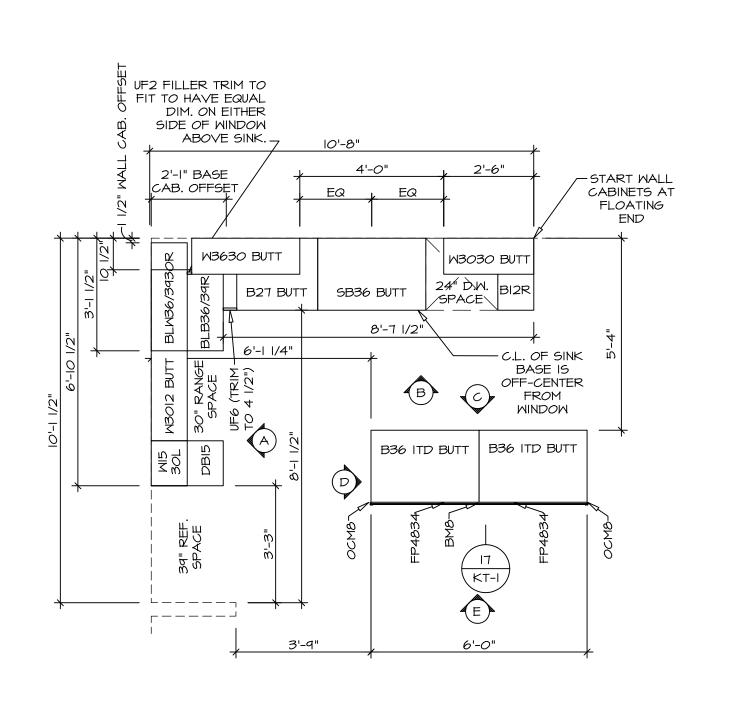

NOTES:
CABINETS ARE NOT REPRESENTATIVE OF ALL
STYLES AND ARE MEANT AS A GENERAL
DEPICTION OF THE INTENDED CABINET LAYOUT

. CABINET LAYOUT (S) ARE BASED ON FINISHED

DIMENSIONS TO DRYWALL.

2. IF KITCHEN PLANS/ELEVATIONS CALL-OUT STANDARD MOLDING, REFER TO STANDARD

DETAIL (II/KT-I) FOR REPLACEMENT BASED ON CABINET STYLE.

3. ALL (UF#) FILLERS ARE TO BE "TRIM TO FIT" UNLESS OTHERWISE NOTED. 4. CABINET MUST BE SET, SHIMMED, LEVELED AND PLUMB W/ ADJOINING BASE CABINETS.


5. SET PRE-FINISHED SCRIBE MOLDING AT


CABINET BULKHEADS AND AT ENDS (WHERE CABINETS MEET DRYWALL.) PRE-FINISHED=


SCRIBE MOLDING SHALL BE USED TO PAD OUT CABINET SIDES AT STILE FOR RETURN PIECES OF THE FACE-MOUNTED CABINET CROWN MOLDING.


KITCHEN NOTES:


TOEKICK / SCRIBE DETAIL SCALE: 3/4" = 1'-0"

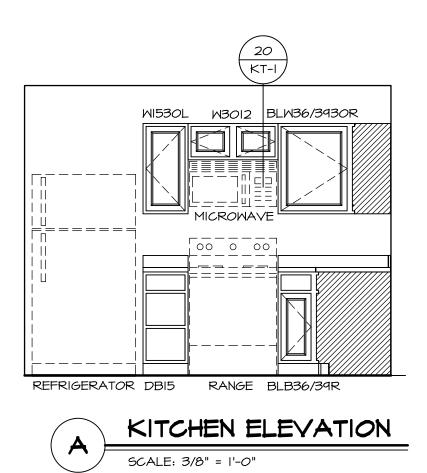

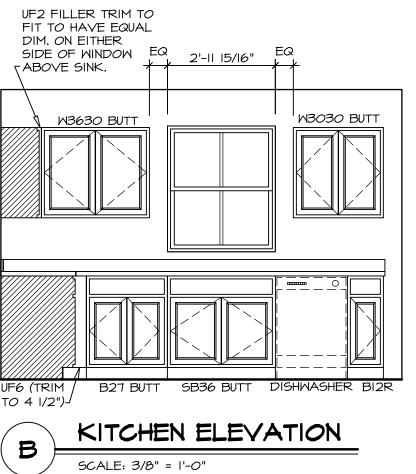

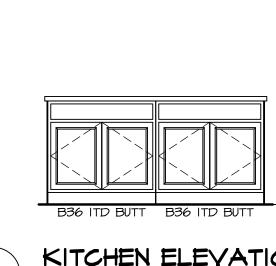


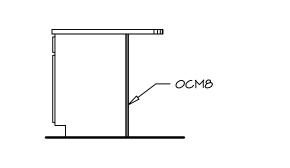

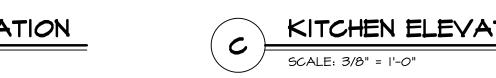



/ (2) FP4834 OCM8 —

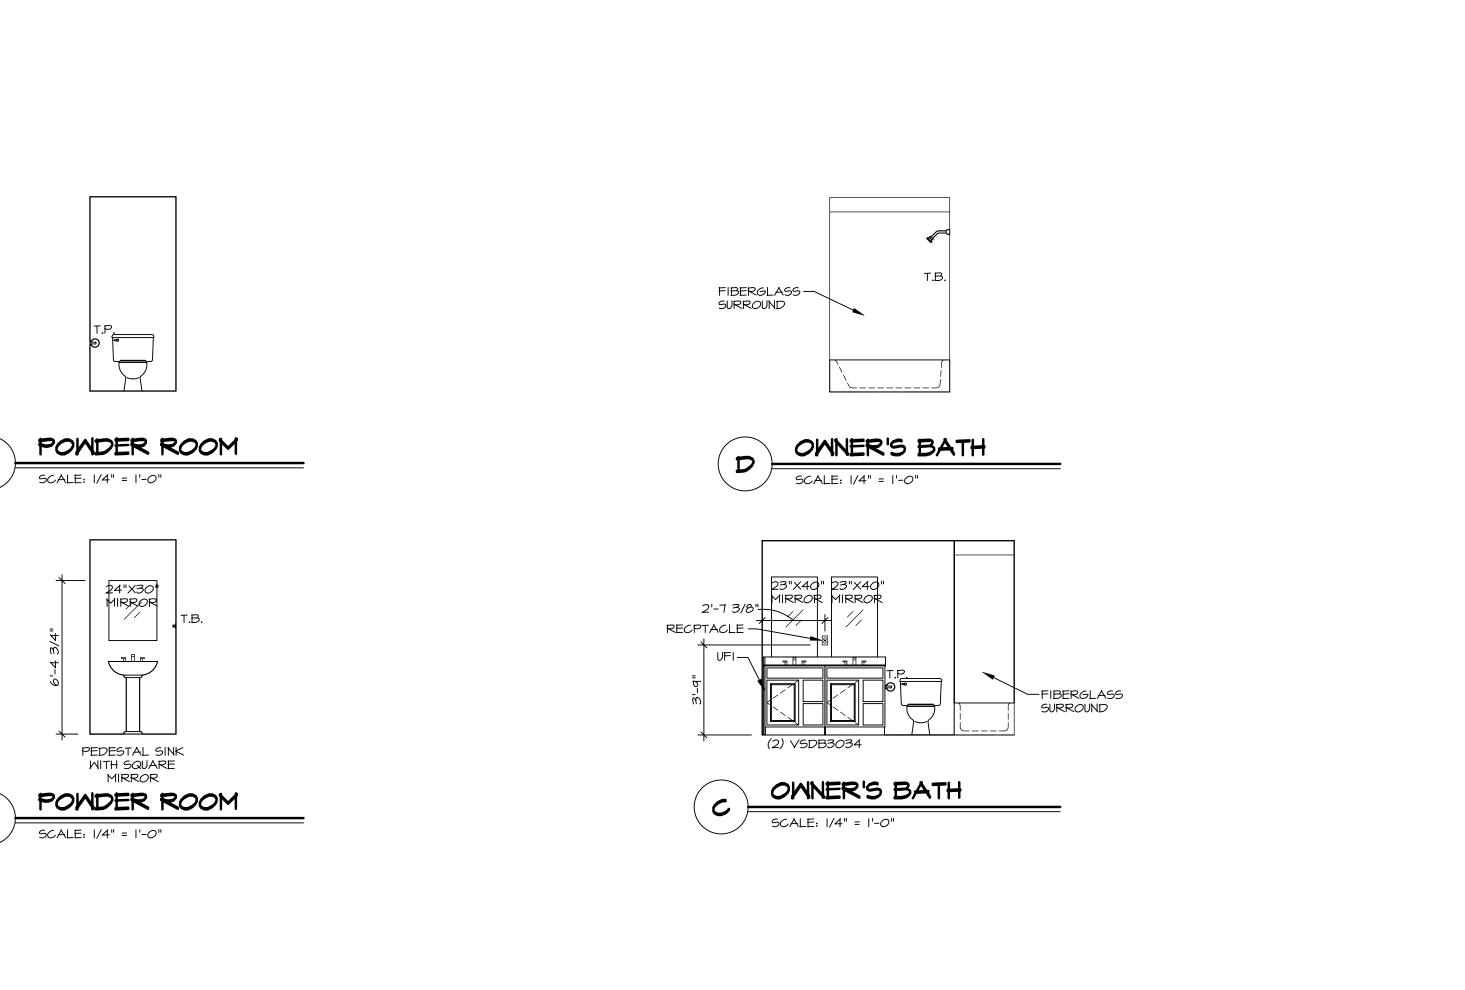

NOTES:

TEMPERED GLASS SHOWER
 ENCLOSURE WITH SWING DOOR OR
 OPTIONAL SLIDING DOOR BY DIVISION.
 TUB ACCESS PANELS PROVIDED AS
 NEEDED, ALL MATERIALS BY DIVISION.
 ALL BATH ELEVATIONS SHOWN PER PLAN.
 ALL VANITIES WITH DRAWERS TO BE SET
 WITH DRAWERS ON RIGHT HAND SIDE.
 BATH ELEVATIONS ARE SHOWN PER PLAN.
 ALL DIMENSIONS SHOWN ON BATH
 ELEVATIONS ARE ROUGH FRAMING
 REFERENCES ONLY.

=

, т.В.		— FIBERGLASS
		SURROUND



