
S2 465 5901 CRESTING DRIVE MIDDLETOWN, OH 45042

1 Story Basement - 3 pc rough in
2 hose bibs - no valves required
Vent Kitchen
ice maker
1 tub
1 shower
WATER HEATER ELECTRIC 40 GALLON
Inside Water Meter setup

Gas Furnace and Range

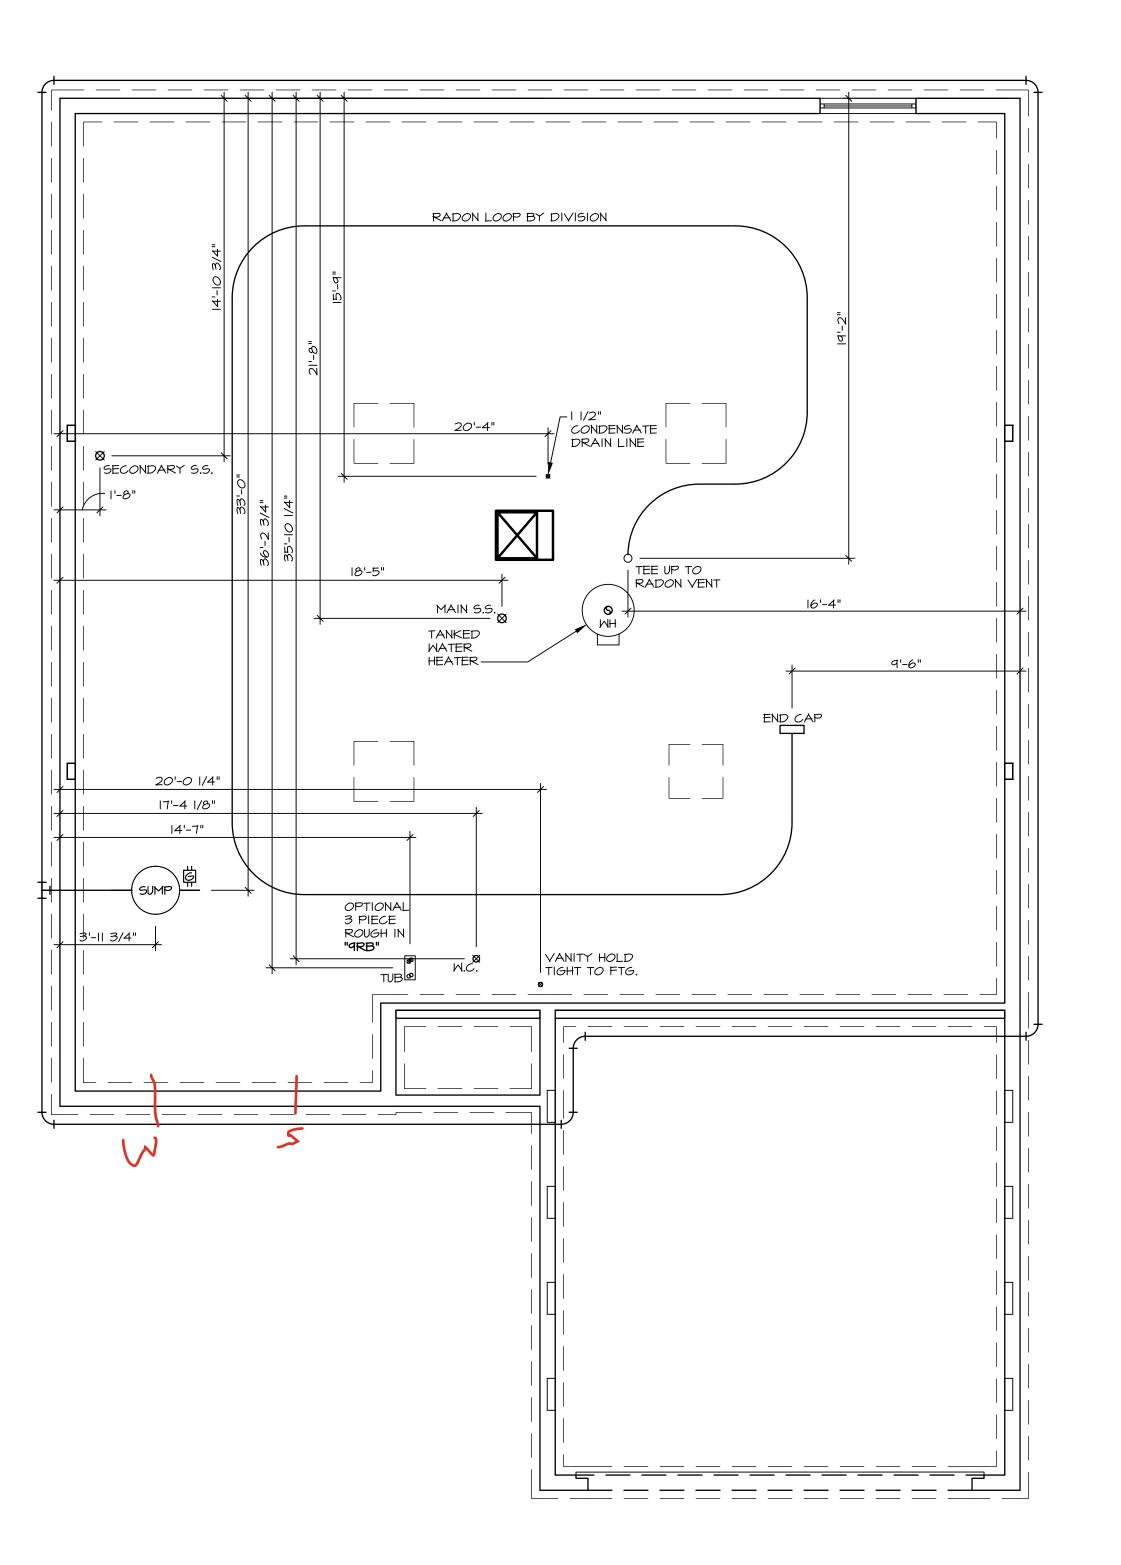

PLUMBING PLAN

SCALE: 1/4" = 1'-0"

RADON REMEDIATION
RADON LOOP:

- (4") PERFORATED HDPE "LOOP"

- MUST BE PLACED IN STONE BED SLIGHTLY HIGHER THAN ANY INTERIOR DRAINTILE

- LOOP TO BE SEPARATE FROM ANY DRAINTILE ELEMENTS

- TO BE CORRUGATED HDPE PIPE

- SCREWS TO BE INSTALLED THROUGH LOOP AT TEE UP INTO STACK
STACK REQUIREMENTS:

- 3" PVC STACK (4" IF BASEMENT IS GREATER THAN 2200 SQFT.)


- NO PART OF STACK IS TO BE HORIZONTAL (45° ELBOWS PERMITTED AS REQUIRED)


- PIPE TO BE PHYSICALLY LABELED IN THE FIELD AS "RADON VENT" OR OTHER
JURISDICTIONALLY REQUIRED LANGUAGE (ON EVERY LEVEL OF HOUSE)

- ROOF TERMINATION TO BE IN TOP 1/3 OF ROOF

- SCREEN OR VENT CAP INSTALLED TO KEEP PESTS OUT OF RADON VENT AT ROOF TERMINATION.

DEAWN BY HNP DEAVN BY HNP DEAVN BY HNP DEAVN BY HNP DEAVN BY HNP DETECT OF THE TOTAL			© NVR, Inc., The owner, expressly reserves its copyright and other property rights in these plans the plans are not	DOY-SOMM-LOT-UNIT	2-046	īŪ
NVR, Inc. STREET ADDRESS STREET ADDRESS Frederick, MD 21703 Frederick, MD 21703 WIDDLETOMN OH OH OH OFFICIAL ADDRESS STREET ADDRESS Frederick, MD 21703 OH OH OH OH OFFICIAL ADDRESS STREET ADDRESS Frederick, MD 21703 OH OH OH OH OH OH OH OH OH O	DRAWN BY HNP DATE: 02/20/20		e reproduced, changed, or lin any form or manner oever, nor are they to the control of the contr	COMM-LOT SAMYERS MILL - SIMPLY RY	AN - 0465	
STATE ZIP	NVR, Inc. OPTION 5285 Westview Drive, Suite 100 Frederick, MD 21703	NVR, Inc. Westview Drive, Suite 100 Frederick, MD 21703	ted to any initia party, without bbtaining the expressed written int of NVR, Inc.	STREET ADDRESS 5401 CRESTING DRIVE		APT. NO.
# O				CITY		
				MIDDLETOWN	Q T	45042

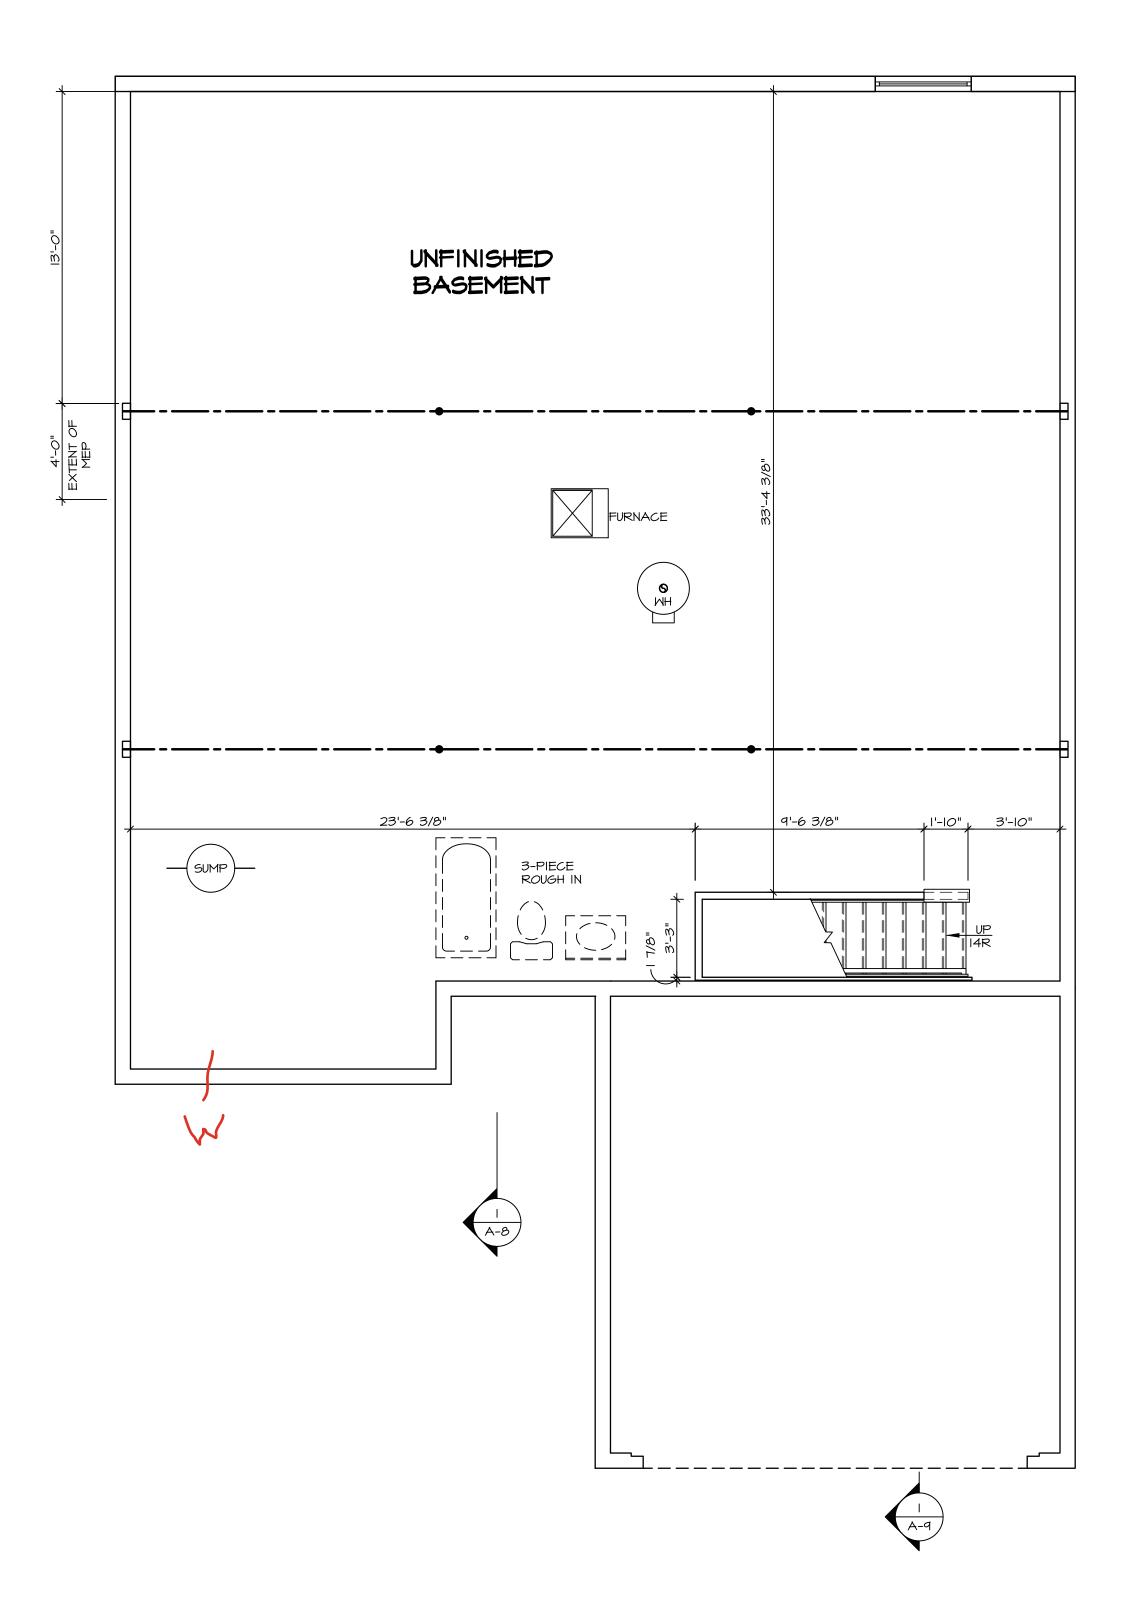

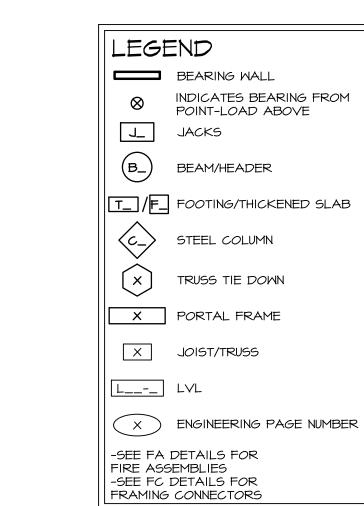

FLOOR PLAN NOTES

RYAN

ALL HEADERS ARE (2) 2x6 w/ 2x4 WALLS OR (3) 2x6 w/ 2x6 WALLS, UNLESS OTHERWISE NOTED.

ALL HEADERS TO HAVE (1) 2x4 OR 2x6 JACK AND KING STUD EACH END, UNLESS OTHERWISE NOTED.

MULTI-OPENING HEADERS TO HAVE (2) JACKS AT INTERMEDIATE BEARING, UNLESS OTHERWISE NOTED. NO ADDITIONAL FLOOR SYSTEM BLOCKING OR CONTINUOUS LOAD PATH JACKS ARE REQUIRED UNLESS OTHERWISE NOTED.

3. ALL EXTERIOR WALLS TO BE 4" W/ OSB OR 3 1/2" W/ LAMINATED FIBROUS STRUCTURAL SHEATHING, ALL

INTERIOR WALLS TO BE 3 I/2", UNLESS OTHERWISE NOTED.

4. HATCHED AREAS INDICATE DROPPED CEILINGS. ALL DROPPED CEILINGS ARE I2" UNLESS OTHERWISE NOTED. SEE ARCHITECTURAL DETAIL 8/IT-IB FOR 3/4" FIRE STOPPING AT BULKHEAD / CEILING PANELS

5. SEE "BRACED WALL PANEL DETAIL SHEET" FOR SPECIAL WALL FRAMING LOCATIONS AND HEADER SIZES, IF

APPLICABLE.

6. SEE STANDARD DETAIL CATEGORY "IT" SHEET(S) FOR INTERIOR TRIM DETAILS.

INTERIOR TRIM DETAILS.

7. SEE ARCHITECTURAL DETAIL SHEET "AD" FOR HOUSE SPECIFIC INTERIOR TRIM OPTION TABLE.

8. ALL HEADERS IN NON-BEARING WALLS SHALL BE A

8. ALL HEADERS IN NON-BEARING WALLS SHALL BE A SINGLE FLAT 2X4 OR 2X6 ATTACHED TO CRIPPLES ABOVE, UNLESS OTHERWISE NOTED.

9. TANKED WATER HEATER SHOWN AS BASE CONDITION, OPTIONAL TANKLESS WATER HEATER IS AVAILABLE IN LIEU OF TANKED WATER HEATER.
10. INTERIOR HEADER HEIGHT TO BE 6'-II" W/8'-O" CEILINGS AND 7'-II" W/9'-O" CEILINGS UNLESS OTHERWISE NOTED.
11. BASEMENT FINISH DIMENSIONS ASSUME A 1/2" GAP

II. BASEMENT FINISH DIMENSIONS ASSUME A I/2" GAP BETWEEN FRAME WALL AND CONCRETE WALL.
I2. ALL INTERIOR BEARING WALLS SHALL HAVE GYPSUM APPLIED TO AT LEAST ONE SIDE OR HAVE MID-HEIGHT BLOCKING INSTALLED.

GYPSUM NOTES


AT GARAGE:

GYPSUM BOARD AT COMMON WALLS, CEILINGS, BEAM WRAPS AND SUPPORTS PER STANDARD DETAIL FA-I(b) FIRE ASSEMBLIES OR AS REQUIRED BY LOCAL CODE.

AT STAIRS:


1/2" GYPSUM BOARD AT UNDERSIDE OF STAIRS AND WALLS IN CLOSET



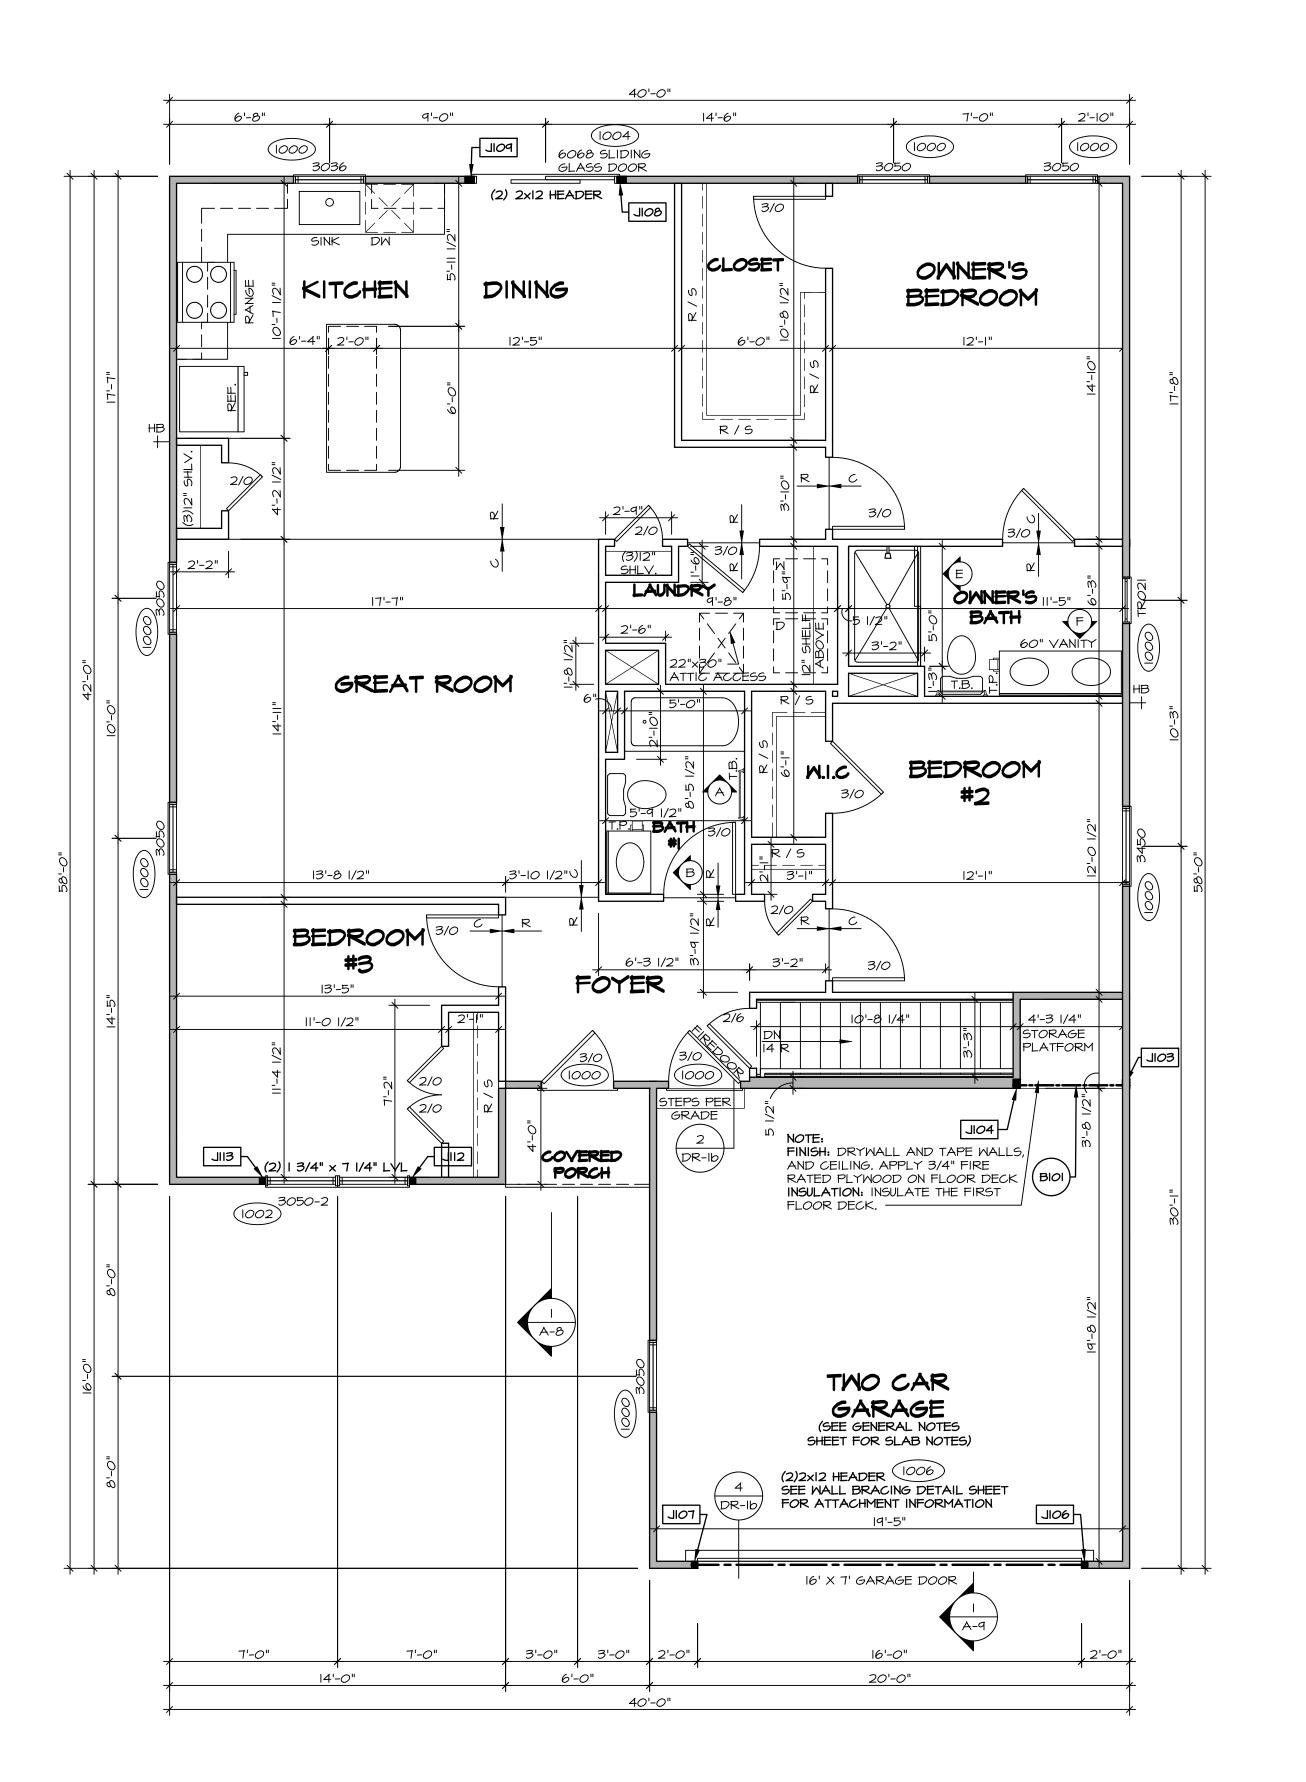

	FIRST FLOOR JACK SCHEDULE				
IDENTIFIER	DESCRIPTION	ENG. NUM.	REMARKS		
JI03	JACK - (3) 2X4 SPF STUD GRADE	1008			
JIO4	JACK - (3) 2X4 SPF STUD GRADE	1008			
JI06	JACK - (2) 2X4 SPF STUD GRADE	1006			
TOIL	JACK - (2) 2X4 SPF STUD GRADE	1006			
80IL	JACK - (3) 2X4 SPF STUD GRADE	1004			
POIL	JACK - (3) 2X4 SPF STUD GRADE	1004			
JII2	JACK - (2) 2X4 SPF STUD GRADE	1002			
SIIL	JACK - (2) 2X4 SPF STUD GRADE	1002			

FIELD	INSTALLED FIRST FL	OOR BEAM/	HEADER	SCHEDULE
IDENTIFIER	DESCRIPTION	LENGTH	ENG. NUM.	REMARKS
BIOI	INT HEADER - 2X8 - 2 PLY	4'-10 1/4"	1008	

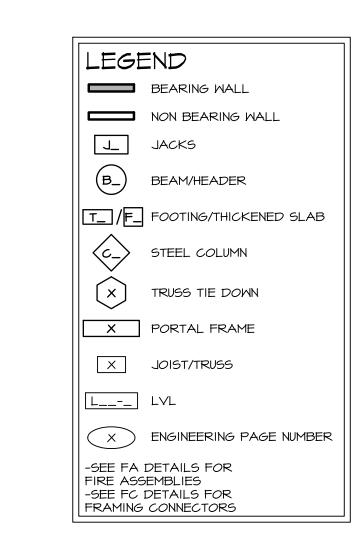

	ALL WINDOWS HAVE 7'-2 1/2" HEIGHT UNLESS OTHERWISE N	
F	LOOR PLAN NOTES	RYAN
1.	ALL HEADERS ARE (2) 2x6 w/ 2x4 WALLS OR 2x6 WALLS, UNLESS OTHERWISE NOTED.	(3) 2x6 w/
2.	ALL HEADERS TO HAVE (1) 2x4 OR 2x6 JACK STUD EACH END, UNLESS OTHERWISE NOTED.	
	MULTI-OPENING HEADERS TO HAVE (2) JACKS INTERMEDIATE BEARING, UNLESS OTHERWISE NO ADDITIONAL FLOOR SYSTEM BLOCKING OR COLOAD PATH JACKS ARE REQUIRED UNLESS OTH NOTED.	OTED. NO ONTINUOUS
3.	ALL EXTERIOR WALLS TO BE 4" W/ OSB OR 3 W/ LAMINATED FIBROUS STRUCTURAL SHEATHIN INTERIOR WALLS TO BE 3 1/2", UNLESS OTHERW	IG, ALL
4.	HATCHED AREAS INDICATE DROPPED CEILINGS DROPPED CEILINGS ARE I2" UNLESS OTHERWIS SEE ARCHITECTURAL DETAIL 8/IT-IB FOR 3/4" STOPPING AT BULKHEAD / CEILING PANELS	5. ALL E NOTED.
5.	SEE "BRACED WALL PANEL DETAIL SHEET" FOI WALL FRAMING LOCATIONS AND HEADER SIZES APPLICABLE.	
6.	SEE STANDARD DETAIL CATEGORY "IT" SHEETI INTERIOR TRIM DETAILS.	(S) FOR
٦.	SEE ARCHITECTURAL DETAIL SHEET "AD" FOR SPECIFIC INTERIOR TRIM OPTION TABLE.	HOUSE
8.	ALL HEADERS IN NON-BEARING WALLS SHALL SINGLE FLAT 2X4 OR 2X6 ATTACHED TO CRIP ABOVE, UNLESS OTHERWISE NOTED.	
9.	TANKED WATER HEATER SHOWN AS BASE CONTONAL TANKLESS WATER HEATER IS AVAIL LIEU OF TANKED WATER HEATER.	•
110	INTERIOR HEADER HEIGHT TO BE 6'-II" W/ 8'-0"	CEIL INGS

GYPSUM NOTES

AT GARAGE:

GYPSUM BOARD AT COMMON WALLS, CEILINGS, BEAM WRAPS AND SUPPORTS PER STANDARD DETAIL FA-I(b) FIRE ASSEMBLIES OR AS REQUIRED BY LOCAL CODE.

BETWEEN FRAME WALL AND CONCRETE WALL.


O. INTERIOR HEADER HEIGHT TO BE 6'-II" W/ 8'-O" CEILINGS AND 7'-II" W/ 9'-O" CEILINGS UNLESS OTHERWISE NOTED. I. BASEMENT FINISH DIMENSIONS ASSUME A I/2" GAP

2. ALL INTERIOR BEARING WALLS SHALL HAVE GYPSUM APPLIED TO AT LEAST ONE SIDE OR HAVE MID-HEIGHT BLOCKING INSTALLED.

AT STAIRS:


1/2" GYPSUM BOARD AT UNDERSIDE OF STAIRS AND WALLS IN CLOSET



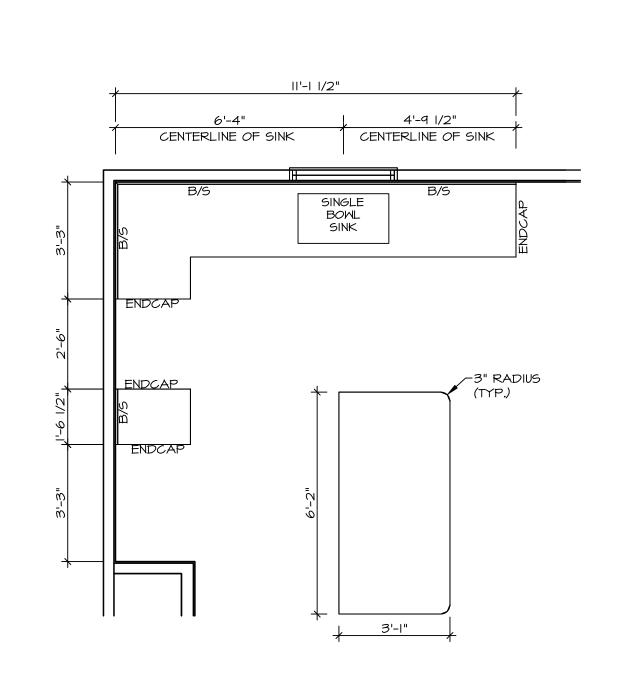


KITCHEN COUNTERTOP PLAN- (KC-3933)


A-II SCALE: 3/8" = 1'-0"

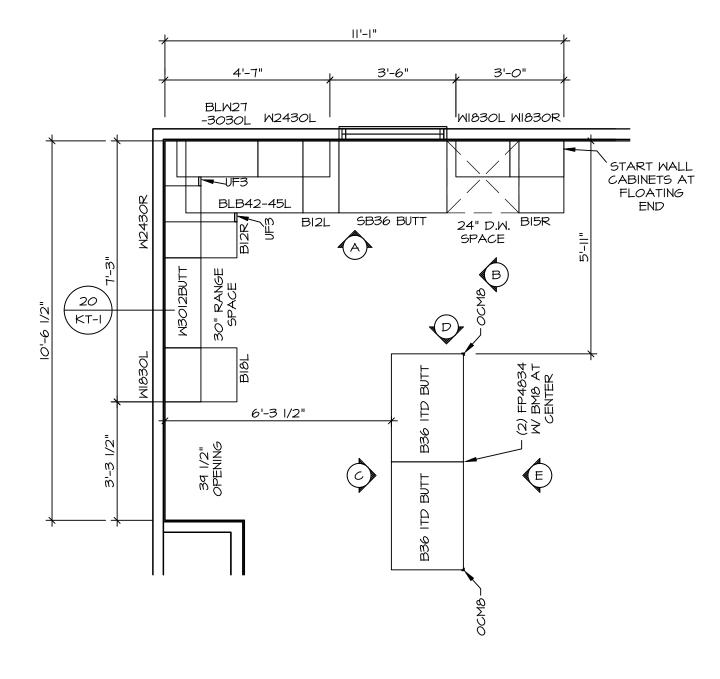


KITCHEN CABINET PLAN- (KC-3933)

SCALE: 3/8" = 1'-O"

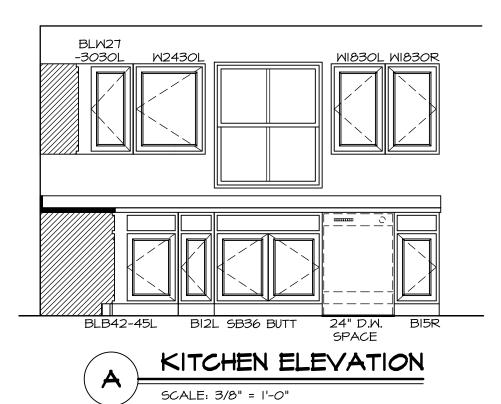


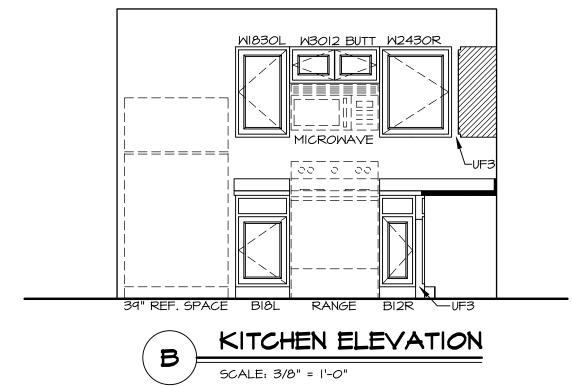

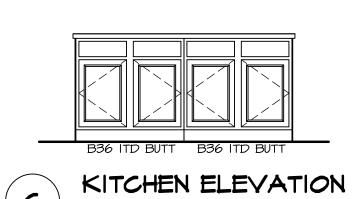

SCALE: 3/8" = 1'-0"



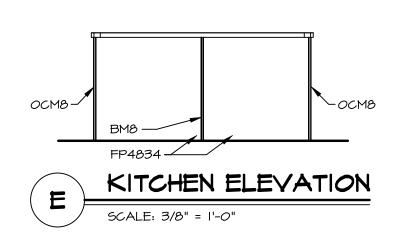

I. CABINET LAYOUT (S) ARE BASED ON FINISHED DIMENSIONS TO DRYWALL.

2. IF KITCHEN PLANS/ELEVATIONS CALL-OUT STANDARD MOLDING, REFER TO STANDARD

DETAIL (1/4/21) FOR REFER A CEMENT PAGES.


DETAIL (II/KT-I) FOR REPLACEMENT BASED


ALL (UF#) FILLERS ARE TO BE "TRIM TO FIT" UNLESS OTHERWISE NOTED.
 CABINET MUST BE SET, SHIMMED, LEVELED AND PLUMB W/ ADJOINING BASE CABINETS.
 SET PRE-FINISHED SCRIBE MOLDING AT CABINET BULKHEADS AND AT ENDS (WHERE CABINETS MEET DRYWALL.) PRE-FINISHED= SCRIBE MOLDING SHALL BE USED TO PAD OUT CABINET SIDES AT STILE FOR RETURN PIECES OF THE FACE-MOUNTED CABINET CROWN MOLDING.


NOTES:
CABINETS ARE NOT REPRESENTATIVE OF ALL STYLES AND ARE MEANT AS A GENERAL

DEPICTION OF THE INTENDED CABINET LAYOUT

ON CABINET STYLE.

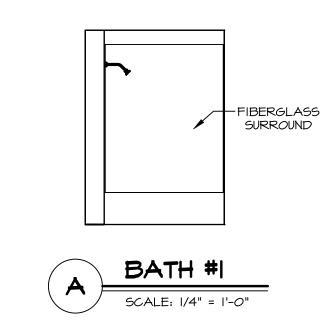

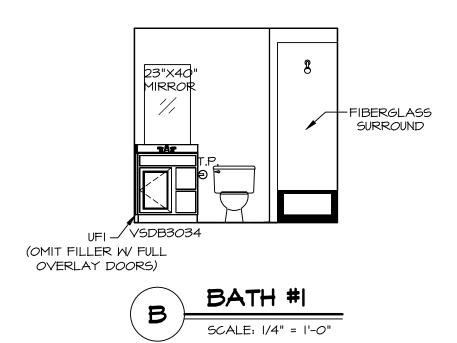


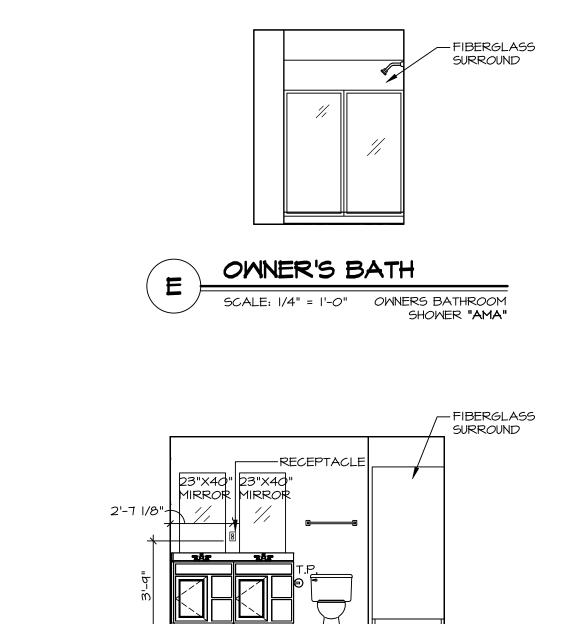

OWNER'S BATH


SCALE: 1/4" = 1'-0"

UFI (2) VSDB3034 (OMIT FILLER W FULL OVERLAY DOORS)

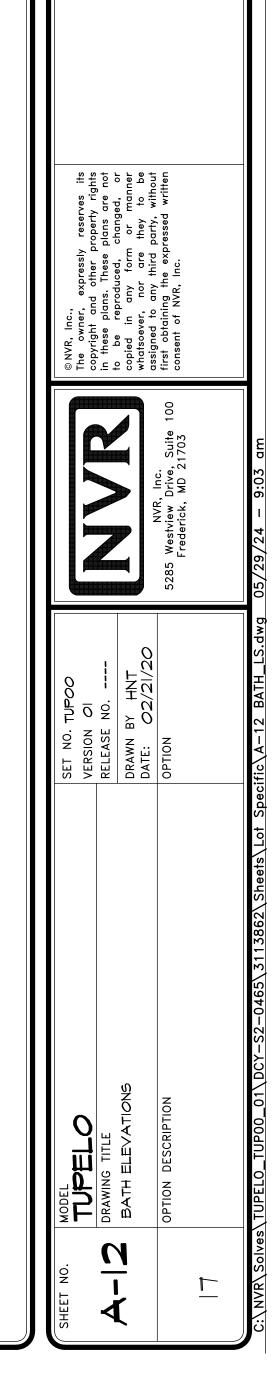

NOTES:

- TEMPERED GLASS SHOWER
 ENCLOSURE WITH SWING DOOR OR
 OPTIONAL SLIDING DOOR BY DIVISION.
 TUB ACCESS PANELS PROVIDED AS
 NEEDED, ALL MATERIALS BY DIVISION.
 ALL BATH ELEVATIONS SHOWN PER PLAN.
 ALL VANITIES WITH DRAWERS TO BE SET
 WITH DRAWERS ON RIGHT HAND SIDE.
 BATH ELEVATIONS ARE SHOWN PER PLAN.
 ALL DIMENSIONS SHOWN ON BATH
 ELEVATIONS ARE ROUGH FRAMING
 REFERENCES ONLY.

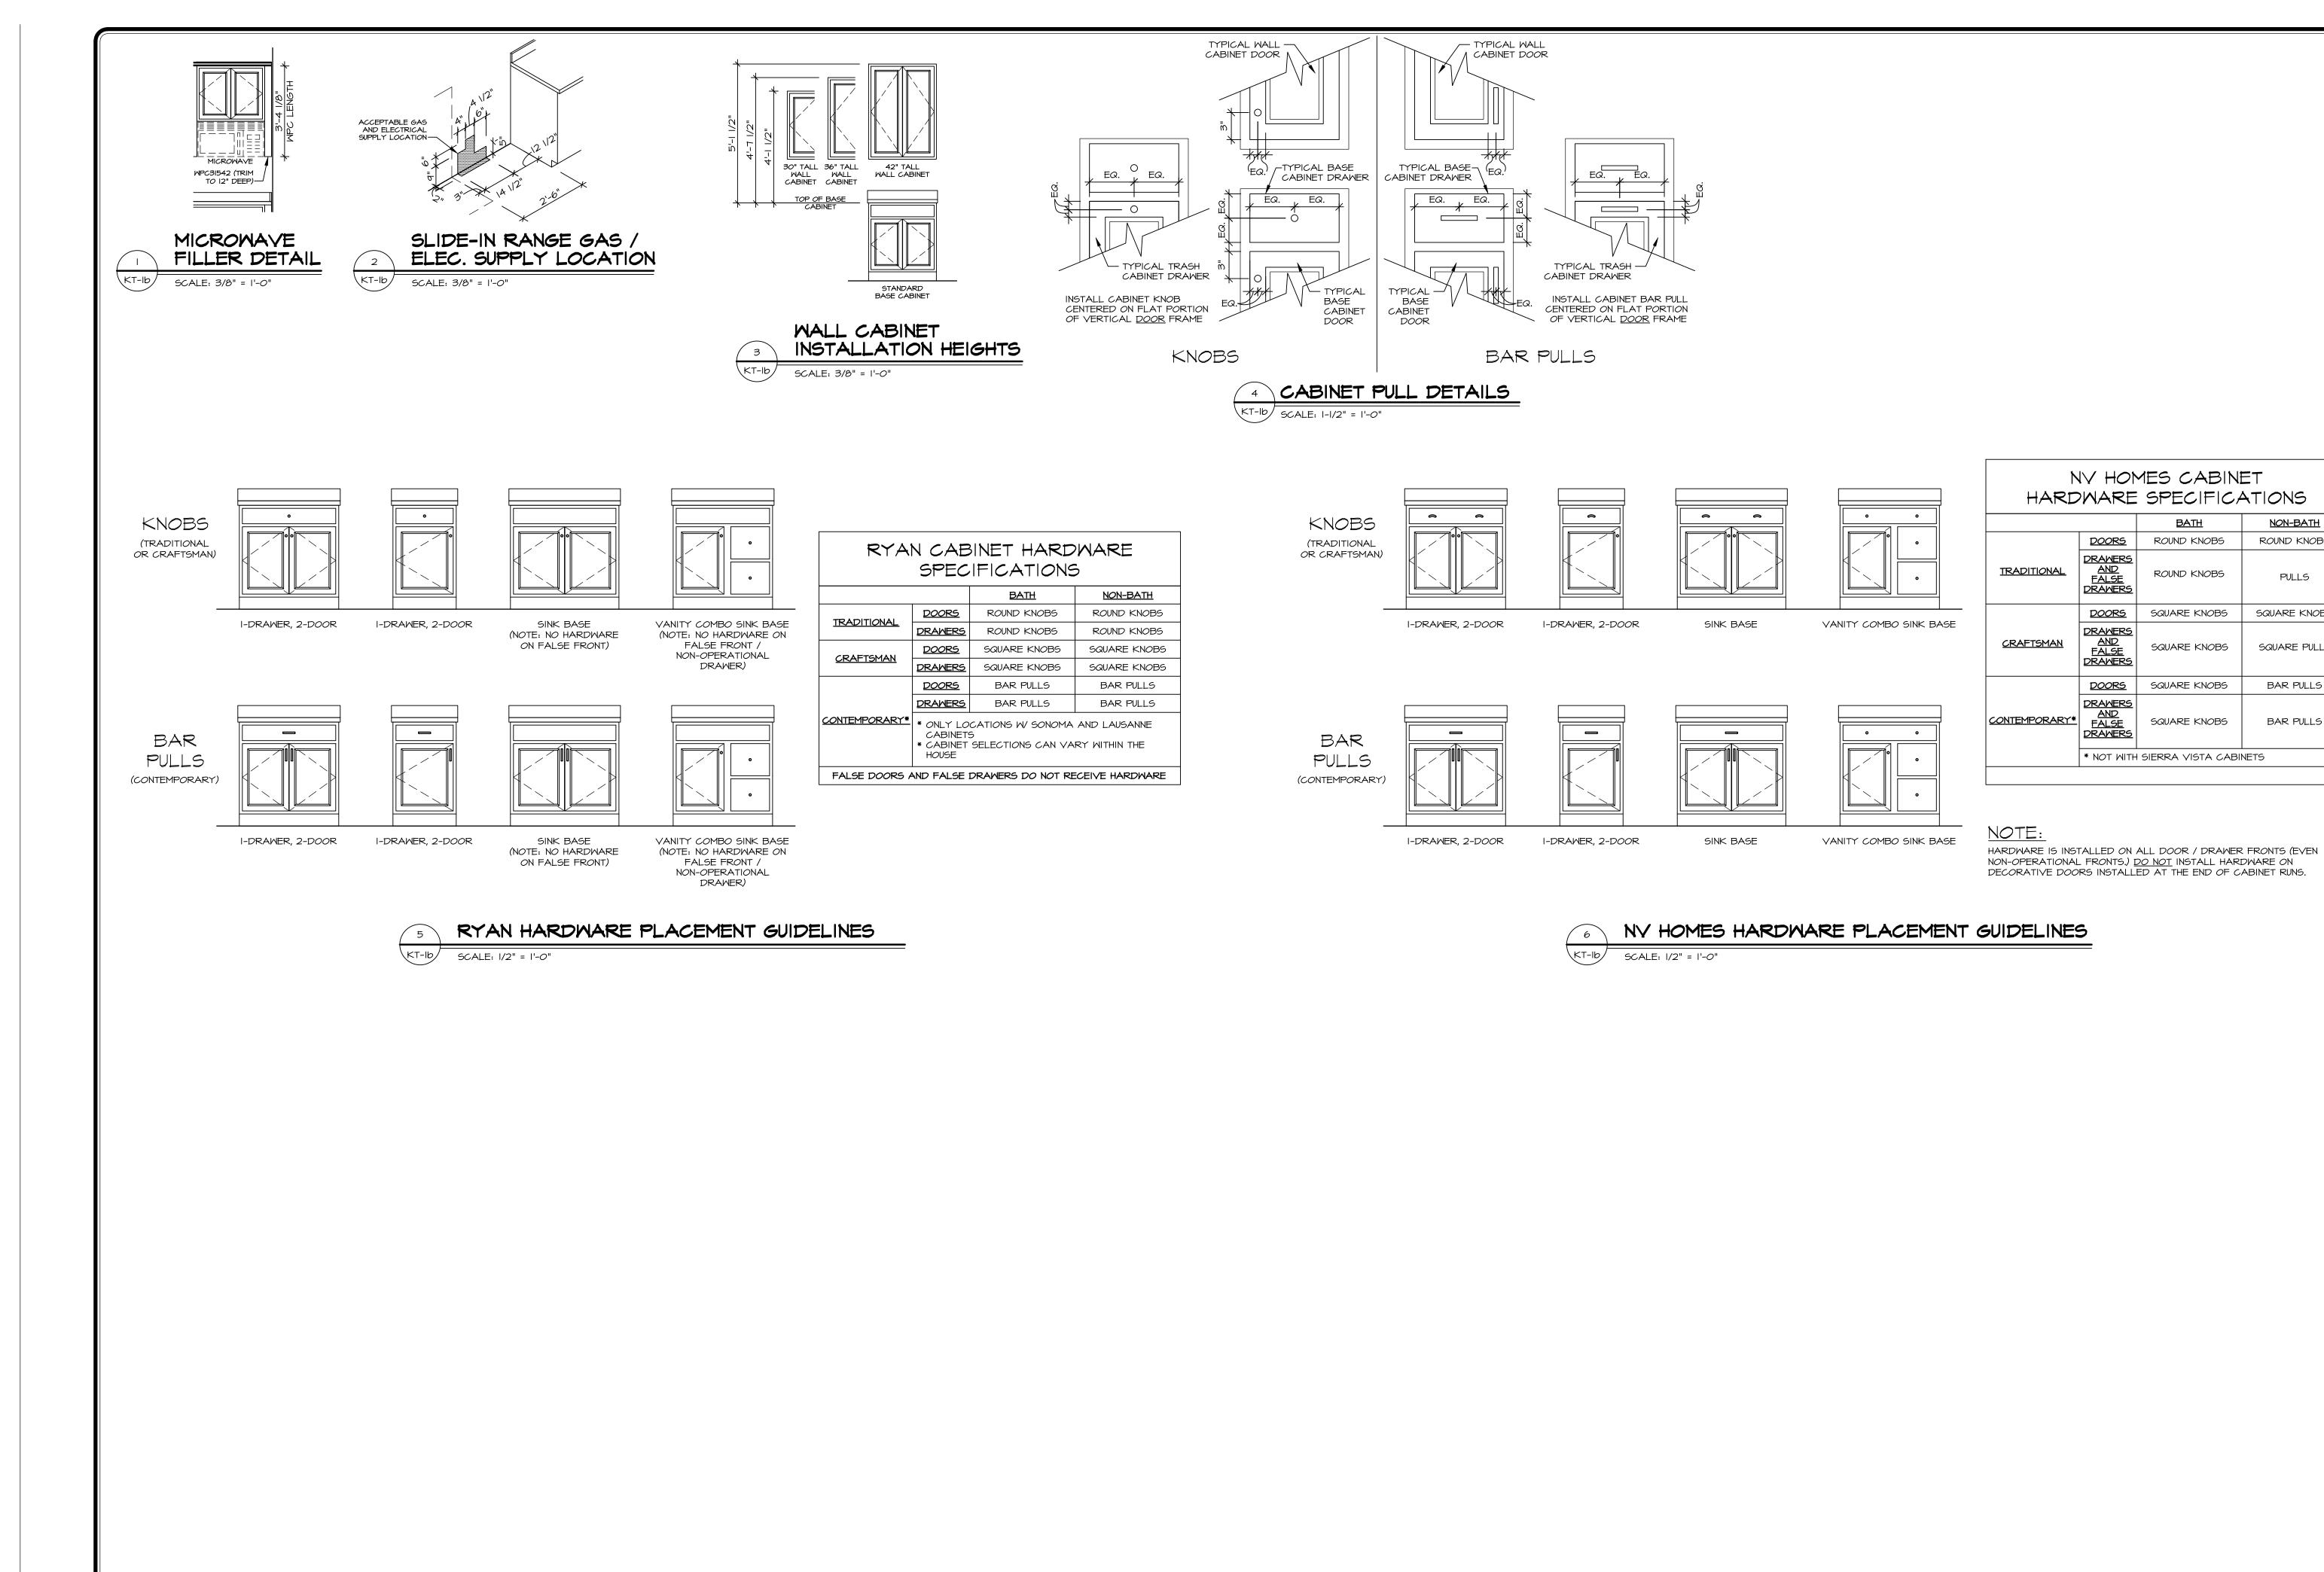

NON-BATH ROUND KNOBS

PULLS

SQUARE KNOBS

SQUARE PULLS

BAR PULLS

BAR PULLS