

S2 466 5900 CRESTING DRIVE MIDDLETOWN, OH 45042

2 Story Basement - 3 pc rough basement 2 hose bibs - no valves required Vent Kitchen ice maker 2 tubs WATER HEATER ELECTRIC 40 GALLON Inside Water Meter setup

Gas Furnace

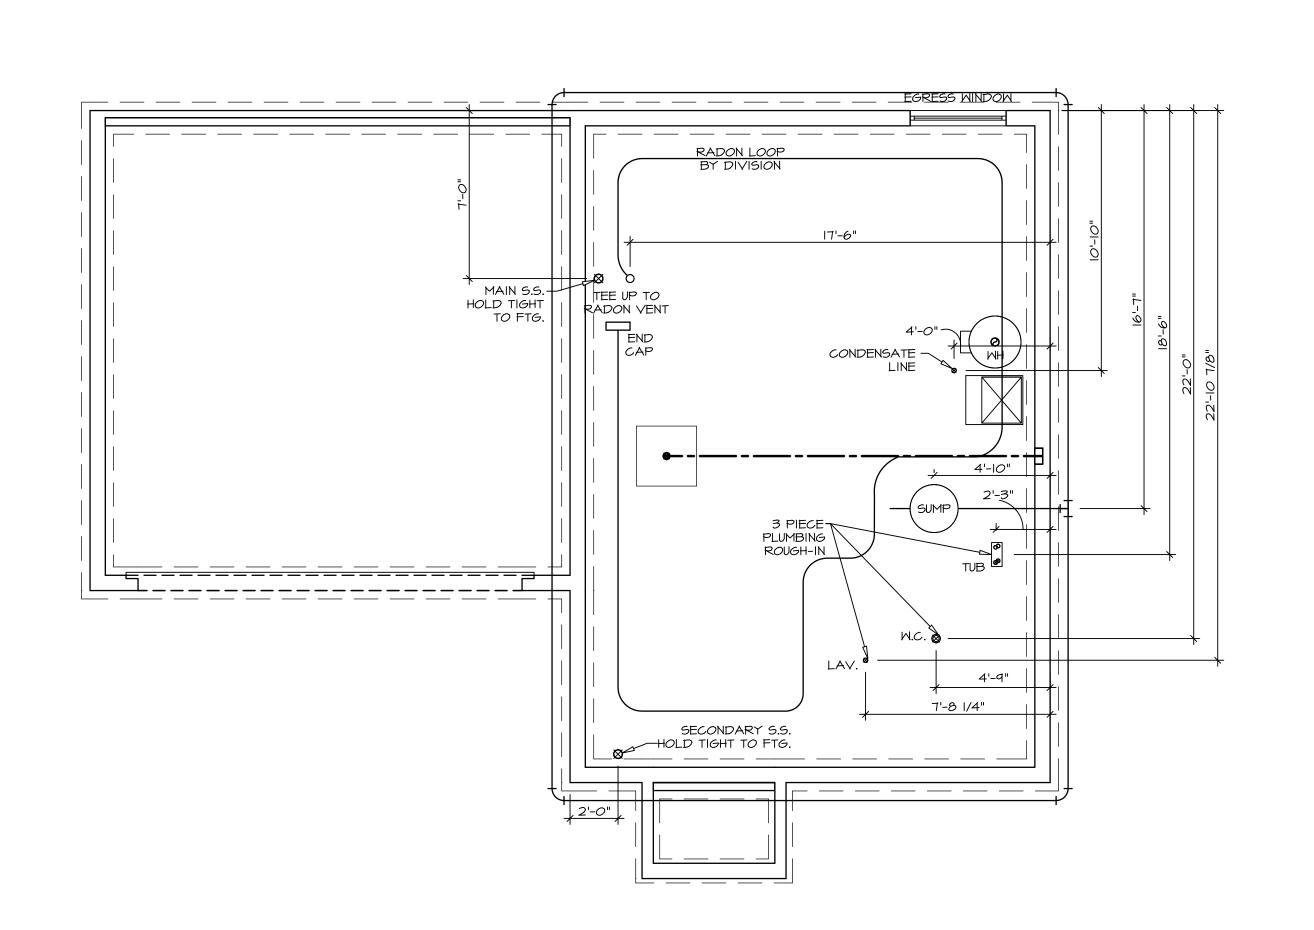

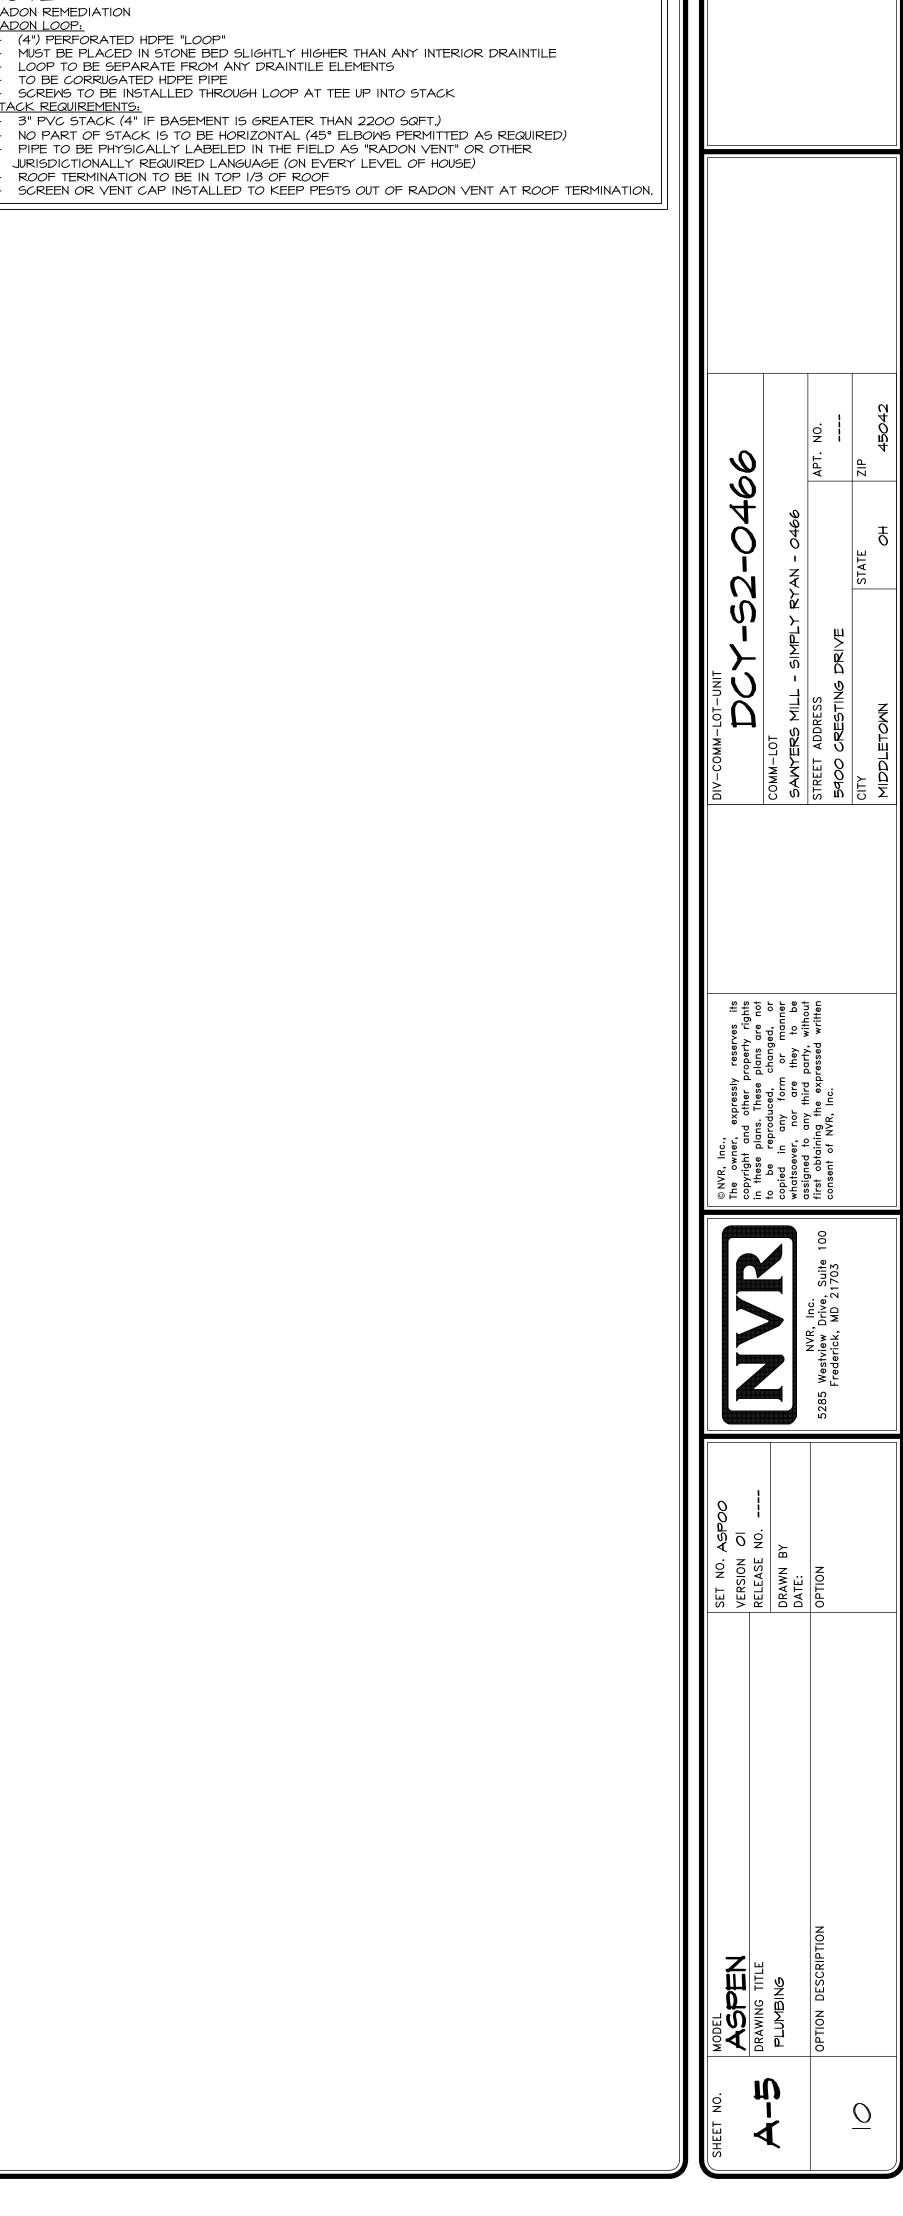

NOTE RADON REMEDIATION

STACK REQUIREMENTS:

- (4") PERFORATED HDPE "LOOP"

- MUST BE PLACED IN STONE BED SLIGHTLY HIGHER THAN ANY INTERIOR DRAINTILE

- LOOP TO BE SEPARATE FROM ANY DRAINTILE ELEMENTS


- TO BE CORRUGATED HDPE PIPE

- SCREWS TO BE INSTALLED THROUGH LOOP AT TEE UP INTO STACK


- 3" PVC STACK (4" IF BASEMENT IS GREATER THAN 2200 SQFT.)
- NO PART OF STACK IS TO BE HORIZONTAL (45° ELBOWS PERMITTED AS REQUIRED)
- PIPE TO BE PHYSICALLY LABELED IN THE FIELD AS "RADON VENT" OR OTHER

JURISDICTIONALLY REQUIRED LANGUAGE (ON EVERY LEVEL OF HOUSE)

RADON LOOP:

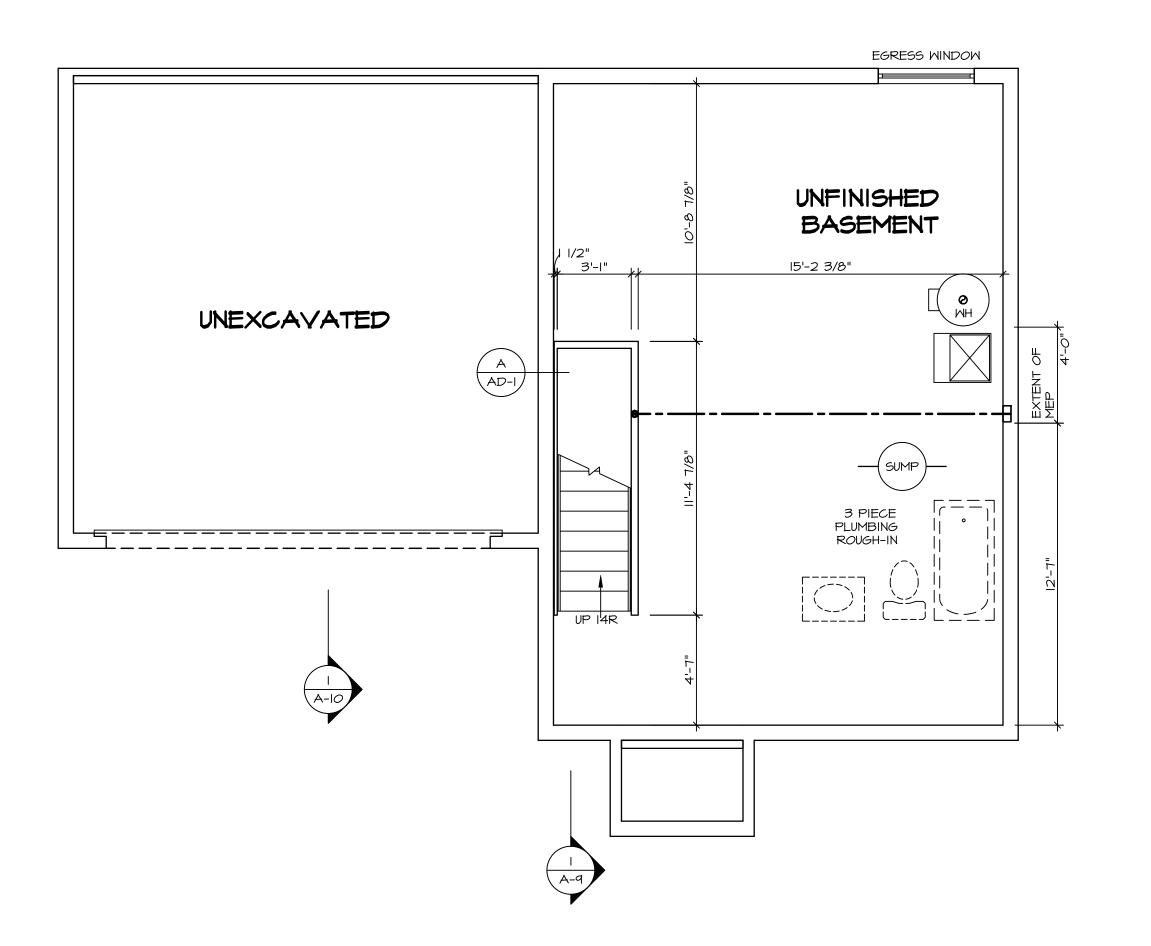



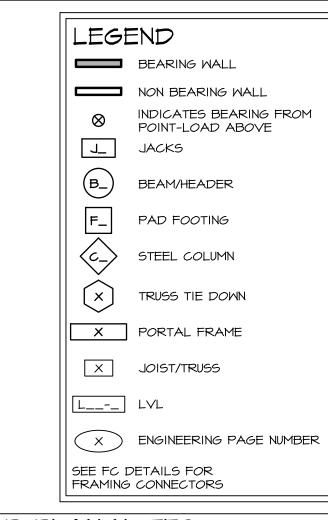

# FLOOR PLAN NOTES

ALL HEADERS ARE (2) 2x6 w/ 2x4 WALLS OR (3) 2x6 w/ 2x6 WALLS, UNLESS OTHERWISE NOTED.
 ALL HEADERS TO HAVE (1) 2x4 OR 2x6 JACK AND KING

STUD EACH END, UNLESS OTHERWISE NOTED.
MULTI-OPENING HEADERS TO HAVE (2) JACKS AT
INTERMEDIATE BEARING, UNLESS OTHERWISE NOTED. NO
ADDITIONAL FLOOR SYSTEM BLOCKING OR CONTINUOUS
LOAD PATH JACKS ARE REQUIRED UNLESS OTHERWISE

NOTED.

3. ALL EXTERIOR WALLS TO BE 4" W/ OSB OR 3 1/2"
W/ LAMINATED FIBROUS STRUCTURAL SHEATHING, ALL

INTERIOR WALLS TO BE 3 I/2", UNLESS OTHERWISE NOTED.

4. HATCHED AREAS INDICATE DROPPED CEILINGS. ALL DROPPED CEILINGS ARE I2" UNLESS OTHERWISE NOTED.

5. SEE "BRACED WALL PANEL DETAIL SHEET" FOR SPECIAL WALL FRAMING LOCATIONS AND HEADER SIZES, IF APPLICABLE.

APPLICABLE.
6. SEE STANDARD DETAIL CATEGORY "IT" SHEET(S) FOR INTERIOR TRIM DETAILS.
7. SEE ARCHITECTURAL DETAIL SHEET "AD" FOR HOUSE

SPECIFIC INTERIOR TRIM OPTION TABLE.

8. ALL WINDOWS HAVE 7'-0 I/2" HEADER HEIGHT UNLESS OTHERWISE NOTED.

9. ALL HEADERS IN NON-BEARING WALLS SHALL BE A SINGLE FLAT 2X4 OR 2X6 ATTACHED TO CRIPPLES

ABOVE, UNLESS OTHERWISE NOTED.

10. TANKED WATER HEATER SHOWN AS BASE CONDITION,
OPTIONAL TANKLESS WATER HEATER IS AVAILABLE IN
LIEU OF TANKED WATER HEATER.

### GYPSUM NOTES

AT GARAGE:

GYPSUM BOARD AT COMMON WALLS, CEILINGS, BEAM WRAPS AND SUPPORTS PER STANDARD DETAIL **FA-I(b)** FIRE ASSEMBLIES OR AS REQUIRED BY LOCAL CODE.

AT STAIRS:

1/2" GYPSUM BOARD AT UNDERSIDE OF STAIRS AND WALLS

BASEMENT JACK SCHEDULE					
IDENTIFIER	DESCRIPTION	ENG. NUM.	REMARKS		

copyright and off in these plans. The to be reproduce copied in any whatsoever, nor assigned to any first obtaining the frederick, MD 21703

BY 5285 Westvie Frederic

VERSION OI RELEASE NO.


DRAWN BY DATE:


OPTION

E FLOOR PLAN RIPTION

DRAWING TITLE
BASEMENT FLOO

**D-0** 

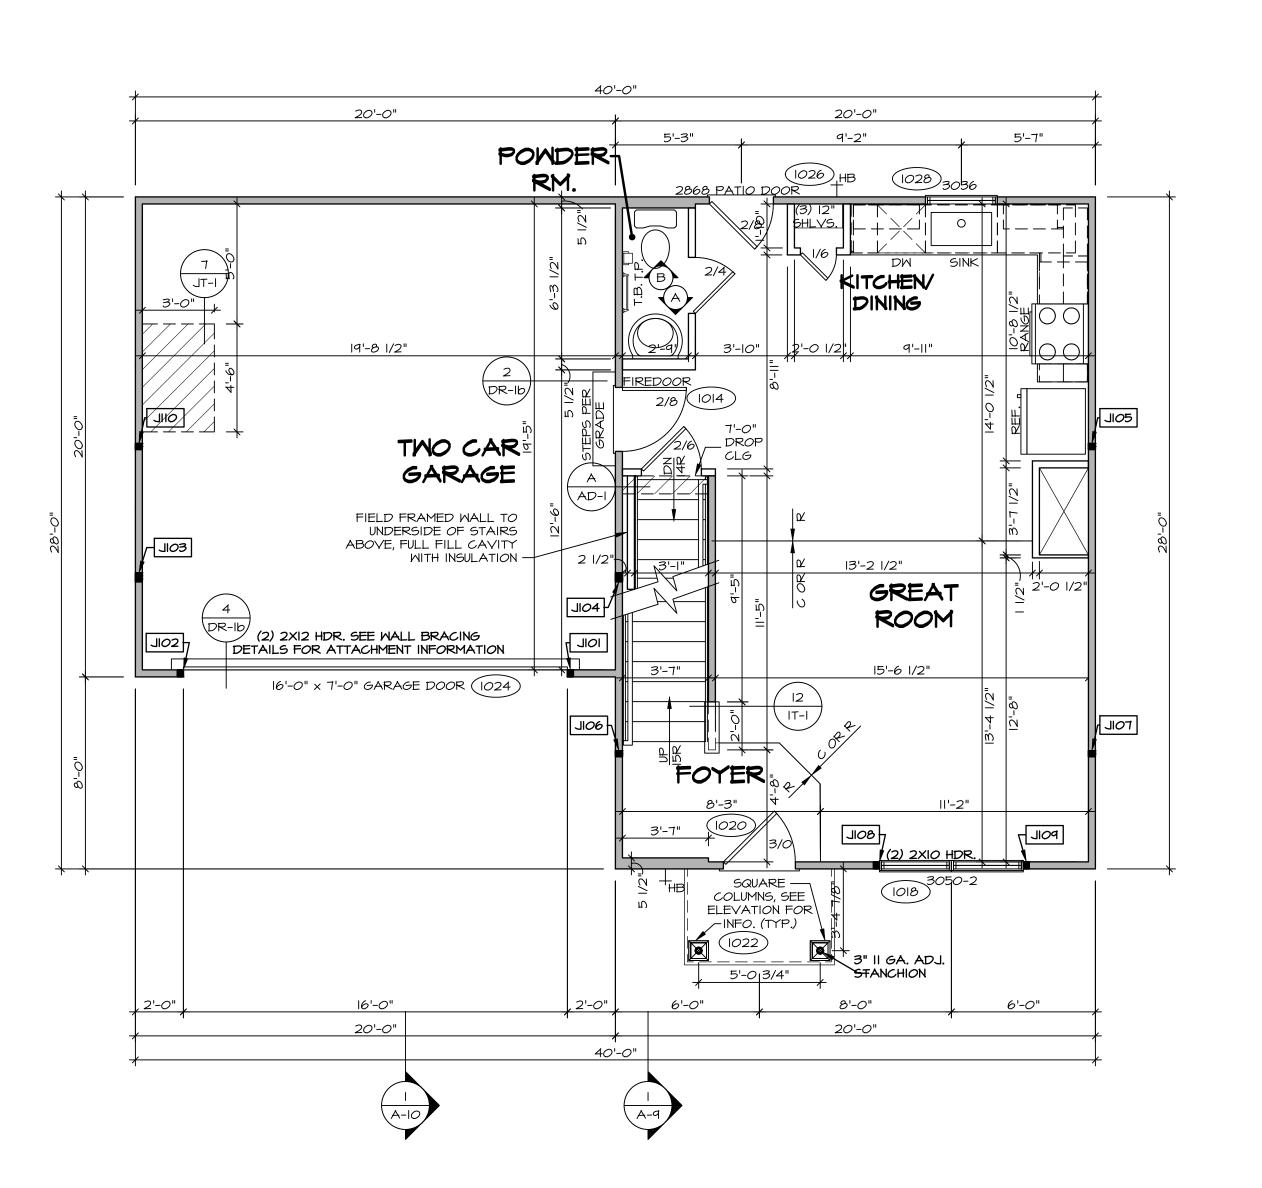

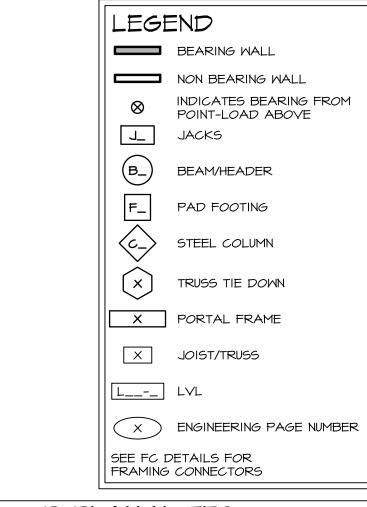

#### FLOOR PLAN NOTES

ALL HEADERS ARE (2) 2x6 w/ 2x4 WALLS OR (3) 2x6 w/ 2x6 WALLS, UNLESS OTHERWISE NOTED.
 ALL HEADERS TO HAVE (I) 2x4 OR 2x6 JACK AND KING STUD EACH END, UNLESS OTHERWISE NOTED.
 MULTI-OPENING HEADERS TO HAVE (2) JACKS AT INTERMEDIATE BEARING, UNLESS OTHERWISE NOTED. NO ADDITIONAL FLOOR SYSTEM BLOCKING OR CONTINUOUS

LOAD PATH JACKS ARE REQUIRED UNLESS OTHERWISE NOTED.

3. ALL EXTERIOR WALLS TO BE 4" W/ OSB OR 3 1/2"
W/ LAMINATED FIBROUS STRUCTURAL SHEATHING, ALL

INTERIOR WALLS TO BE 3 I/2", UNLESS OTHERWISE NOTED.

4. HATCHED AREAS INDICATE DROPPED CEILINGS. ALL DROPPED CEILINGS ARE I2" UNLESS OTHERWISE NOTED.

5. SEE "BRACED WALL PANEL DETAIL SHEET" FOR SPECIAL WALL FRAMING LOCATIONS AND HEADER SIZES, IF APPLICABLE.

D. SEE STANDARD DETAIL CATEGORY "IT" SHEET(S) FOR INTERIOR TRIM DETAILS.

SEE ARCHITECTURAL DETAIL SHEET "AD" FOR HOUSE SPECIFIC INTERIOR TRIM OPTION TABLE.
 ALL WINDOWS HAVE 7'-O I/2" HEADER HEIGHT UNLESS OTHERWISE NOTED.
 ALL HEADERS IN NON-BEARING WALLS SHALL BE A

SINGLE FLAT 2X4 OR 2X6 ATTACHED TO CRIPPLES ABOVE, UNLESS OTHERWISE NOTED.

IO. TANKED WATER HEATER SHOWN AS BASE CONDITION, OPTIONAL TANKLESS WATER HEATER IS AVAILABLE IN

### GYPSUM NOTES

LIEU OF TANKED WATER HEATER.

AT GARAGE:

GYPSUM BOARD AT COMMON WALLS, CEILINGS, BEAM WRAPS AND SUPPORTS PER STANDARD DETAIL FA-I(b) FIRE ASSEMBLIES OR AS REQUIRED BY LOCAL CODE.

AT STAIRS:


1/2" GYPSUM BOARD AT UNDERSIDE OF STAIRS AND WALLS IN CLOSET

FIRST FLOOR JACK SCHEDULE					
IDENTIFIER	DESCRIPTION	ENG. NUM.	REMARKS		
IOIL	JACK - (2) 2X4 SPF STUD GRADE	1024			
JI02	JACK - (2) 2X4 SPF STUD GRADE	1024			
SOIL	JACK <i>- (3)</i> 2X4 SP#I	1016			
JI04	JACK <i>- (3)</i> 2X4 SP#I	1016			
JI05	JACK - (2) 2X4 SPF STUD GRADE	1012			
JI06	JACK - (2) 2X4 SPF STUD GRADE	1012			
TOIL	JACK - (2) 2X4 SPF STUD GRADE	1012			
80IL	JACK - (2) 2X4 SPF STUD GRADE	1018			
POIL	JACK - (2) 2X4 SPF STUD GRADE	1018			
OIL OI	JACK - (2) 2X4 SPF STUD GRADE	1012			


FIELD INSTALLED FIRST FLOOR BEAM/HEADER SCHEDULE						
IDENTIFIER	DESCRIPTION	LENGTH	ENG. NUM.	REMARKS		

FIRST FLOOR PLAN

SCALE: 1/4" = 1'-0"

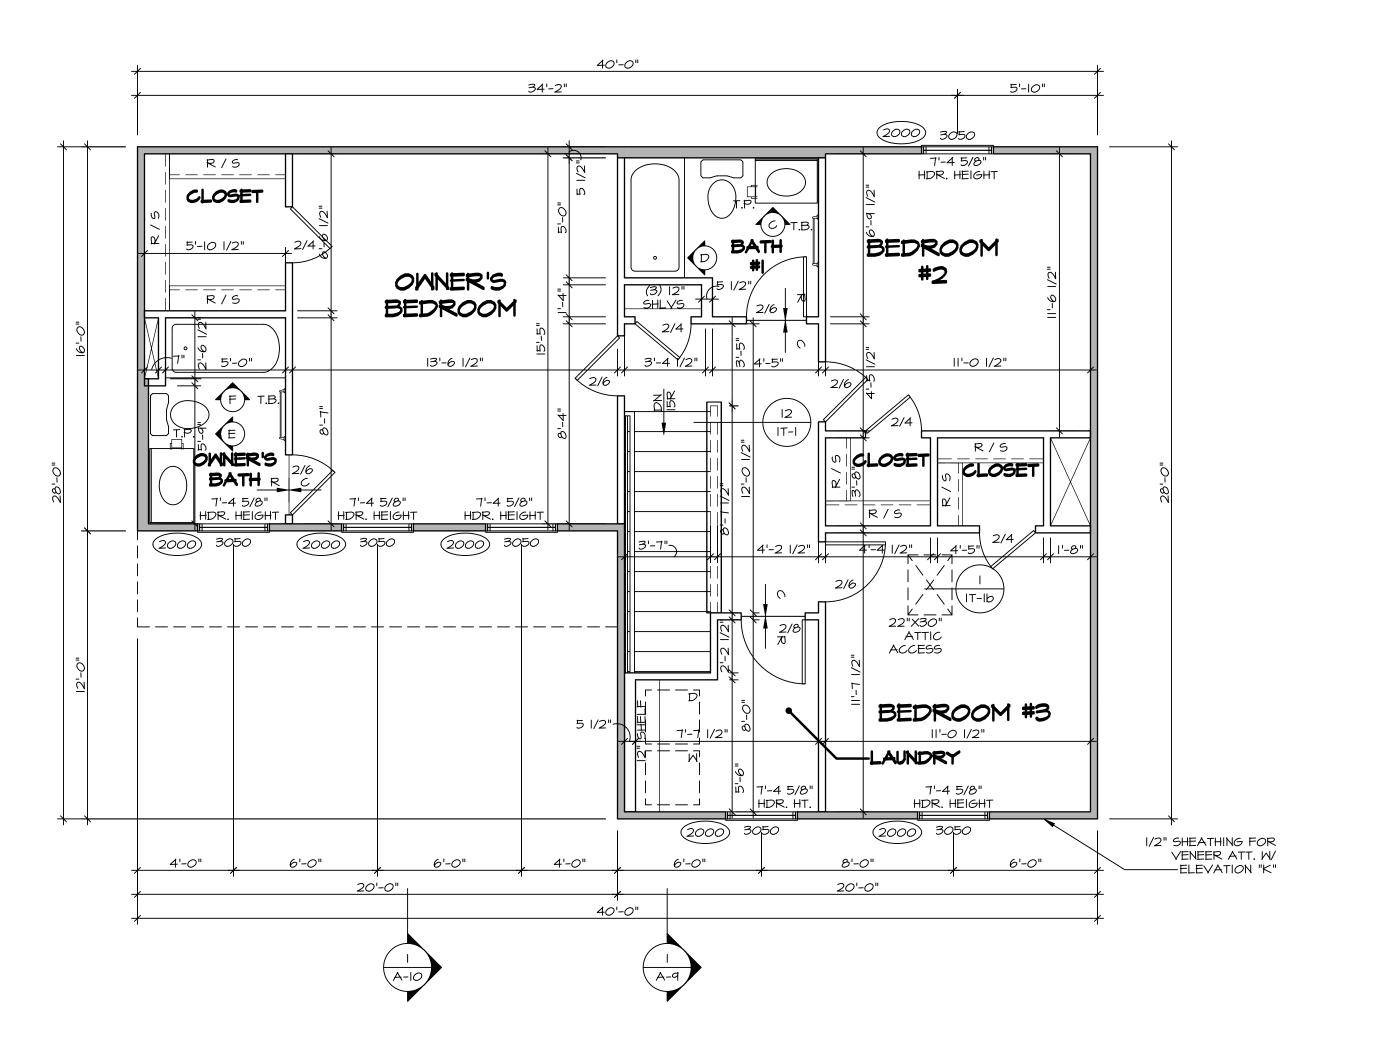



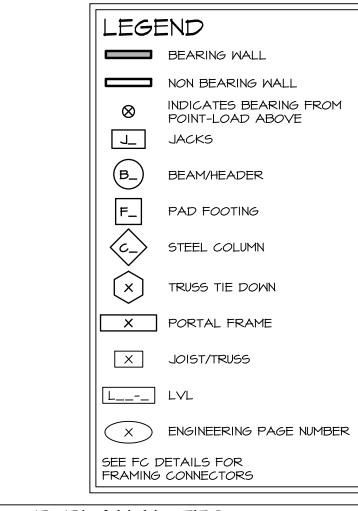

#### FLOOR PLAN NOTES

ALL HEADERS ARE (2) 2x6 w/ 2x4 WALLS OR (3) 2x6 w/ 2x6 WALLS, UNLESS OTHERWISE NOTED.
 ALL HEADERS TO HAVE (I) 2x4 OR 2x6 JACK AND KING STUD EACH END, UNLESS OTHERWISE NOTED.
 MULTI-OPENING HEADERS TO HAVE (2) JACKS AT INTERMEDIATE BEARING, UNLESS OTHERWISE NOTED. NO ADDITIONAL FLOOR SYSTEM BLOCKING OR CONTINUOUS LOAD PATH JACKS ARE REQUIRED UNLESS OTHERWISE NOTED.

NOTED.

3. ALL EXTERIOR WALLS TO BE 4" W/ OSB OR 3 1/2"
W/ LAMINATED FIBROUS STRUCTURAL SHEATHING, ALL
INTERIOR WALLS TO BE 3 1/2", UNLESS OTHERWISE NOTED.

INTERIOR WALLS TO BE 3 1/2", UNLESS OTHERWISE NOTED
4. HATCHED AREAS INDICATE DROPPED CEILINGS. ALL DROPPED CEILINGS ARE 12" UNLESS OTHERWISE NOTED.
5. SEE "BRACED WALL PANEL DETAIL SHEET" FOR SPECIAL WALL FRAMING LOCATIONS AND HEADER SIZES, IF APPLICABLE.
6. SEE STANDARD DETAIL CATEGORY "IT" SHEET(S) FOR

SEE STANDARD DETAIL CATEGORY "IT" SHEET(S) FOR INTERIOR TRIM DETAILS.
 SEE ARCHITECTURAL DETAIL SHEET "AD" FOR HOUSE SPECIFIC INTERIOR TRIM OPTION TABLE.
 ALL WINDOWS HAVE 7'-0 I/2" HEADER HEIGHT UNLESS OTHERWISE NOTED.
 ALL HEADERS IN NON-BEARING WALLS SHALL BE A

ABOVE, UNLESS OTHERWISE NOTED.

10. TANKED WATER HEATER SHOWN AS BASE CONDITION,
OPTIONAL TANKLESS WATER HEATER IS AVAILABLE IN
LIEU OF TANKED WATER HEATER.

SINGLE FLAT 2X4 OR 2X6 ATTACHED TO CRIPPLES

### GYPSUM NOTES

AT GARAGE:

GYPSUM BOARD AT COMMON WALLS, CEILINGS, BEAM WRAPS AND SUPPORTS PER STANDARD DETAIL FA-I(b) FIRE ASSEMBLIES OR AS REQUIRED BY LOCAL CODE.

AT STAIRS:

1/2" GYPSUM BOARD AT UNDERSIDE OF STAIRS AND WALLS

© NVR, Inc.,

The owner, expressly reserves its copyright and other property rights in these plans. These plans are not to be reproduced, changed, or copied in any form or manner whatsoever, nor are they to be assigned to any third party, without first obtaining the expressed written

\*\*Drive\*\* Suite 100\*\*

\*\*Drive\*\* Su

NVR, Inc. 5285 Westview Drive, Suite 100 Frederick, MD 21703


VERSION OI
RELEASE NO. ---DRAWN BY
DATE:
OPTION

TITLE


D FLOOR PLAN

DESCRIPTION


DRAWING TITI SECOND F.

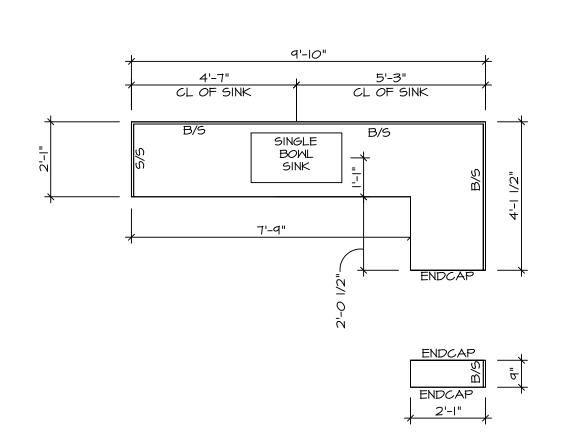


KITCHEN COUNTERTOP PLAN KC - 3639 SCALE: 3/8" = 1'-0" A-12

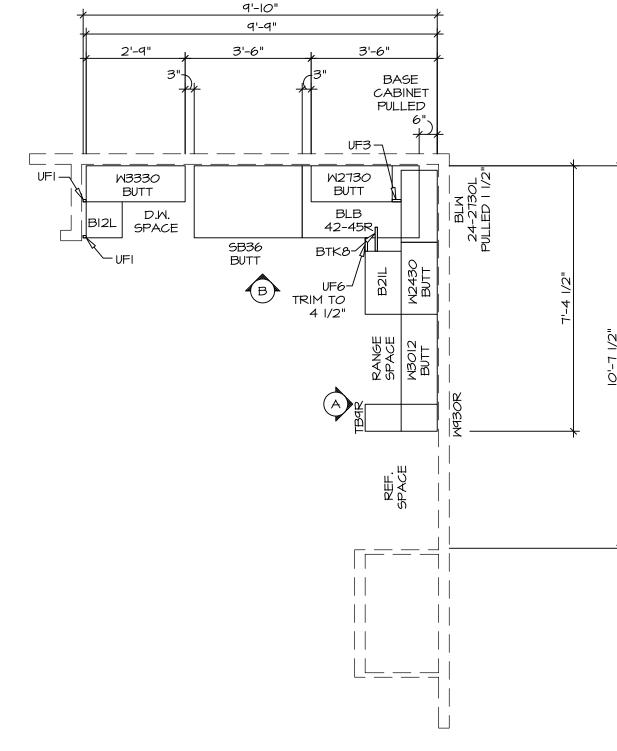

KITCHEN CABINET PLAN KC - 3639 SCALE: 3/8" = 1'-0" A-12

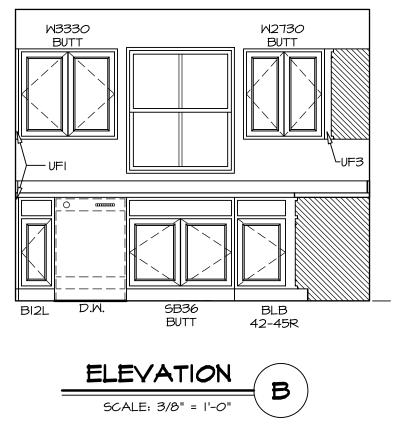

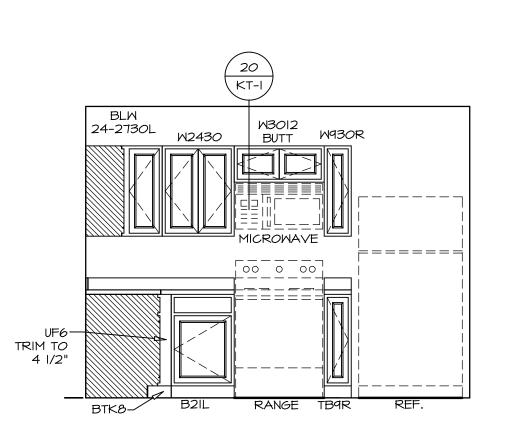



NOTES:
CABINETS ARE NOT REPRESENTATIVE OF ALL
STYLES AND ARE MEANT AS A GENERAL
DEPICTION OF THE INTENDED CABINET LAYOUT

## NOTES:

- I. CABINET LAYOUT (S) ARE BASED ON FINISHED DIMENSIONS TO DRYWALL.

  2. IF KITCHEN PLANS/ELEVATIONS CALL-OUT STANDARD MOLDING, REFER TO STANDARD DETAIL (II/KT-I) FOR REPLACEMENT BASED ON CABINET STYLE.

  2. ALL (IIE#) FILEPS ARE TO BE "TRIM TO FIT"
- 3. ALL (UF#) FILLERS ARE TO BE "TRIM TO FIT" UNLESS OTHERWISE NOTED.

  4. CABINET MUST BE SET, SHIMMED, LEVELED
- AND PLUMB W/ ADJOINING BASE CABINETS.

  5. SET PRE-FINISHED SCRIBE MOLDING AT CABINET BULKHEADS AND AT ENDS (WHERE CABINETS MEET DRYWALL.) PRE-FINISHED SCRIBE MOLDING SHALL BE USED TO PAD OUT CABINET SIDES AT STILE FOR RETURN PIECES OF THE FACE-MOUNTED CABINET CROWN MOLDING.

