
S2 92 5873 HAYDEN DRIVE MIDDLETOWN, OH 45042

2 Story Basement
2 hose bibs - no valves required
AA on kit
ice maker
1 tub
1 shower
WATER HEATER ELECTRIC 50 GALLON
Inside Water Meter setup

Gas Furnace



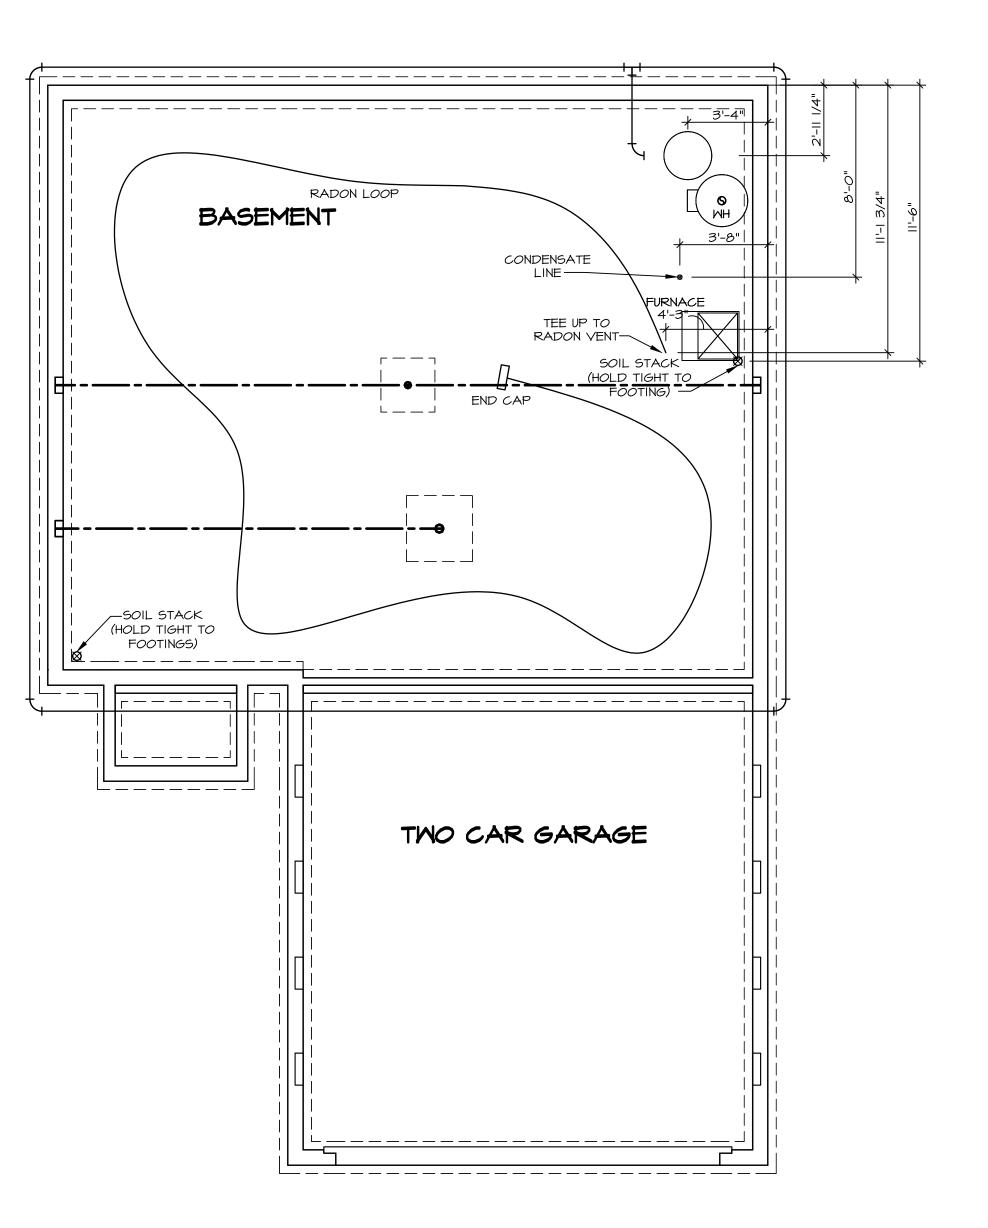

PLUMBING NOTES: RADON REMEDIATION

RADON LOOP:

- (4") PERFORATED HDPE "LOOP"

- MUST BE PLACED IN STONE BED SLIGHTLY HIGHER THAN ANY INTERIOR DRAINTILE


- LOOP TO BE SEPARATE FROM DRAINTILE ELEMENTS


- TO BE CORRUGATED HDPE PIPE
- SCREWS TO BE INSTALLED THROUGH LOOP AT TEE UP INTO STACK
STACK REQUIREMENTS:

- 3" PVC STACK (4" IF BASEMENT IS GREATER THAN 2200 SQFT.)
- NO PART OF STACK IS TO BE HORIZONTAL (45° ELBOWS PERMITTED AS REQUIRED)
- PIPE TO BE PHYSICALLY LABELED IN THE FIELD AS "RADON VENT" OR OTHER
JURISDICTIONAL TO BE IN TABLICA (5° ELBOWS)

ROOF TERMINATION TO BE IN TOP 1/3 OF ROOF
SCREEN OR VENT CAP INSTALLED TO KEEP PESTS OUT OF RADON VENT AT ROOF TERMINATION.

NO.	MODEL	SET NO. LILOO		© NVR, Inc., The owner, expressly reserves its	DIV-COMM-LOT-UNIT	-LOT-UNIT	7	
11	DRAWING TITLE	RELEASE NO		copyrignt and other property rights in these plans. These plans are not	7		<u> </u>	
J)	PLUMBING	DRAWN BY		to be reproduced, changed, or copied in any form or manner whatsoever, nor are they to be	COMM-LOT SAMYERS MILL - SIMPLY RYAN - 0092	7 RY AN - 0092		
	OPTION DESCRIPTION	OPTION	NVR, Inc. 5285 Westview Drive. Suite 100	assigned to any third party, without first obtaining the expressed written	STREET ADDRESS		APT. NO.	
			Frederick, MD 21703	consent of NVR, Inc.	5873 HAYDEN DRIVE			
1					CITY	STATE	ZIP	
					MIDDLETOWN	₹	45042	

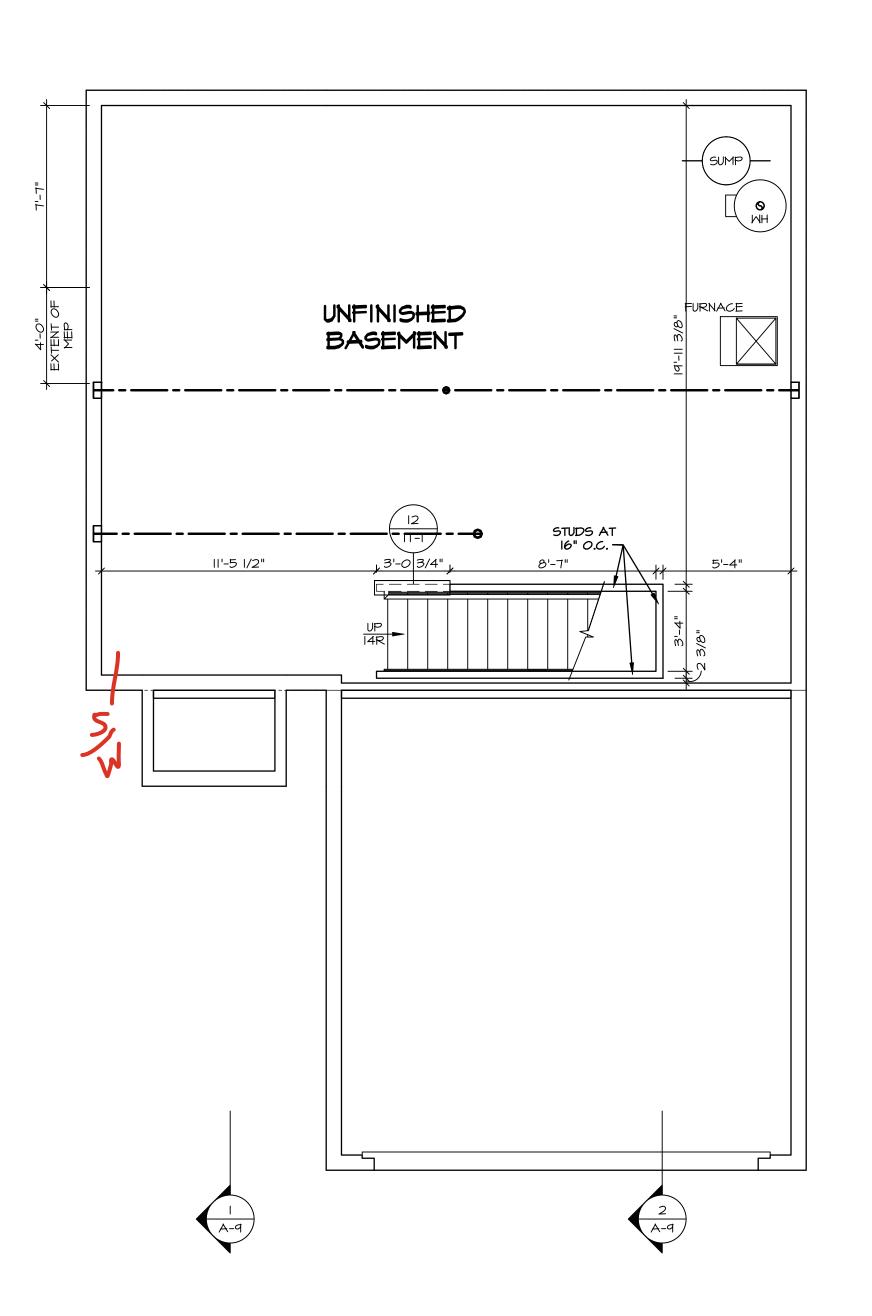

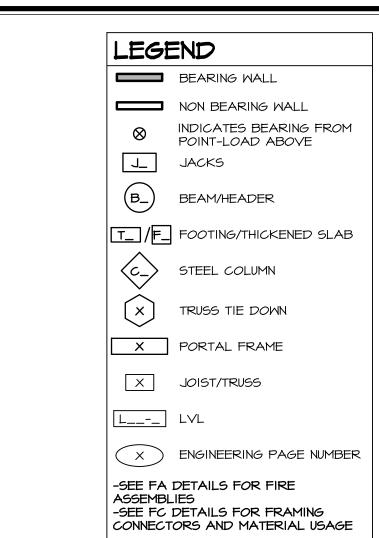

FLOOR PLAN NOTES:

- ALL HEADERS ARE (2) 2x6 w/ 2x4 WALLS OR (3) 2x6 w/ 2x6 WALLS, UNLESS OTHERWISE NOTED. ALL HEADERS TO HAVE (1) 2x4 OR 2x6 JACK AND KING STUD EACH END, UNLESS OTHERWISE NOTED. MULTI-OPENING HEADERS TO HAVE (2) JACKS AT INTERMEDIATE BEARING, UNLESS OTHERWISE NOTED. NO ADDITIONAL FLOOR SYSTEM BLOCKING OR CONTINUOUS LOAD PATH JACKS ARE REQUIRED UNLESS OTHERWISE NOTED.
- ALL EXTERIOR WALLS TO BE 4" OR 6" AND ALL INTERIOR WALLS TO BE 3 1/2", UNLESS OTHERWISE NOTED. HATCHED AREAS INDICATE DROPPED CEILINGS. ALL DROPPED CEILINGS ARE 12" UNLESS OTHERWISE NOTED. SEE ARCHITECTURAL DETAIL 8/IT-IB FOR 3/4" FIRE STOPPING AT BULKHEAD / CEILING PANELS SEE "BRACED WALL PANEL DETAIL SHEET" FOR SPECIAL
- WALL FRAMING LOCATIONS AND HEADER SIZES, IF APPLICABLE.
- SEE STANDARD DETAIL CATEGORY "IT" SHEET(S) FOR INTERIOR TRIM DETAILS. SEE ARCHITECTURAL DETAIL SHEET "AD" FOR HOUSE
- SPECIFIC INTERIOR TRIM OPTION TABLE.

 ALL HEADERS IN NON-BEARING WALLS SHALL BE A SINGLE FLAT 2X4 OR 2X6 ATTACHED TO CRIPPLES
- ABOVE, UNLESS OTHERWISE NOTED.

 TANKED WATER HEATER SHOWN AS BASE CONDITION, OPTIONAL TANKLESS WATER HEATER IS AVAILABLE IN
- LIEU OF TANKED WATER HEATER.

 O. INTERIOR HEADER HEIGHT FOR 8' CEILING WILL BE 6'-II",
- 9' CEILING WILL BE 7'-II", IO' CEILING WILL BE 8'-3", UNLESS OTHERWISE NOTED. BASEMENT FINISH DIMENSIONS ASSUME A 1/2" GAP
- BETWEEN FRAME WALL AND CONCRETE WALL.

 12. ALL INTERIOR BEARING WALLS SHALL HAVE GYPSUM APPLIED TO AT LEAST ONE SIDE OR HAVE MID-HEIGHT
- BLOCKING INSTALLED.

 13. NON-BEARING WALLS OVER CONCRETE TO BE HELD 1/2"
 SHORT OF FRAMING ABOVE.

GYPSUM NOTES:

AT GARAGE:

GYPSUM BOARD AT COMMON WALLS, CEILINGS, BEAM WRAPS AND SUPPORTS PER STANDARD DETAIL FA-I(b) FIRE ASSEMBLIES OR AS REQUIRED BY LOCAL CODE.


AT STAIRS:

1/2" GYPSUM BOARD AT UNDERSIDE OF STAIRS AND WALLS IN CLOSET




FIRST FLOOR JACK SCHEDULE				
IDENTIFIER	DESCRIPTION	OPTIONS	ENG. NUM.	REMARKS
00IL	JACK - (4) 2X4 SPF STUD GRADE		1010	
IOIL	JACK - (4) 2X4 SPF STUD GRADE		1010	
JIO2	JACK - (2) 2X4 SPF STUD GRADE		1016	
JI03	JACK - (3) 2X4 SPF STUD GRADE		1016	
JIO4	JACK - (2) 2X4 SPF STUD GRADE		1024	
JI <i>0</i> 5	JACK - (2) 2X4 SPF STUD GRADE		1008	
JI06	JACK - (2) 2X4 SPF STUD GRADE		1004	
TOIL	JACK - (2) 2X4 SPF STUD GRADE		1006	
POIL	JACK - (2) 2X4 SPF STUD GRADE		1022	
OIL	JACK - (2) 2X4 SPF STUD GRADE		1022	
JII2	JACK - (3) 2X6 SPF STUD GRADE	ELL	1020	
SIIL	JACK - (3) 2X4 SPF STUD GRADE	ELL	1020	

FIELD INSTALLED FIRST FLOOR BEAM/HEADER SCHEDULE					
IDENTIFIER	DESCRIPTION	LENGTH	OPTIONS	ENG. NUM.	REMARKS
LI00-2	LVL 1.75 - 09-04	8'-7 1/2"		1016	FIELD INSTALLED I.A

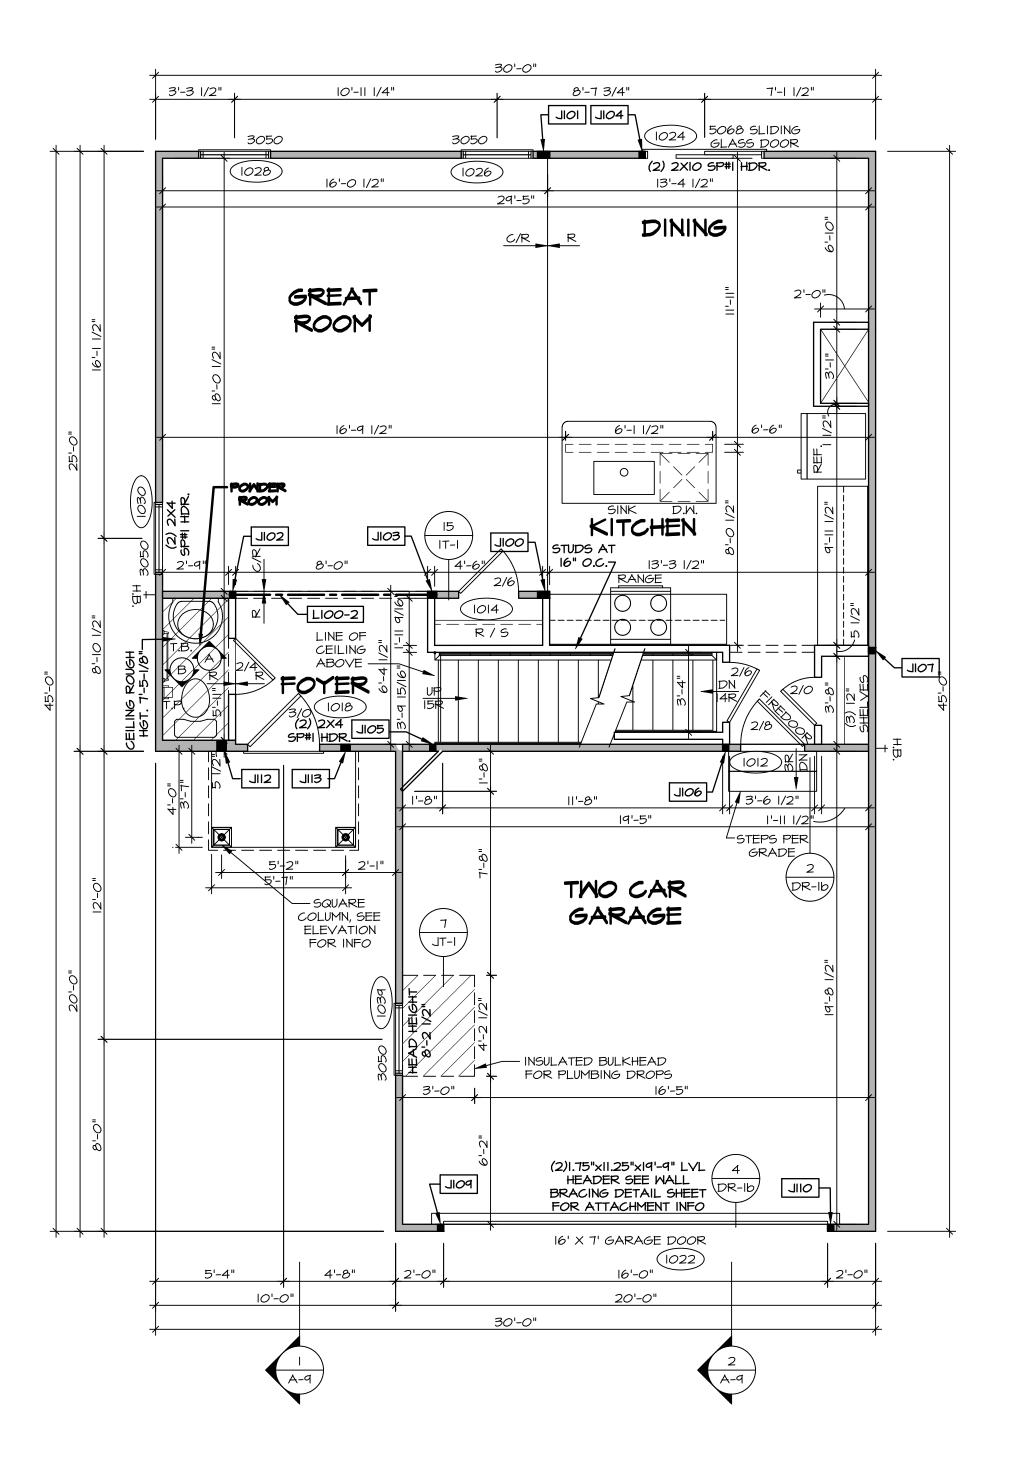



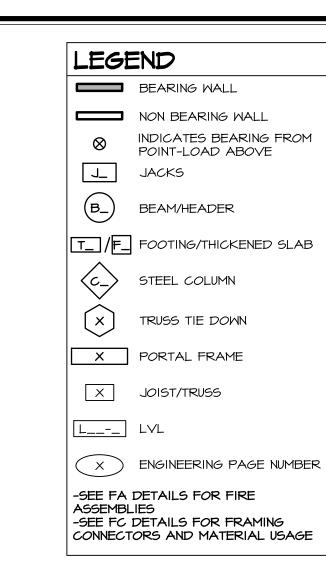

FLOOR PLAN NOTES:

- ALL HEADERS ARE (2) 2x6 w/ 2x4 WALLS OR (3) 2x6 w/ 2x6 WALLS, UNLESS OTHERWISE NOTED. ALL HEADERS TO HAVE (I) 2x4 OR 2x6 JACK AND KING STUD EACH END, UNLESS OTHERWISE NOTED. MULTI-OPENING HEADERS TO HAVE (2) JACKS AT INTERMEDIATE BEARING, UNLESS OTHERWISE NOTED. NO ADDITIONAL FLOOR SYSTEM BLOCKING OR CONTINUOUS LOAD PATH JACKS ARE REQUIRED UNLESS OTHERWISE
- ALL EXTERIOR WALLS TO BE 4" OR 6" AND ALL INTERIOR WALLS TO BE 3 1/2", UNLESS OTHERWISE NOTED. HATCHED AREAS INDICATE DROPPED CEILINGS. ALL DROPPED CEILINGS ARE 12" UNLESS OTHERWISE NOTED. SEE ARCHITECTURAL DETAIL 8/IT-IB FOR 3/4" FIRE STOPPING AT BULKHEAD / CEILING PANELS SEE "BRACED WALL PANEL DETAIL SHEET" FOR SPECIAL
- WALL FRAMING LOCATIONS AND HEADER SIZES, IF APPLICABLE. SEE STANDARD DETAIL CATEGORY "IT" SHEET(S) FOR
- INTERIOR TRIM DETAILS.
- SEE ARCHITECTURAL DETAIL SHEET "AD" FOR HOUSE SPECIFIC INTERIOR TRIM OPTION TABLE. ALL HEADERS IN NON-BEARING WALLS SHALL BE A SINGLE FLAT 2X4 OR 2X6 ATTACHED TO CRIPPLES
- ABOVE, UNLESS OTHERWISE NOTED. TANKED WATER HEATER SHOWN AS BASE CONDITION, OPTIONAL TANKLESS WATER HEATER IS AVAILABLE IN
- LIEU OF TANKED WATER HEATER.). INTERIOR HEADER HEIGHT FOR 8' CEILING WILL BE 6'-II",
- 9' CEILING WILL BE 7'-II", IO' CEILING WILL BE 8'-3", UNLESS OTHERWISE NOTED. BASEMENT FINISH DIMENSIONS ASSUME A 1/2" GAP
- BETWEEN FRAME WALL AND CONCRETE WALL.

 2. ALL INTERIOR BEARING WALLS SHALL HAVE GYPSUM
- APPLIED TO AT LEAST ONE SIDE OR HAVE MID-HEIGHT BLOCKING INSTALLED. . NON-BEARING WALLS OVER CONCRETE TO BE HELD 1/2" SHORT OF FRAMING ABOVE.

GYPSUM NOTES:

AT GARAGE:

GYPSUM BOARD AT COMMON WALLS, CEILINGS, BEAM WRAPS AND SUPPORTS PER STANDARD DETAIL FA-I(b) FIRE ASSEMBLIES OR AS REQUIRED BY LOCAL CODE.

AT STAIRS:

1/2" GYPSUM BOARD AT UNDERSIDE OF STAIRS AND WALLS IN CLOSET

EXTERIOR WALLS DRAWN TO FRAM WIDTH, EXTERIOR SHEATHING IS NO INCLUDED IN WALL THICKNESS.

||ALL WINDOWS HAVE 7'-0 1/2" HEAD HEIGHT UNLESS OTHERWISE NOTED


LVL PLY TO PLY FASTENING SCHEDULE: (WHERE APPLICABLE BASED ON LVL USA

- I.A (2) PLY UP TO AND INCLUDING II 7/8" TALL: FASTEN PLIES W/ (2) ROWS I6D NAILS AT I2" O.C. OR ALT I 1/2" WIDE LVL FASTEN PLIES W/ (3) ROWS 12D NAILS AT 12"O.C.
- 2.A (2) PLY 14" UP TO AND INCLUDING 18": FASTEN PLIES W/ (3) ROWS 16D NAILS AT 12" O.C. OR
- ALT I I/2" WIDE LVL FASTEN PLIES W/ (4) ROWS I2D NAILS AT I2"O.C. 3,A - (2) PLY 20" TALL AND OVER: FASTEN PLIES W/ (4) ROWS 16D NAILS AT 12" O.C. OR ALT 1 1/2" WID
- LVL FASTEN PLIES W/ (5) ROWS 12D NAILS AT 12"O.C. 4.A - (3) PLY UP TO AND INCLUDING II 7/8" TALL: FASTEN PLIES W/ (2) ROMS I6D NAILS AT I2" O.C. FROM EACH SIDE OR ALT I 1/2" WIDE LVL FASTEN PLIES W/ (3) ROWS 12D NAILS AT 12"O.C. FROM
- 5.A (3) PLY 14" UP TO AND INCLUDING 18": FASTEN PLIES W/ (3) ROWS 16D NAILS AT 12"O.C. FROM EACH SIDE OR ALT I 1/2" WIDE LVL FASTEN PLIES W/(4) ROWS 12D NAILS AT 12"O.C. FROM

SEE SHOP DRAWING FOR ADDITIONAL INFORMATION.

6.A - (3) PLY 20" TALL AND OVER: FASTEN PLIES W/ (4) ROWS 16D NAILS AT 12" O.C. FROM EACH SIDE OR ALT I 1/2" WIDE LVL FASTEN PLIES W/ (5) ROWS 12D NAILS AT 12"O.C. FROM EACH SIDE. 7.A - (4) PLY (ALL SIZES): FASTEN PLIES W/ (2) ROWS I/2" DIAMETER A307 BOLTS AT I2" O.C.

	SET NO. LILOO VERSION OI RELEASE NO DRAWN BY DATE: OPTION
MMING OT DER	
AGE)	MODEL LILY DRAWING TITLE FIRST FLOOR PLAN OPTION DESCRIPTION
	SHEET NO.

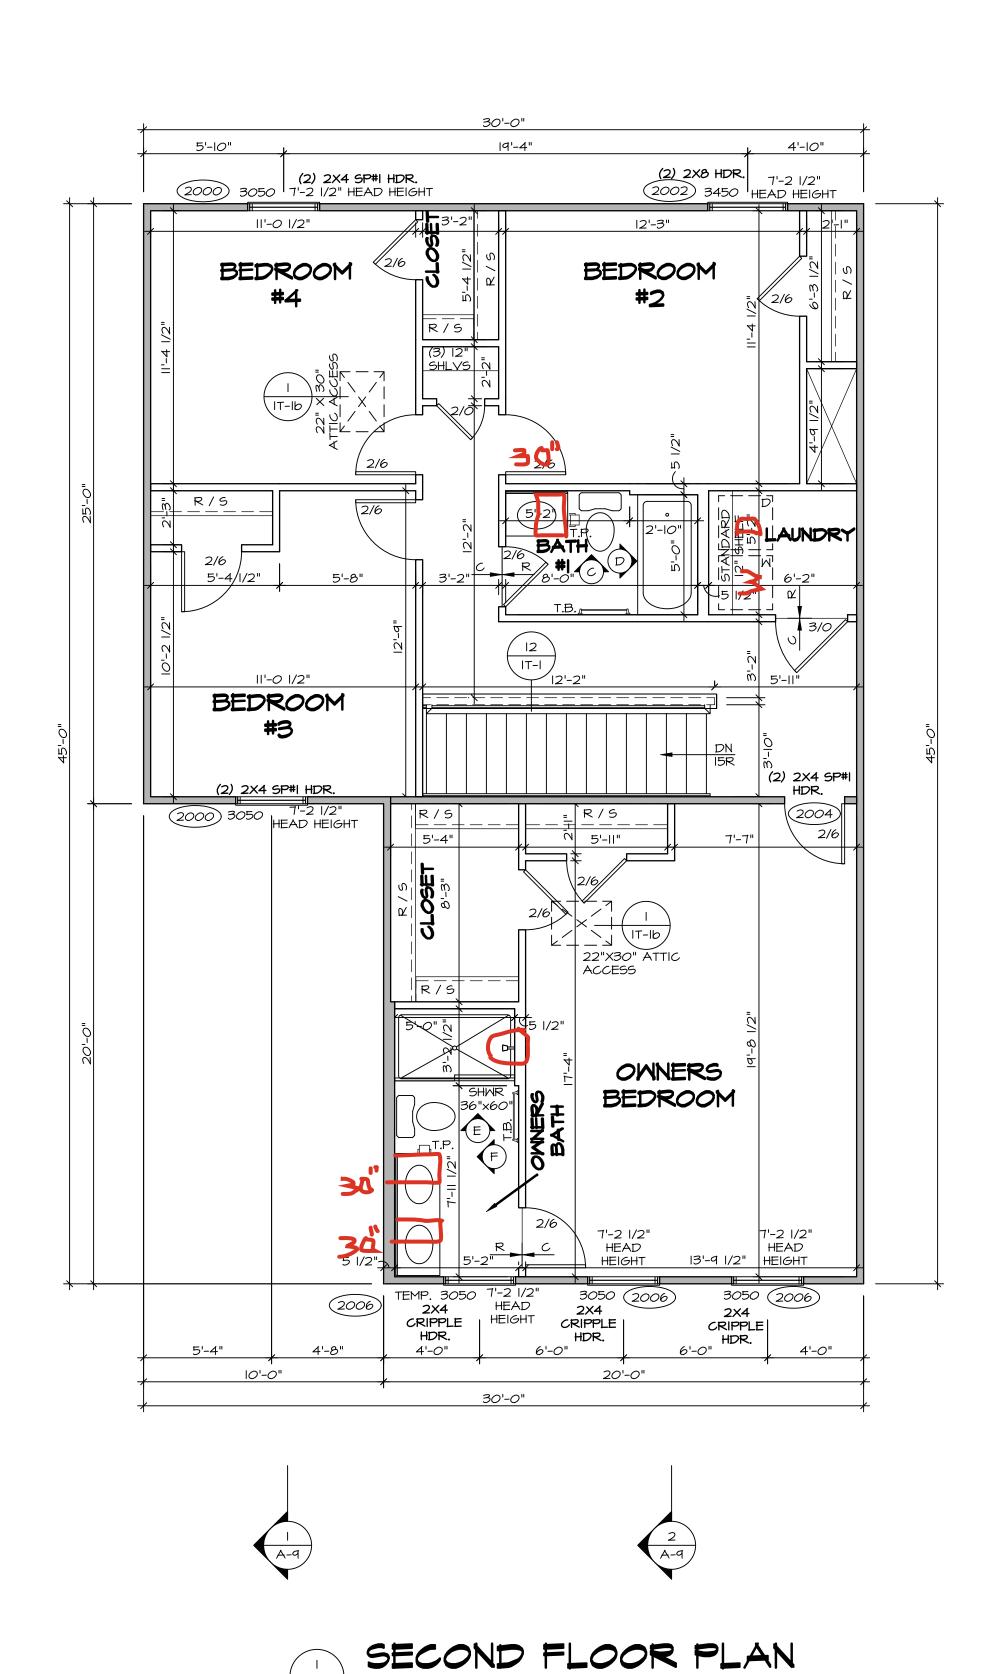

SCALE: 1/4" = 1'-0"

EXTERIOR WALLS DRAWN TO FRAMING WIDTH, EXTERIOR SHEATHING IS NOT INCLUDED IN WALL THICKNESS.

ALL WINDOWS HAVE 7'-2 1/2" HEADER HEIGHT UNLESS OTHERWISE NOTED

BEARING WALL NON BEARING WALL

LEGEND

INDICATES BEARING FROM POINT-LOAD ABOVE JACKS

BEAM/HEADER

T_ /F_ FOOTING/THICKENED SLAB STEEL COLUMN

TRUSS TIE DOWN

X JOIST/TRUSS

X PORTAL FRAME

L__-_ LVL

X ENGINEERING PAGE NUMBER

-SEE FA DETAILS FOR FIRE ASSEMBLIES -SEE FC DETAILS FOR FRAMING CONNECTORS AND MATERIAL USAGE

FLOOR PLAN NOTES:

- ALL HEADERS ARE (2) 2x6 W/ 2x4 WALLS OR (3) 2x6 W/ 2x6 WALLS, UNLESS OTHERWISE NOTED. ALL HEADERS TO HAVE (I) 2x4 OR 2x6 JACK AND KING STUD EACH END, UNLESS OTHERWISE NOTED. MULTI-OPENING HEADERS TO HAVE (2) JACKS AT INTERMEDIATE BEARING, UNLESS OTHERWISE NOTED. NO ADDITIONAL FLOOR SYSTEM BLOCKING OR CONTINUOUS LOAD PATH JACKS ARE REQUIRED UNLESS OTHERWISE
- ALL EXTERIOR WALLS TO BE 4" OR 6" AND ALL INTERIOR WALLS TO BE 3 1/2", UNLESS OTHERWISE NOTED. HATCHED AREAS INDICATE DROPPED CEILINGS. ALL DROPPED CEILINGS ARE 12" UNLESS OTHERWISE NOTED. SEE ARCHITECTURAL DETAIL 8/IT-IB FOR 3/4" FIRE STOPPING AT BULKHEAD / CEILING PANELS
- APPLICABLE.
- SEE STANDARD DETAIL CATEGORY "IT" SHEET(S) FOR INTERIOR TRIM DETAILS.
- SPECIFIC INTERIOR TRIM OPTION TABLE. ALL HEADERS IN NON-BEARING WALLS SHALL BE A
- SINGLE FLAT 2X4 OR 2X6 ATTACHED TO CRIPPLES ABOVE, UNLESS OTHERWISE NOTED. TANKED WATER HEATER SHOWN AS BASE CONDITION,
- OPTIONAL TANKLESS WATER HEATER IS AVAILABLE IN LIEU OF TANKED WATER HEATER. D. INTERIOR HEADER HEIGHT FOR 8' CEILING WILL BE 6'-II",
- BASEMENT FINISH DIMENSIONS ASSUME A 1/2" GAP
- APPLIED TO AT LEAST ONE SIDE OR HAVE MID-HEIGHT

GYPSUM NOTES:

AT GARAGE:

GYPSUM BOARD AT COMMON WALLS, CEILINGS, BEAM WRAPS AND SUPPORTS PER STANDARD DETAIL **FA-I(b)** FIRE ASSEMBLIES OR AS REQUIRED BY LOCAL CODE.

AT STAIRS:

1/2" GYPSUM BOARD AT UNDERSIDE OF STAIRS AND WALLS IN CLOSET

SEE "BRACED WALL PANEL DETAIL SHEET" FOR SPECIAL

WALL FRAMING LOCATIONS AND HEADER SIZES, IF

SEE ARCHITECTURAL DETAIL SHEET "AD" FOR HOUSE


9' CEILING WILL BE 7'-II", IO' CEILING WILL BE 8'-3", UNLESS OTHERWISE NOTED.


BETWEEN FRAME WALL AND CONCRETE WALL.


2. ALL INTERIOR BEARING WALLS SHALL HAVE GYPSUM


BLOCKING INSTALLED.


3. NON-BEARING WALLS OVER CONCRETE TO BE HELD 1/2"
SHORT OF FRAMING ABOVE.

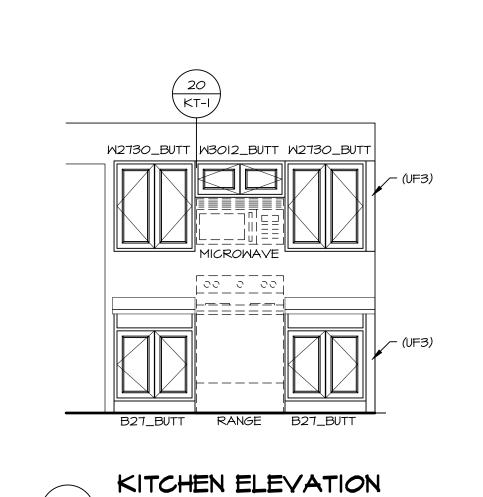

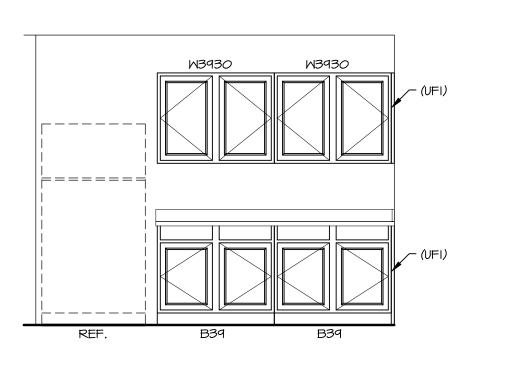

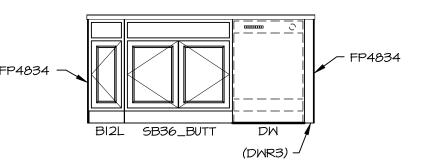


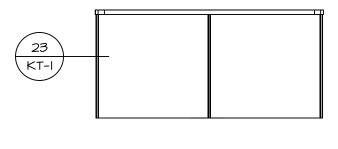

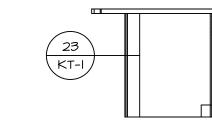






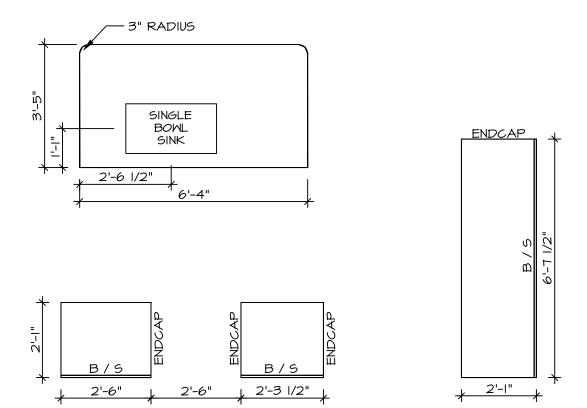



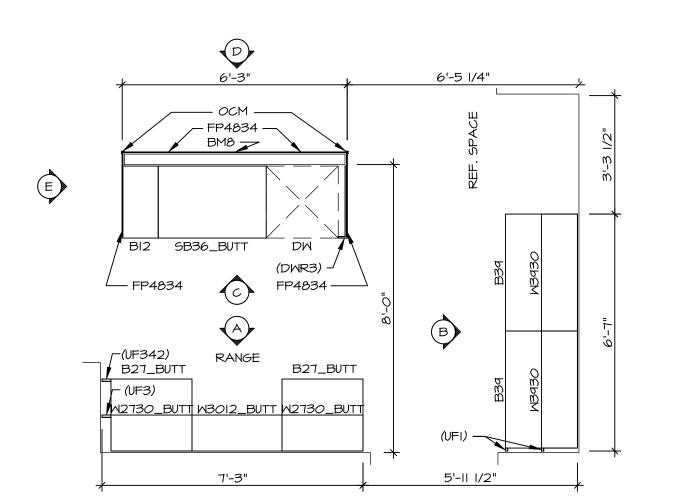

KITCHEN CABINET PLAN (KC-3664)

NOTES:
CABINETS ARE NOT REPRESENTATIVE OF ALL
STYLES AND ARE MEANT AS A GENERAL
DEPICTION OF THE INTENDED CABINET LAYOUT

KITCHEN NOTES:

- I. CABINET LAYOUT (S) ARE BASED ON FINISHED DIMENSIONS TO DRYWALL.

 2. IF KITCHEN PLANS/ELEVATIONS CALL-OUT STANDARD MOLDING, REFER TO STANDARD DETAIL (II/KT-I) FOR REPLACEMENT BASED ON CABINET STYLE.

 3. ALL (UF#) FILLERS ARE TO BE "TRIM TO FIT" UNLESS OTHERWISE NOTED.

 4. CABINET MUST BE SET, SHIMMED, LEVELED AND PLUMB W/ ADJOINING BASE CABINETS.

 5. SET PRE-FINISHED SCRIBE MOLDING AT CABINET BULKHEADS AND AT ENDS (WHERE
- CABINET BULKHEADS AND AT ENDS (WHERE CABINETS MEET DRYWALL.) PRE-FINISHED SCRIBE MOLDING SHALL BE USED TO PAD OUT CABINET SIDES AT STILE FOR RETURN PIECES OF THE FACE-MOUNTED CABINET CROWN MOLDING.

