





MODEL

GRAND BAHAMA

DRAWING TITLE

PLUMBING PLAN

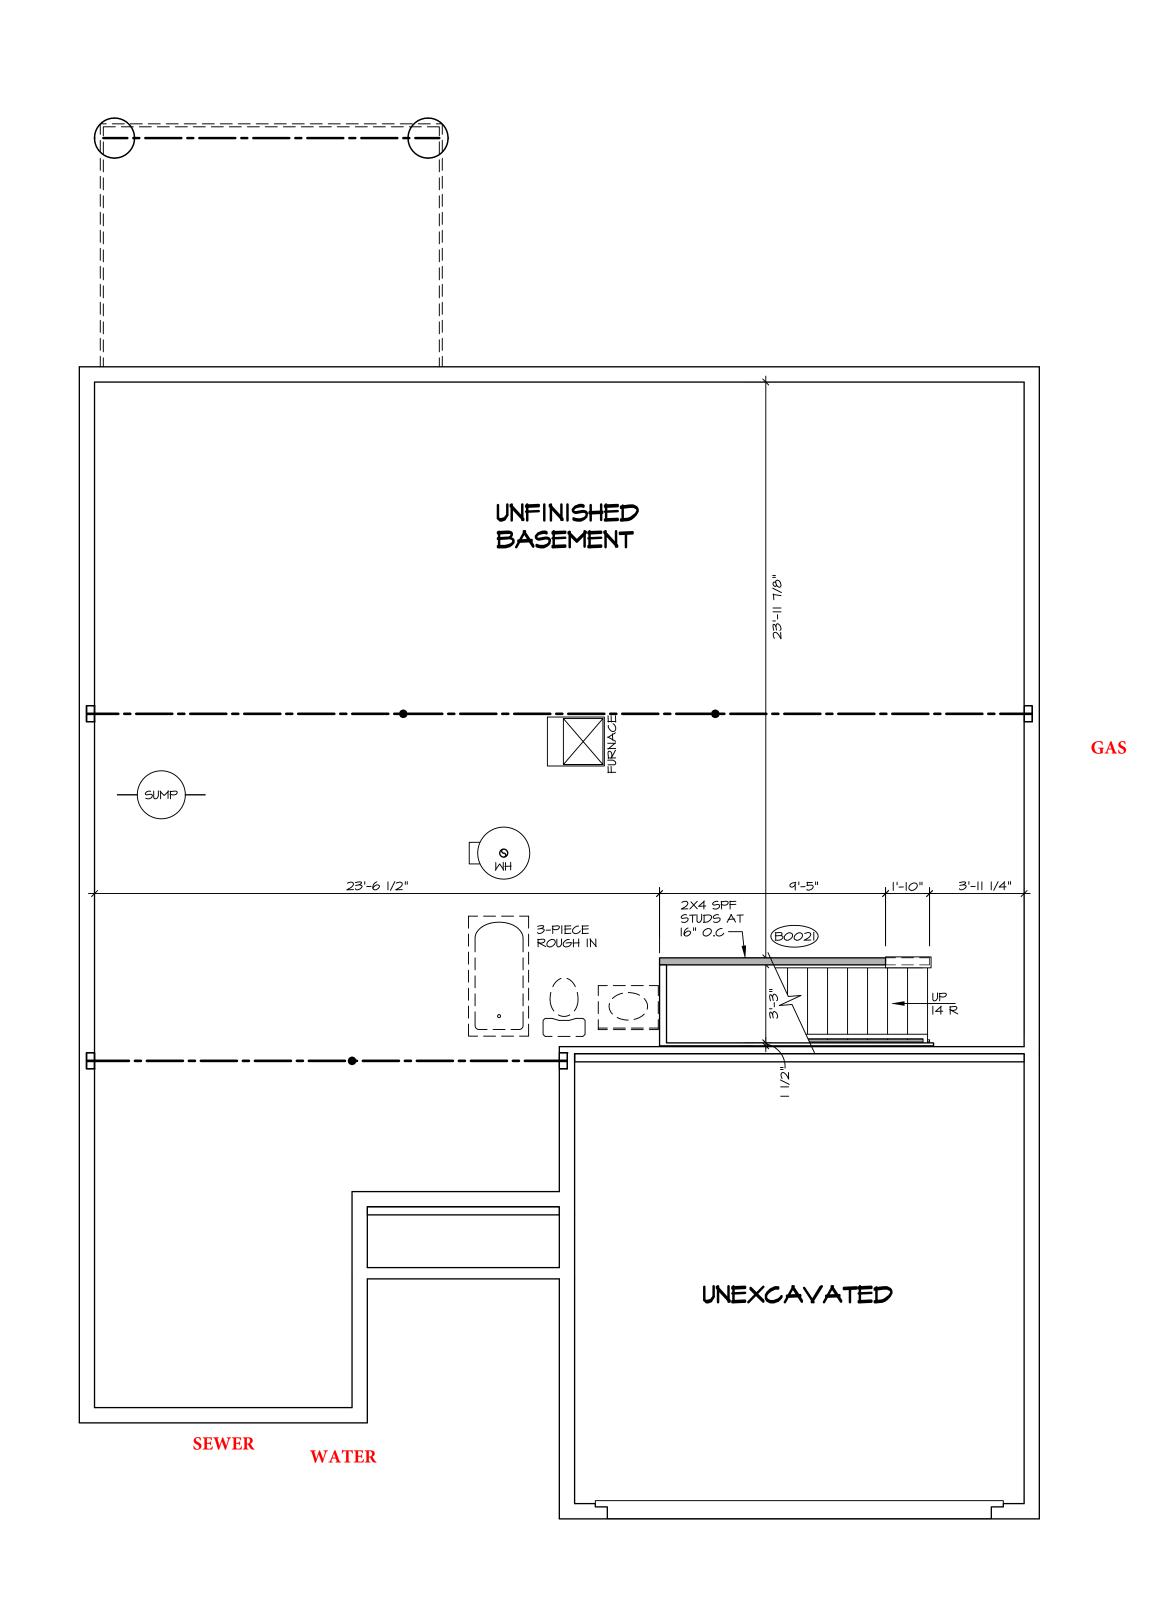

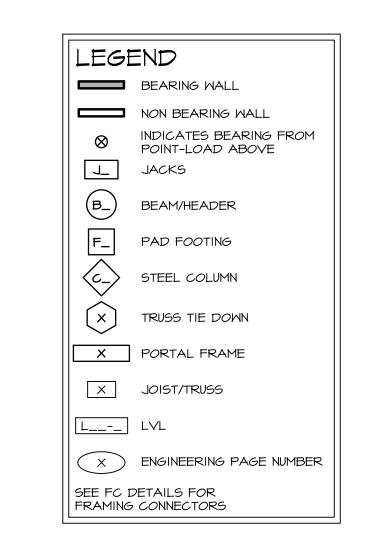

© NV
The
copy
in th
to
copie
what
assig

ВАНАМА

FLOOR PLAN NOTES

- ALL HEADERS ARE (2) 2x6 w/ 2x4 WALLS OR (3) 2x6 w/ 2x6 WALLS, UNLESS OTHERWISE NOTED.
 ALL HEADERS TO HAVE (I) 2x4 OR 2x6 JACK AND KING STUD EACH END, UNLESS OTHERWISE NOTED.
 MULTI-OPENING HEADERS TO HAVE (2) JACKS AT INTERMEDIATE BEARING, UNLESS OTHERWISE NOTED. NO ADDITIONAL FLOOR SYSTEM BLOCKING OR CONTINUOUS LOAD PATH JACKS ARE REQUIRED UNLESS OTHERWISE
- 3. ALL EXTERIOR WALLS TO BE 4" W/ OSB OR 3 1/2"
 W/ LAMINATED FIBROUS STRUCTURAL SHEATHING, ALL
 INTERIOR WALLS TO BE 3 1/2", UNLESS OTHERWISE NOTED.
- HATCHED AREAS INDICATE DROPPED CEILINGS. ALL DROPPED CEILINGS ARE 12" UNLESS OTHERWISE NOTED.
 SEE "BRACED WALL PANEL DETAIL SHEET" FOR SPECIAL WALL FRAMING LOCATIONS AND HEADER SIZES, IF APPLICABLE.
- 6. SEE STANDARD DETAIL CATEGORY "IT" SHEET(S) FOR INTERIOR TRIM DETAILS.7. SEE ARCHITECTURAL DETAIL SHEET "AD" FOR HOUSE
- SPECIFIC INTERIOR TRIM OPTION TABLE.

 B. ALL HEADERS IN NON-BEARING WALLS SHALL BE A SINGLE FLAT 2X4 OR 2X6 ATTACHED TO CRIPPLES ABOVE, UNLESS OTHERWISE NOTED.
- ABOVE, UNLESS OTHERWISE NOTED.

 I. TANKED WATER HEATER SHOWN AS BASE CONDITION,
 OPTIONAL TANKLESS WATER HEATER IS AVAILABLE IN
 LIEU OF TANKED WATER HEATER.

GYPSUM NOTES


AT GARAGE:

GYPSUM BOARD AT COMMON WALLS, CEILINGS, BEAM WRAPS AND SUPPORTS PER STANDARD DETAIL FA-I(b) FIRE ASSEMBLIES OR AS REQUIRED BY LOCAL CODE.

AT STAIRS:

1/2" GYPSUM BOARD AT UNDERSIDE OF STAIRS AND WALLS



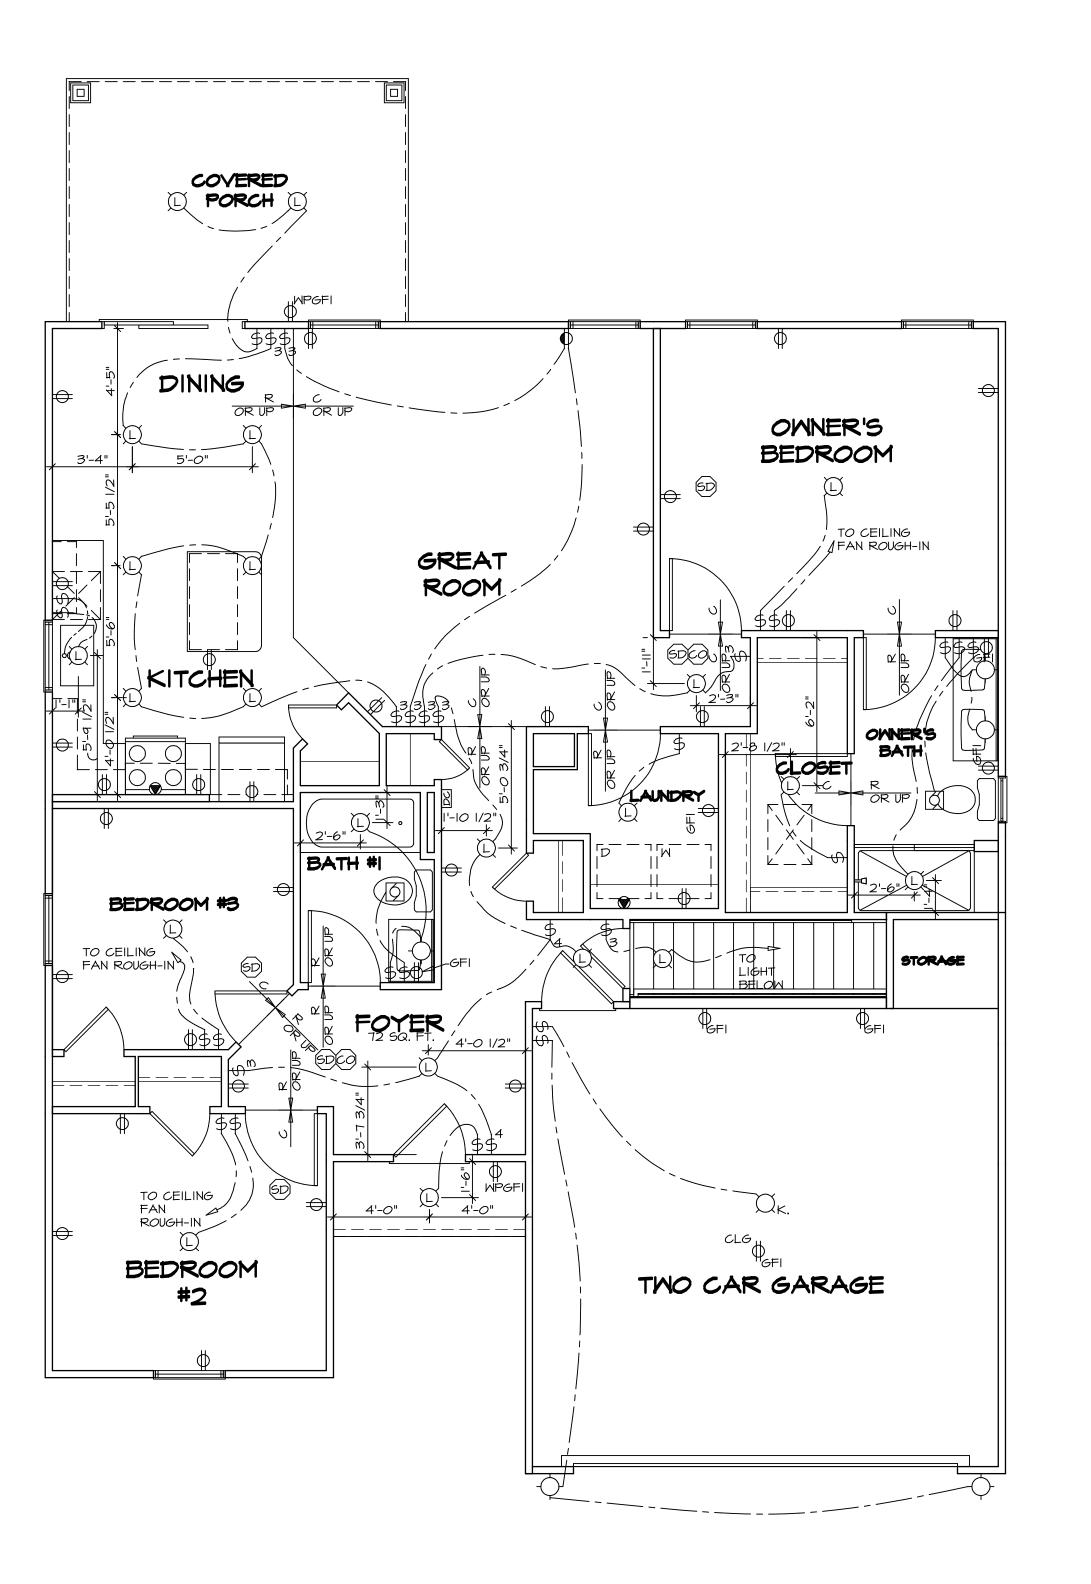

ALL ELECTRICAL PLANS ARE SCHEMATIC ONLY AND NOT INTENDED AS ENGINEERED DRAWINGS. THESE PLANS REPRESENT THE DESIGN INTENT FOR SWITCH AND RECEPTACLE LOCATIONS. ADDITIONAL INFORMATION, IF REQUIRED, SHALL BE PROVIDED BY A LICENSED ELECTRICAL SUBCONTRACTOR OR ENGINEER. . ALL KITCHEN, GARAGES, UNFINISHED BASEMENT, WETBARS AND ALL OUTDOOR RECEPTACLES ARE TO

BE GFI PROTECTED. PROVIDE DUPLEX RECEPTACLE ON DEDICATED CIRCUIT FOR DISHWASHER IN CABINET UNDER THE SINK. 1. PROVIDE DUPLEX RECEPTACLE FOR GARBAGE

DISPOSAL IN CABINET UNDER THE SINK. . PROVIDE SMITCH W/ KEYLESS LIGHT IN ATTIC SPACE. 6. PROVIDE SWITCH W/ KEYLESS LIGHT AND GFI RECEPTACLE WHEN HVAC EQUIPMENT IS IN ATTIC

PROVIDE ARC-FAULT CIRCUIT INTERRUPTERS TO ALL ROOMS EXCEPT BATH AND EXTERIOR RECEPTACLES. 3. WASHER ON LEFT, DRYER ON RIGHT (PER PLAN OR

REVERSED).

ELECTRICAL LEGEND

SINGLE POLE SWITCH

FOUR MAY SMITCH

DUPLEX RECEPTACLE

DUPLEX RECEPTACLE - BOTTOM HALF SWITCHED

DUPLEX RECEPTACLE - FLOOR MOUNTED

RECEPTACLE - 220V

DUPLEX RECEPTACLE - USB

DUPLEX RECEPTACLE - GROUND FAULT INTERRUPT DUPLEX RECEPTACLE - WEATHER PROOF AND

SMOKE DETECTOR - WIRED IN SERIES

CO CARBON MONOXIDE DETECTOR

EXHAUST FAN MOTOR

- EXHAUST FAN MOTOR WITH LIGHT

TELEVISION RECEPTACLE

DOOR CHIME

- LIGHT FIXTURE - WALL MOUNTED

LIGHT FIXTURE - CEILING MOUNTED

LIGHT FIXTURE - HANGING

LIGHT FIXTURE - PENDANT

LIGHT FIXTURE - UNDER CABINET LIGHT

KEYLESS LAMPHOLDER

NOTES:

THE BOTTOM OF SWITCH BOX TO BE AT 40" AFF.

2. THE BOTTOM OF RECEPTACLE BOX

3. KITCHEN AND BATH RECEPTACLES AND SWITCHES SHALL BE INSTALLED


9. DRYER RECEPTACLE 110 W/ GAS OR 220 W/ ELECTRIC. THREE WAY SWITCH MPGFI GROUND FAULT INTERRUPT

DUPLEX RECEPTACLE - MICROWAVE △ TELEPHONE RECEPTACLE R LIGHT FIXTURE - RECESSED R LIGHT FIXTURE - RECESSED WEATHER PROOF LIGHT FIXTURE - CEILING MOUNTED LED LIGHT FIXTURE - FLUORESCENT "S" = SMALL "M" = MEDIUM "L" = LARGE PULLCHAIN LAMPHOLDER

TO BE AT 18" AFF.

AT THE STANDARD HEIGHT.

FIRST FLOOR ELECTRICAL PLAN E-2 SCALE: 1/4" = 1'-0"

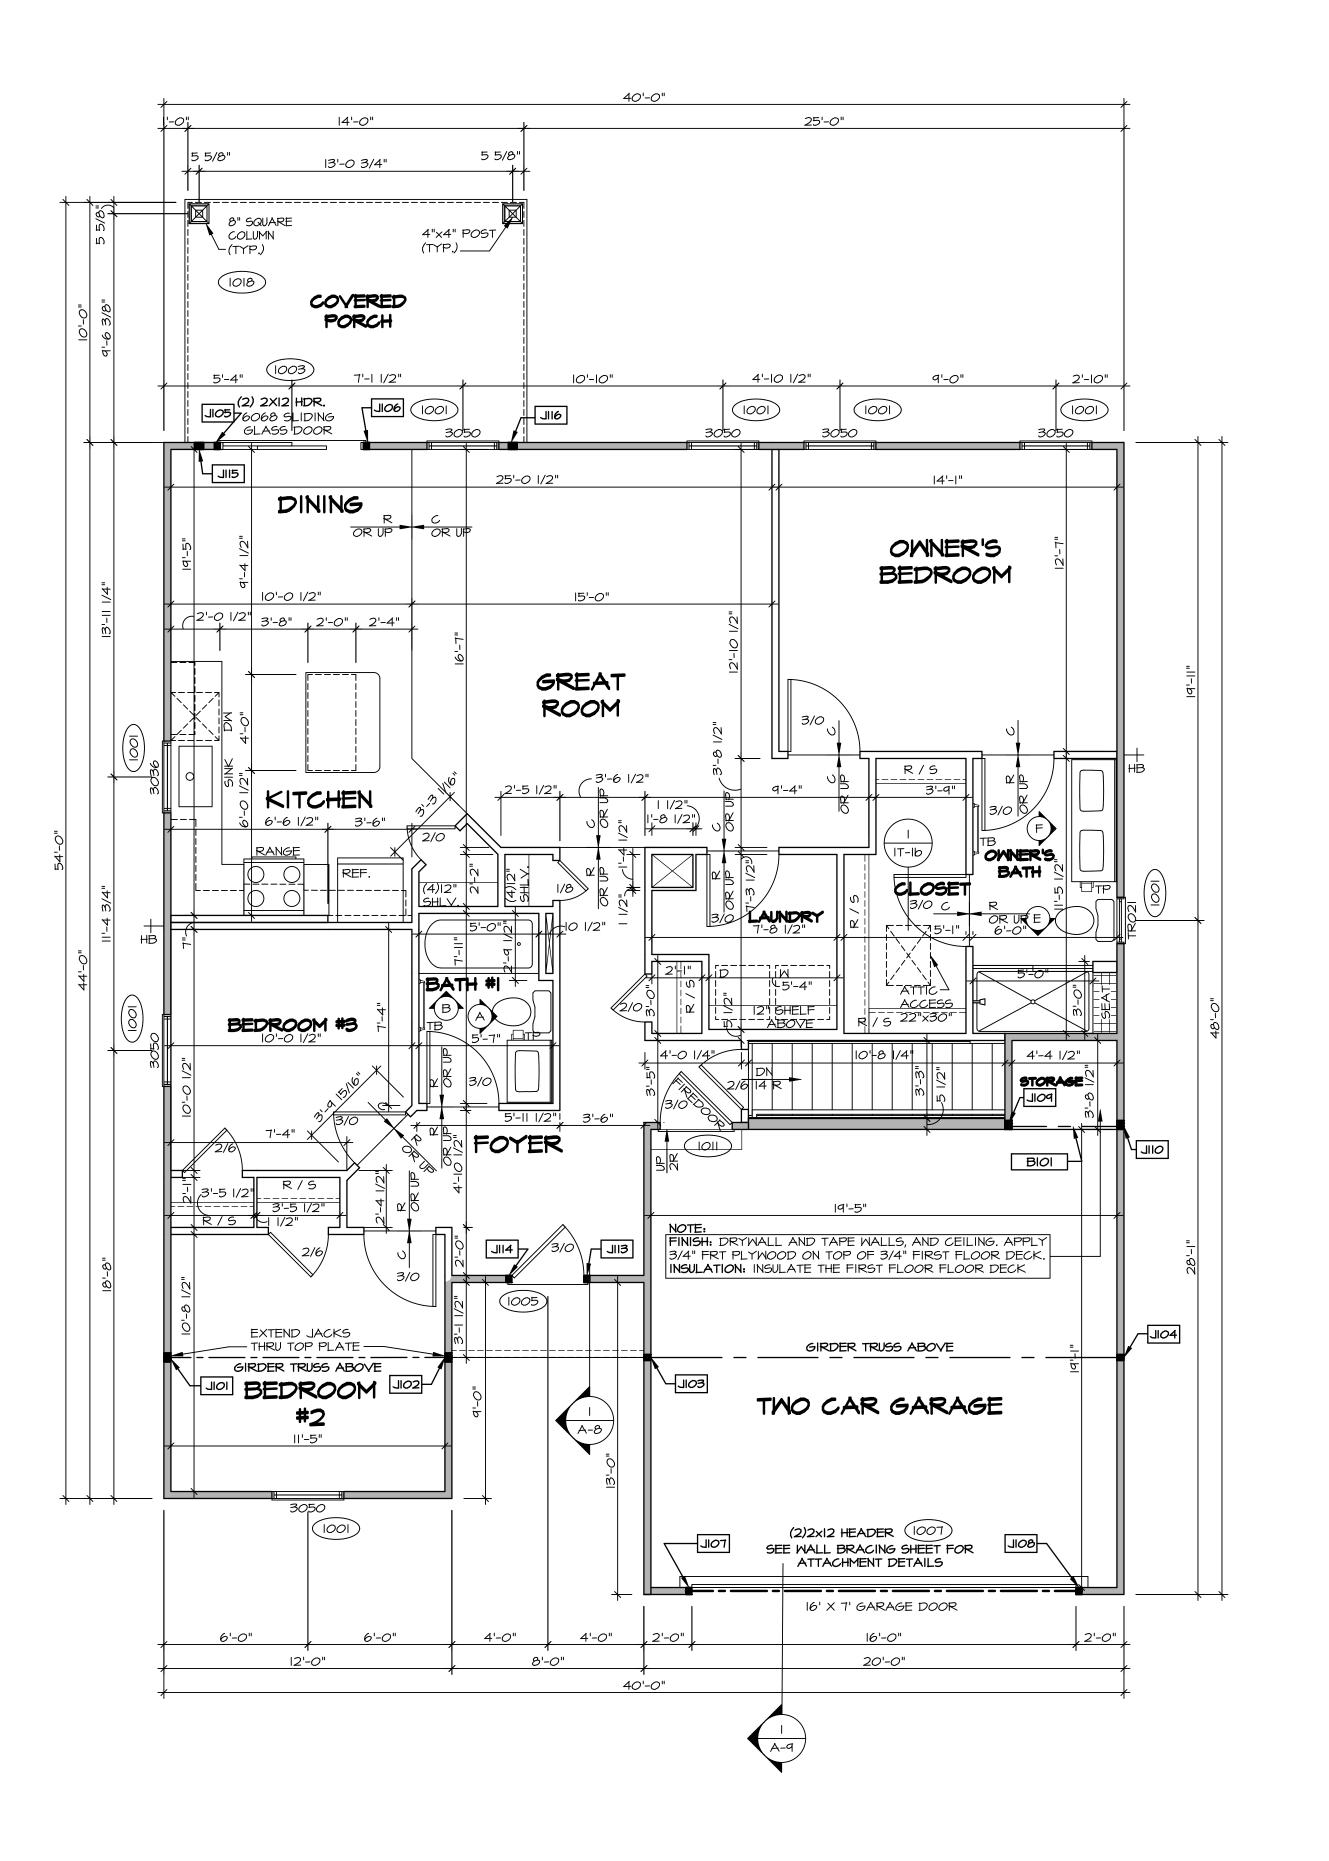



	FIRST FLOOR JACK S	SCHEDUL	.E
IDENTIFIER	DESCRIPTION	ENG. NUM.	REMARKS
IOIL	JACK - (3) 2X4 SP#I	1000	EXTEND THRU TOP PLATE
JI02	JACK - (3) 2X4 SP#I	1000	EXTEND THRU TOP PLATE
JI03	JACK - (2) 2X4 SPF STUD GRADE	1000	
JIO4	JACK - (2) 2X4 SPF STUD GRADE	1000	
JI05	JACK - (2) 2X4 SPF STUD GRADE	1003	
JI06	JACK - (2) 2X4 SPF STUD GRADE	1003	
TOIL	JACK - (2) 2X4 SPF STUD GRADE	1007	
80IL	JACK - (2) 2X4 SPF STUD GRADE	1007	
POIL	JACK - (3) 2X4 SPF STUD GRADE	1013	
OIL	JACK - (3) 2X4 SPF STUD GRADE	1013	
SIIL	JACK - (2) 2X4 SPF STUD GRADE	1005	
JII4	JACK - (2) 2X4 SPF STUD GRADE	1005	
JII5	JACK - (3) 2X4 SPF STUD GRADE	1018	
اال	JACK - (3) 2X4 SPF STUD GRADE	1018	

LVL PLY TO PLY FASTENING SCHEDULE: (WHERE APPLICABLE BASED ON LVL USAGE)


I.A - (2) PLY UP TO AND INCLUDING II 7/8" TALL: FASTEN PLIES W/ (2) ROWS I6D NAILS AT I2" O.C. 2.A - (2) PLY I4" TO AND I8" TALL (INCLUSIVE): FASTEN PLIES W/ (3) ROWS I6D NAILS AT I2" O.C.

3.A - (2) PLY 20" TALL AND OVER: FASTEN PLIES W/ (4) ROWS 16D NAILS AT 12" O.C.
4.A - (3) PLY UP TO AND INCLUDING II 7/8" TALL: FASTEN PLIES W/ (2) ROWS 16D NAILS AT 12" O.C.
FROM EACH SIDE

5.A - (3) PLY 14" TO AND 18" TALL (INCLUSIVE): FASTEN PLIES W (3) ROWS 16D NAILS AT 12" O.C. FROM EACH SIDE
6.A - (3) PLY 20" TALL AND OVER: FASTEN PLIES W (4) ROWS 16D NAILS AT 12" O.C. FROM EACH SIDE

6.A - (3) PLY 20" TALL AND OVER: FASTEN PLIES W/ (4) ROWS 16D NAILS AT 12" O.C. FROM EACH SID 7.A - (4) PLY (ALL SIZES): FASTEN PLIES W/ (2) ROWS 1/2" DIAMETER A307 BOLTS AT 24" O.C. SEE SHOP DRAWING FOR ADDITIONAL INFORMATION.

FIELD	FIELD INSTALLED FIRST FLOOR BEAM/HEADER SCHEDULE					
IDENTIFIER	DESCRIPTION	LENGTH	ENG. NUM.	REMARKS		
BIOI	INT HEADER - 2XIO - 2 PLY	4'-11 1/2"	1013			

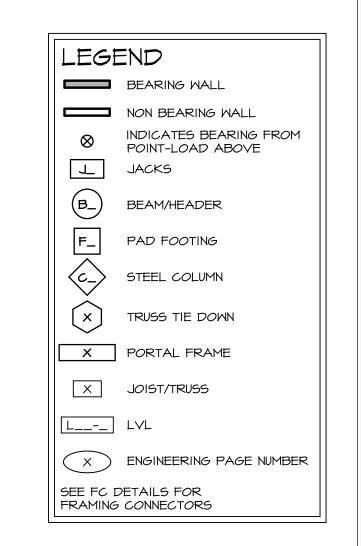

FLOOR PLAN NOTES RYAN

- ALL HEADERS ARE (2) 2x6 w/ 2x4 WALLS OR (3) 2x6 w/ 2x6 WALLS, UNLESS OTHERWISE NOTED.
 ALL HEADERS TO HAVE (I) 2x4 OR 2x6 JACK AND KING STUD EACH END, UNLESS OTHERWISE NOTED.
 MULTI-OPENING HEADERS TO HAVE (2) JACKS AT INTERMEDIATE BEARING, UNLESS OTHERWISE NOTED. NO ADDITIONAL FLOOR SYSTEM BLOCKING OR CONTINUOUS LOAD PATH JACKS ARE REQUIRED UNLESS OTHERWISE
- 3. ALL EXTERIOR WALLS TO BE 4" w/ OSB OR 3 1/2" w/ LAMINATED FIBROUS STRUCTURAL SHEATHING, ALL INTERIOR WALLS TO BE 3 1/2", UNLESS OTHERWISE NOTED.
- HATCHED AREAS INDICATE DROPPED CEILINGS. ALL DROPPED CEILINGS ARE 12" UNLESS OTHERWISE NOTED.
 SEE "BRACED WALL PANEL DETAIL SHEET" FOR SPECIAL WALL FRAMING LOCATIONS AND HEADER SIZES, IF APPLICABLE.
- 6. SEE STANDARD DETAIL CATEGORY "IT" SHEET(S) FOR INTERIOR TRIM DETAILS.
- SEE ARCHITECTURAL DETAIL SHEET "AD" FOR HOUSE SPECIFIC INTERIOR TRIM OPTION TABLE.
 ALL HEADERS IN NON-BEARING WALLS SHALL BE A
- SINGLE FLAT 2X4 OR 2X6 ATTACHED TO CRIPPLES ABOVE, UNLESS OTHERWISE NOTED.

 9. TANKED WATER HEATER SHOWN AS BASE CONDITION, OPTIONAL TANKLESS WATER HEATER IS AVAILABLE IN LIEU OF TANKED WATER HEATER.

GYPSUM NOTES

AT GARAGE:

GYPSUM BOARD AT COMMON WALLS, CEILINGS, BEAM WRAPS AND SUPPORTS PER STANDARD DETAIL FA-I(b) FIRE ASSEMBLIES OR AS REQUIRED BY LOCAL CODE.

AT STAIRS:

1/2" GYPSUM BOARD AT UNDERSIDE OF STAIRS AND WALLS IN CLOSET

property rights
plans are not changed, or nor manner they to be party, without pressed written

The state of the state of

NVR, Inc. 5285 Westview Drive, Suite 100 Frederick, MD 21703


© NV
The
copy
in th
to
copie
what
what
gassig


VERSION OI
DRAWN BY
DATE:
OPTION

IND BAHAMA
TITLE
FLOOR PLAN


GRAND
DRAWING TITLE
FIRST FLOOR

Y-A

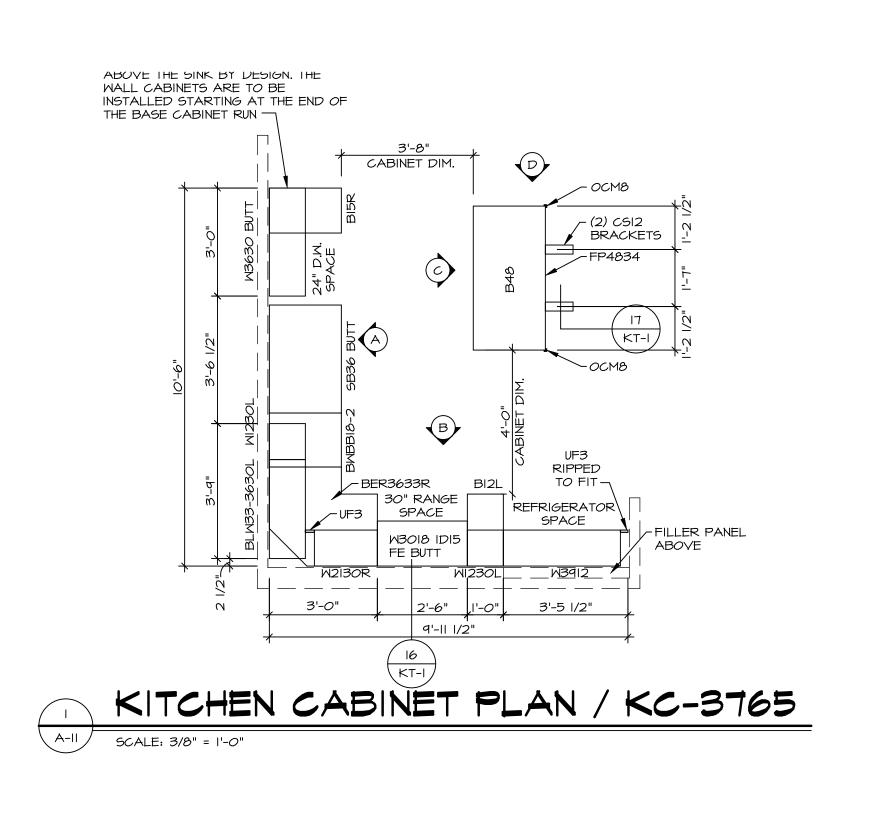


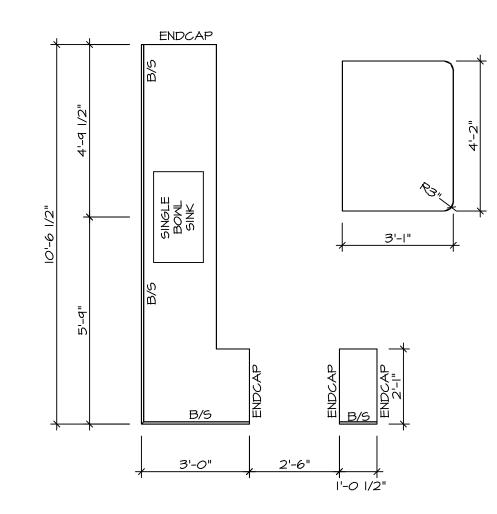


KITCHEN COUNTERTOP PLAN KC-3765

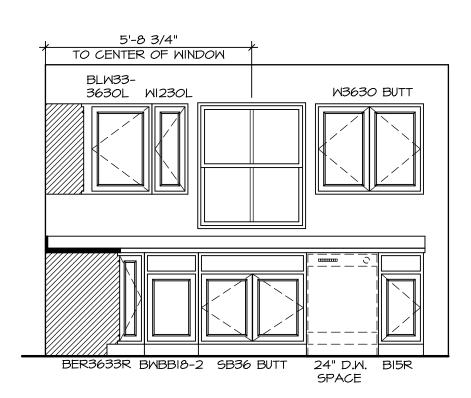



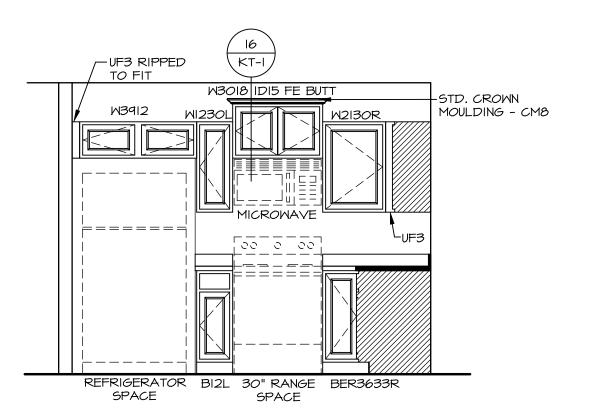




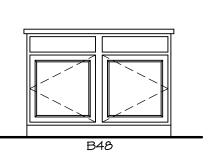

SCALE: 3/8" = 1'-0"



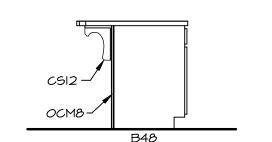



I. CABINET LAYOUT (S) ARE BASED ON FINISHED DIMENSIONS TO DRYWALL.

2. IF KITCHEN PLANS/ELEVATIONS CALL-OUT STANDARD MOLDING, REFER TO STANDARD DETAIL (II/KT-I) FOR REPLACEMENT BASED ON CABINET STYLE.

3. ALL (UF#) FILLERS ARE TO BE "TRIM TO FIT" UNLESS OTHERWISE NOTED.

4. CABINET MUST BE SET, SHIMMED, LEVELED AND PLUMB W/ ADJOINING BASE CABINETS.

5. SET PRE-FINISHED SCRIBE MOLDING AT CABINET BULKHEADS AND AT ENDS (WHERE CABINETS MEET DRYWALL.) PRE-FINISHED SCRIBE MOLDING SHALL BE USED TO PAD OUT CABINET SIDES AT STILE FOR RETURN PIECES OF THE FACE-MOUNTED CABINET CROWN MOLDING.

6. HARDWARE INSTALL NOTE: KNOBS GO ON OPERABLE DOORS AND DRAWERS FOR ALL KITCHEN AND BATH AREAS. DRAWER FRONTS AND DOORS GET (I) KNOB/PULL. NO HARDWARE ON FALSE DRAWER FRONTS.

© NVR, Inc.,

The owner, expressly reserves its copyright and other property rights in these plans. These plans are not to be reproduced, changed, or copied in any form or manner whatsoever, nor are they to be whatsoever, nor are they to be sometime tirst obtaining the expressed written consent of NVR, Inc.

SAMYERS MILL - LIFESTYLE - O216

STREET ADDRESS

SCHOOL OF STATE


CITY


OH 45042


NVR, Inc. 5285 Westview Drive, Suite 100 Frederick, MD 21703


VERSION OI DRAWN BY DATE: OPTION


ND BAHAMA
TITLE
INS

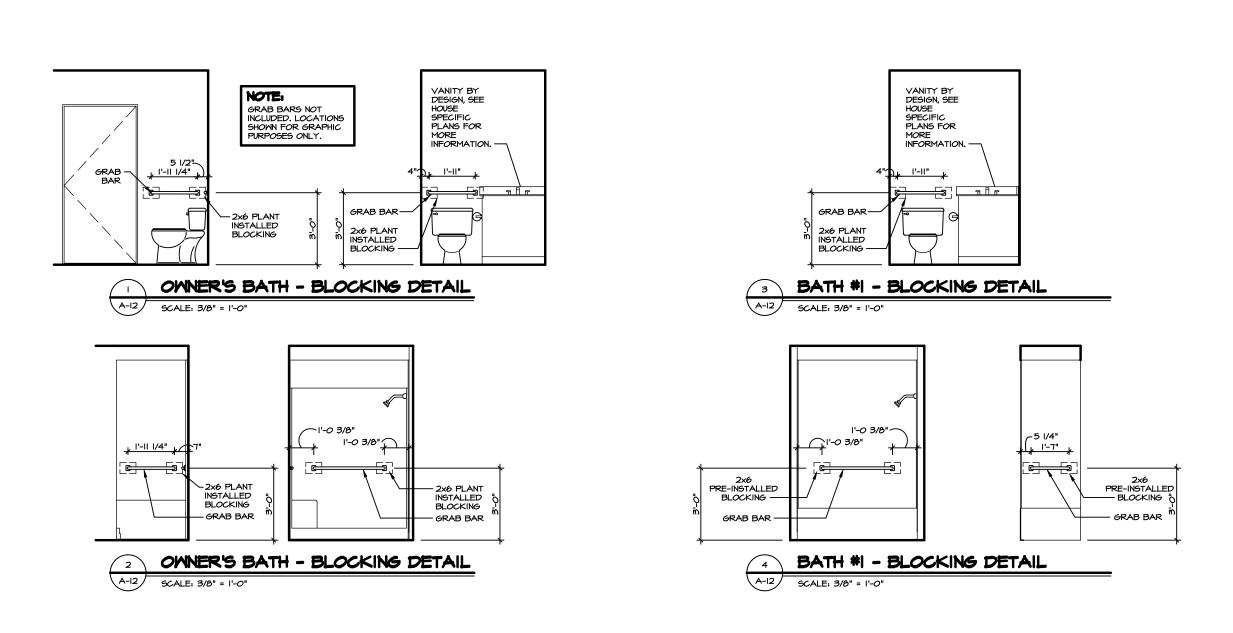

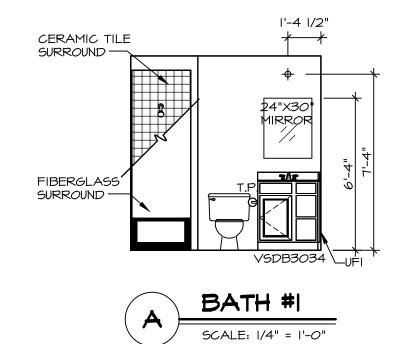

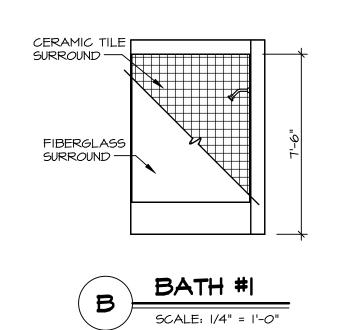

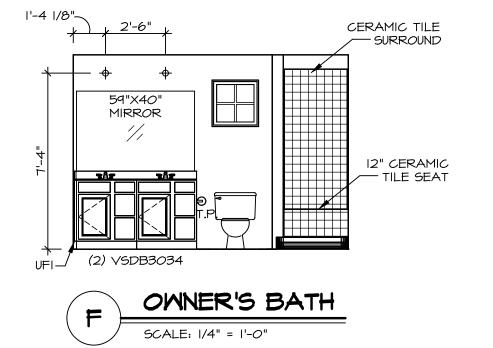

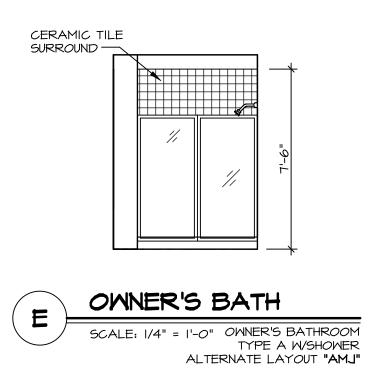

NOTES:

MODEL

GRAND BAHAMA

DRAWING TITLE

BATH ELEVATIONS

 \overline{m}

TEMPERED GLASS SHOWER
 ENCLOSURE WITH SWING DOOR OR
 OPTIONAL SLIDING DOOR BY DIVISION.
 TUB ACCESS PANELS PROVIDED AS
 NEEDED, ALL MATERIALS BY DIVISION.
 ALL BATH ELEVATIONS SHOWN PER PLAN.
 ALL VSDB24-42 DRAWERS TO BE SET ON
 RIGHT HAND.