



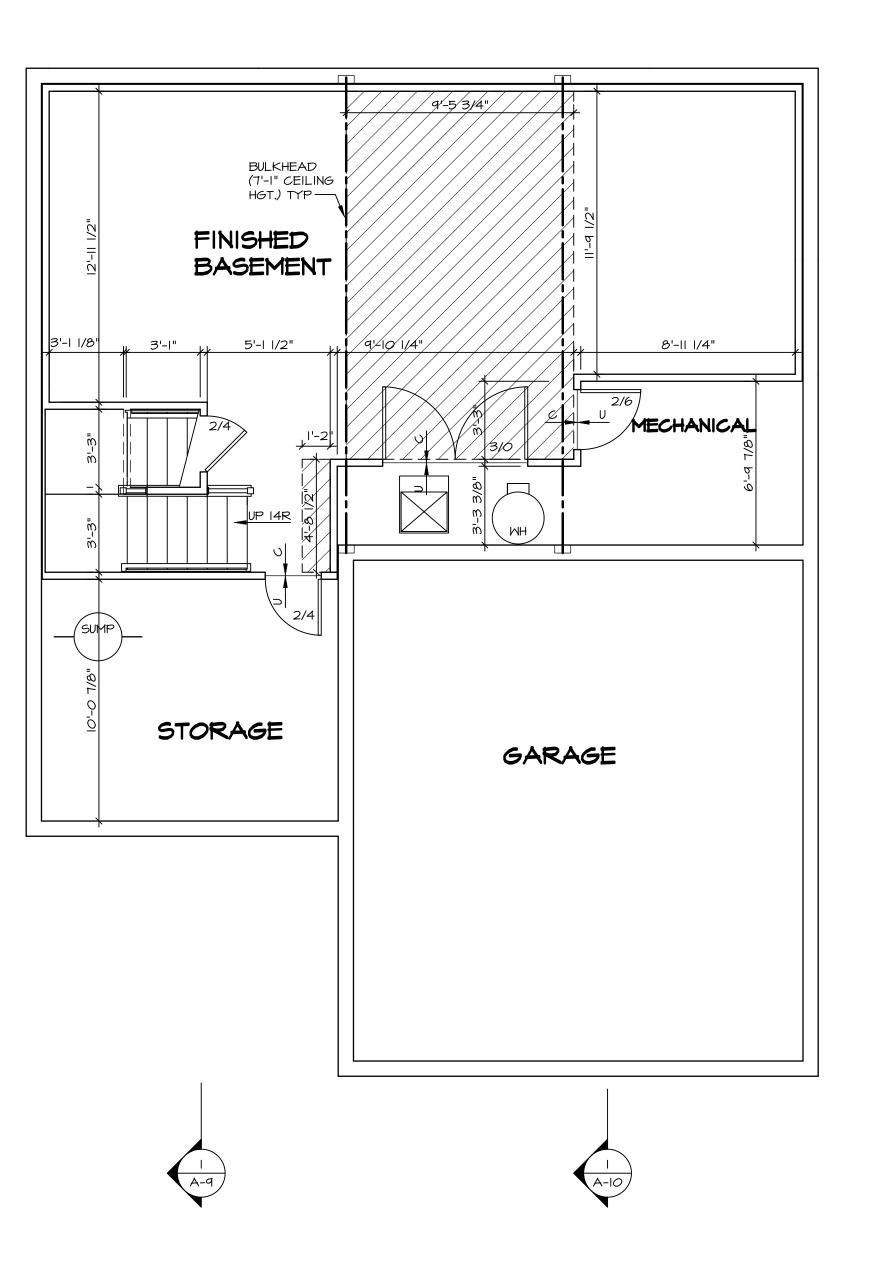

NOTE RADON REMEDIATION RADON REMEDIATION RADON LOOP! - (4) PERFORMED HIPPE "LOOP! - (4) PERFORMED HIPPE "LOOP! - MISSIPEL FLACED IN STONE BED SLICHTLY HIGHER THAN ANY INTERIOR DRAINTILE - MISSIPEL FLACED IN STONE BED SLICHTLY HIGHER THAN ANY INTERIOR DRAINTILE - MISSIPEL FLACED IN STONE AND MAY DRAINTILE ELEMENTS - TO BE CORRUGATED HIPPE PIPE! - SCREINS TO BE INSTALLED THROUGH LOOP AT TEE UP INTO STACK STACK JERUIREMENTS. - 3" PVC STACK (4" IF BASENENT IS GREATER THAN 2200 SOFT.) NO PART OF STACK IS TO BE HONIZONTAL - PIPE TO BE PHYSICALLY LABELED IN THE FIELD AS "RADON VENT" OR OTHER JURISDICTIONALLY REQUIRED LANKAUGE (ON EVERY LEVEL DO HOUSE)		
RADON REMEDIATION RADON LOOP: - (4") PERFORATED HDPE "LOOP" - MUST BE PLACED IN STONE BED SLIGHTLY HIGHER THAN ANY INTERIOR DRAINTILE - LOOP TO BE SEPARATE FROM ANY DRAINTILE ELEMENTS - TO BE CORRUGATED HDPE PIPE - SCREWS TO BE INSTALLED THROUGH LOOP AT TEE UP INTO STACK STACK REQUIREMENTS: - 3" PVC STACK (4" IF BASEMENT IS GREATER THAN 2200 SQFT.) - NO PART OF STACK IS TO BE HORIZONTAL - PIPE TO BE PHYSICALLY LABELED IN THE FIELD AS "RADON VENT" OR OTHER		
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- ROOF TERMINATION TO BE IN TOP 1/3 OF ROOF - SCREEN INSTALLED TO KEEP PESTS OUT OF RADON VENT AT ROOF TERMINATION	RADON REMEDIATION RADON LOOP: - (4") PERFORATED HDPE "LOOP" - MUST BE PLACED IN STONE BED SLIGHTLY HIGHER THAN ANY INTERIOR DRAINTILE - LOOP TO BE SEPARATE FROM ANY DRAINTILE ELEMENTS - TO BE CORRUGATED HDPE PIPE - SCREWS TO BE INSTALLED THROUGH LOOP AT TEE UP INTO STACK STACK REQUIREMENTS: - 3" PVC STACK (4" IF BASEMENT IS GREATER THAN 2200 SQFT.) - NO PART OF STACK IS TO BE HORIZONTAL - PIPE TO BE PHYSICALLY LABELED IN THE FIELD AS "RADON VENT" OR OTHER JURISDICTIONALLY REQUIRED LANGUAGE (ON EVERY LEVEL OF HOUSE) - ROOF TERMINATION TO BE IN TOP 1/3 OF ROOF	



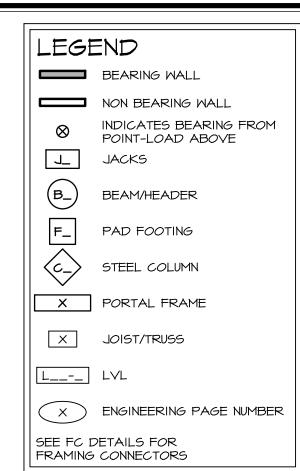



FLOOR PLAN NOTES

- ALL HEADERS ARE (2) 2x6 w/ 2x4 WALLS OR (3) 2x6 w/ 2x6 WALLS, UNLESS OTHERWISE NOTED.
 ALL HEADERS TO HAVE (1) 2x4 OR 2x6 JACK AND KING
- STUD EACH END, UNLESS OTHERWISE NOTED.

 3. ALL EXTERIOR WALLS TO BE 4" w/ OSB OR 3 I/2"
 w/ T-PLY, ALL INTERIOR WALLS TO BE 3 I/2", UNLESS
- OTHERWISE NOTED.

 4. HATCHED AREAS INDICATE DROPPED CEILINGS. ALL DROPPED CEILINGS ARE 12" UNLESS OTHERWISE NOTED. 5. SEE "BRACED WALL PANEL DETAIL SHEET" FOR SPECIAL WALL FRAMING LOCATIONS AND HEADER SIZES, IF
- APPLICABLE.
- APPLICABLE.

 6. SEE STANDARD DETAIL CATEGORY "IT" SHEET(S) FOR INTERIOR TRIM DETAILS.

 7. SEE ARCHITECTURAL DETAIL SHEET "AD" FOR HOUSE SPECIFIC INTERIOR TRIM OPTION TABLE.

 8. ALL WINDOWS HAVE 7'-0 1/2" HEADER HEIGHT UNLESS
- 9. ALL WINDOWS HAVE 1-0 1/2" HEADER HEIGHT UNLESS
 OTHERWISE NOTED.

 9. ALL HEADERS IN NON-BEARING WALLS SHALL BE A
 SINGLE FLAT 2X4 OR 2X6 ATTACHED TO CRIPPLES
 ABOVE, UNLESS OTHERWISE NOTED.

 10. TANKED WATER HEATER SHOWN AS BASE CONDITION,
 OPTIONAL TANKEDS WATER HEATER IS AVAILABLE IN

LIEU OF TANKED WATER HEATER.


GYPSUM NOTES

AT GARAGE:

GYPSUM BOARD AT COMMON WALLS, CEILINGS, BEAM WRAPS AND SUPPORTS PER STANDARD DETAIL FA-I(b) FIRE ASSEMBLIES OR AS REQUIRED BY LOCAL CODE.

AT STAIRS:

1/2" GYPSUM BOARD AT UNDERSIDE OF STAIRS AND WALLS

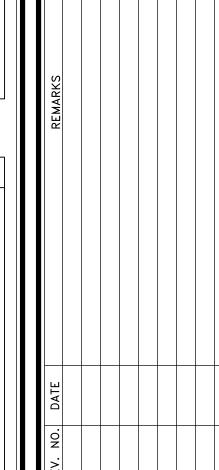






FIRST FLOOR JACK SCHEDULE				
IDENTIFIER	DESCRIPTION	OPTIONS	ENG. NUM.	REMARKS
IOIL	JACK - (2) 2X4 SPF STUD GRADE		1004	
JIO2	JACK - (2) 2X6 SPF STUD GRADE		1004	
JI03	JACK - (5) 2X4 SP#I		1008	
JIO4	JACK - (5) 2X4 SP#I		1008	
JI <i>0</i> 5	JACK - (3) 2X6 SP#I	ELA, ELB, ELK, ELL	1010	
JI06	JACK - (3) 2X4 SP#I	ELA, ELB, ELK, ELL	1010	
III	JACK - (2) 2X4 SPF STUD GRADE		1025	
JII2	JACK - (2) 2X4 SPF STUD GRADE		1025	
SIIL	JACK - (2) 2X4 SPF STUD GRADE		1033	
JII5	JACK - (2) 2X4 SPF STUD GRADE		1006	
J120	JACK - (2) 2X4 SPF STUD GRADE		1027	
JI2I	JACK - (2) 2X4 SPF STUD GRADE		1027	
JI22	JACK - (2) 2X4 SPF STUD GRADE		1027	
JI24	JACK - (2) 2X4 SPF STUD GRADE		1027	


FIELD INSTALLED FIRST FLOOR BEAM/HEADER SCHEDULE					
IDENTIFIER	DESCRIPTION	LENGTH	OPTIONS	ENG. NUM.	REMARKS
BIOI	BEAM STEEL - WIOX30	20'-6"		1008	

STEEL COLUMN SCHEDULE				
STEEL SOLOWIN SONEDOLE				
STYLE	HEIGHT	OPTIONS	ENG. NUM.	REMARKS
-			STEEL COLUMN SCHEDULE STYLE HEIGHT OPTIONS	

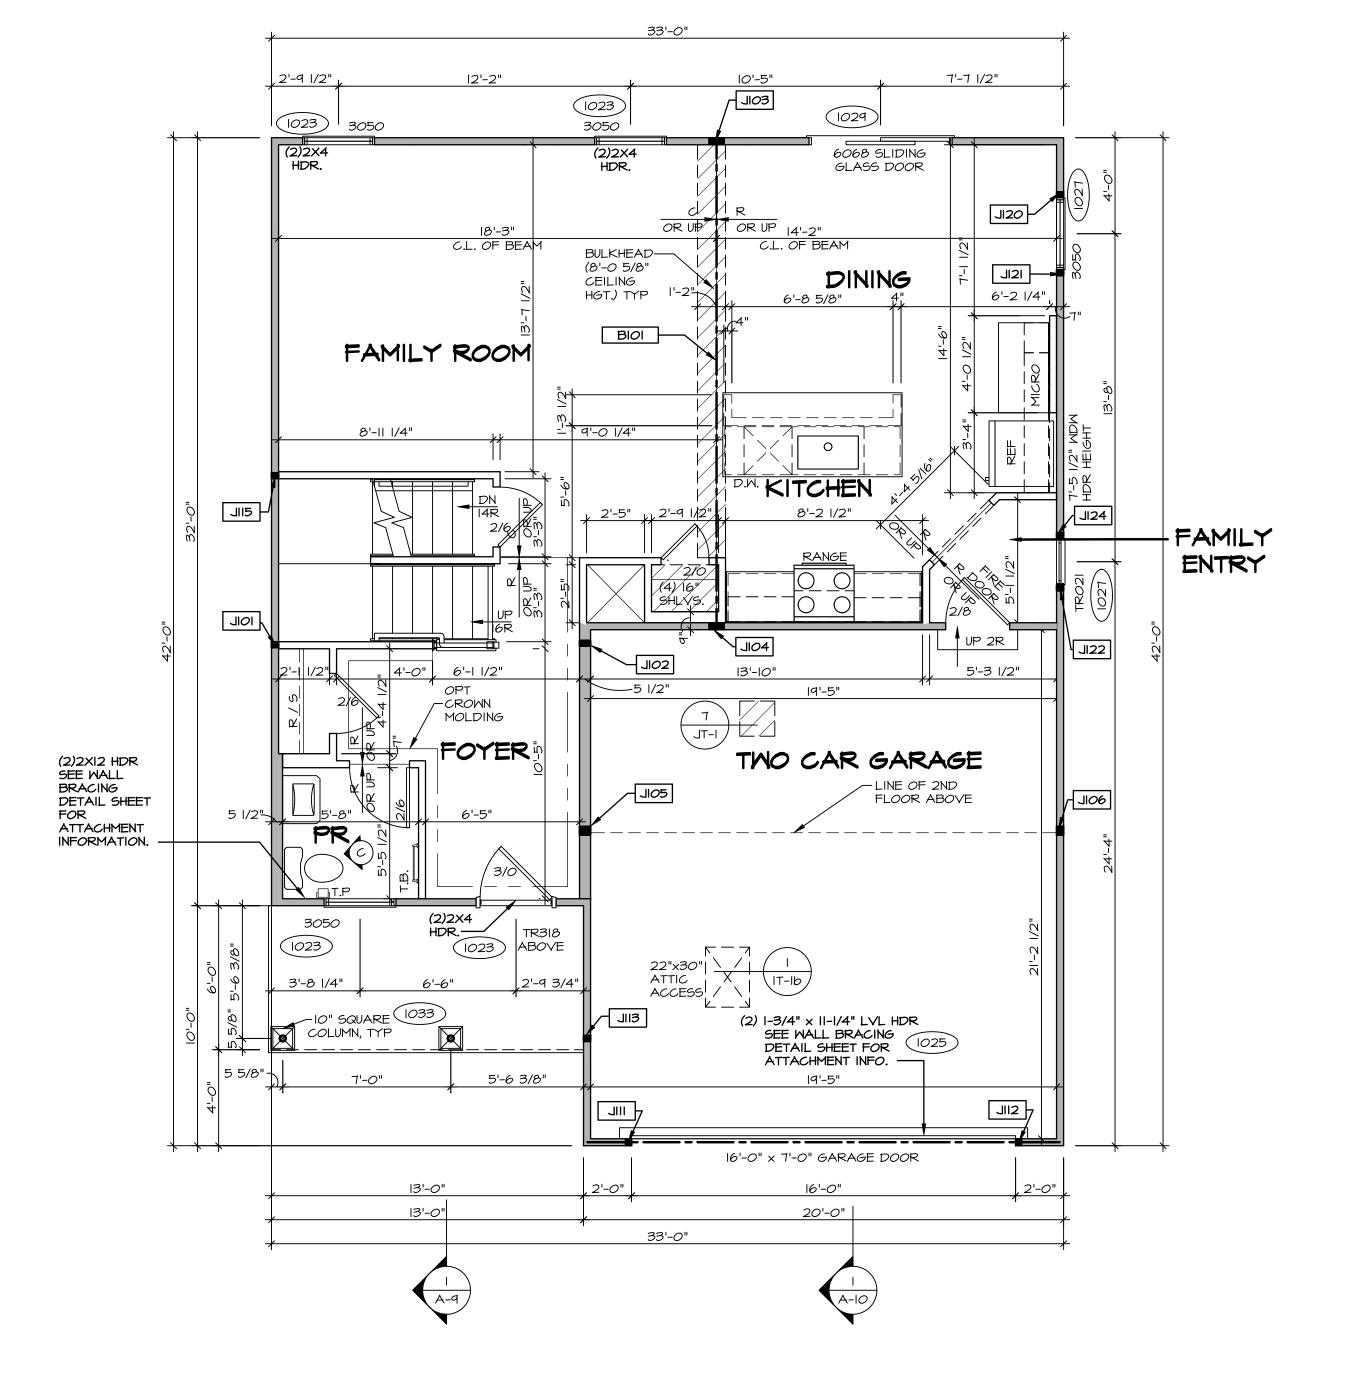

FIRST FLOOR PLAN

SCALE: 1/4" = 1'-0"

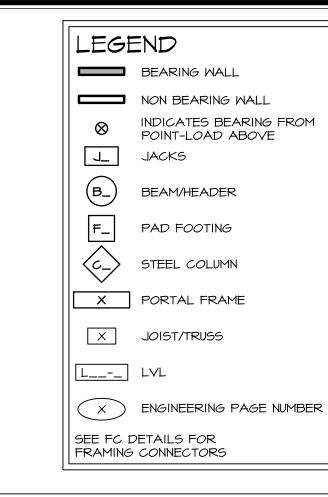

FLOOR PLAN NOTES RYAN ALL HEADERS ARE (2) 2x6 w/ 2x4 WALLS OR (3) 2x6 w/ 2x6 WALLS, UNLESS OTHERWISE NOTED. 2. ALL HEADERS TO HAVE (I) 2x4 OR 2x6 JACK AND KING STUD EACH END, UNLESS OTHERWISE NOTED. 3. ALL EXTERIOR WALLS TO BE 4" W/ OSB OR 3 1/2" W/ LAMINATED FIBROUS STRUCTURAL SHEATHING, ALL INTERIOR WALLS TO BE 3 1/2", UNLESS OTHERWISE NOTED. HATCHED AREAS INDICATE DROPPED CEILINGS. ALL DROPPED CEILINGS ARE 12" UNLESS OTHERWISE NOTED. SEE "BRACED WALL PANEL DETAIL SHEET" FOR SPECIAL WALL FRAMING LOCATIONS AND HEADER SIZES, IF APPLICABLE. 6. SEE STANDARD DETAIL CATEGORY "IT" SHEET(S) FOR INTERIOR TRIM DETAILS. SEE ARCHITECTURAL DETAIL SHEET "AD" FOR HOUSE SPECIFIC INTERIOR TRIM OPTION TABLE. ALL WINDOWS HAVE 7'-0 1/2" HEADER HEIGHT UNLESS OTHERWISE NOTED. ALL HEADERS IN NON-BEARING WALLS SHALL BE A SINGLE FLAT 2X4 OR 2X6 ATTACHED TO CRIPPLES ABOVE, UNLESS OTHERWISE NOTED. D. TANKED WATER HEATER SHOWN AS BASE CONDITION, OPTIONAL TANKLESS WATER HEATER IS AVAILABLE IN LIEU OF TANKED WATER HEATER.

GYPSUM NOTES

AT GARAGE:

GYPSUM BOARD AT COMMON WALLS, CEILINGS, BEAM WRAPS AND SUPPORTS PER STANDARD DETAIL FA-I(b) FIRE ASSEMBLIES OR AS REQUIRED BY LOCAL CODE.

AT STAIRS:

1/2" GYPSUM BOARD AT UNDERSIDE OF STAIRS AND WALLS


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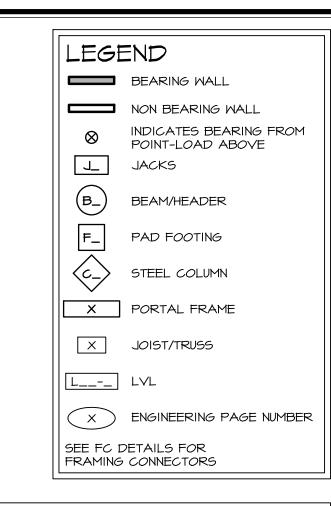
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ALLEGHENY
DRAWING TITLE
FIRST FLOOR PLAN

28





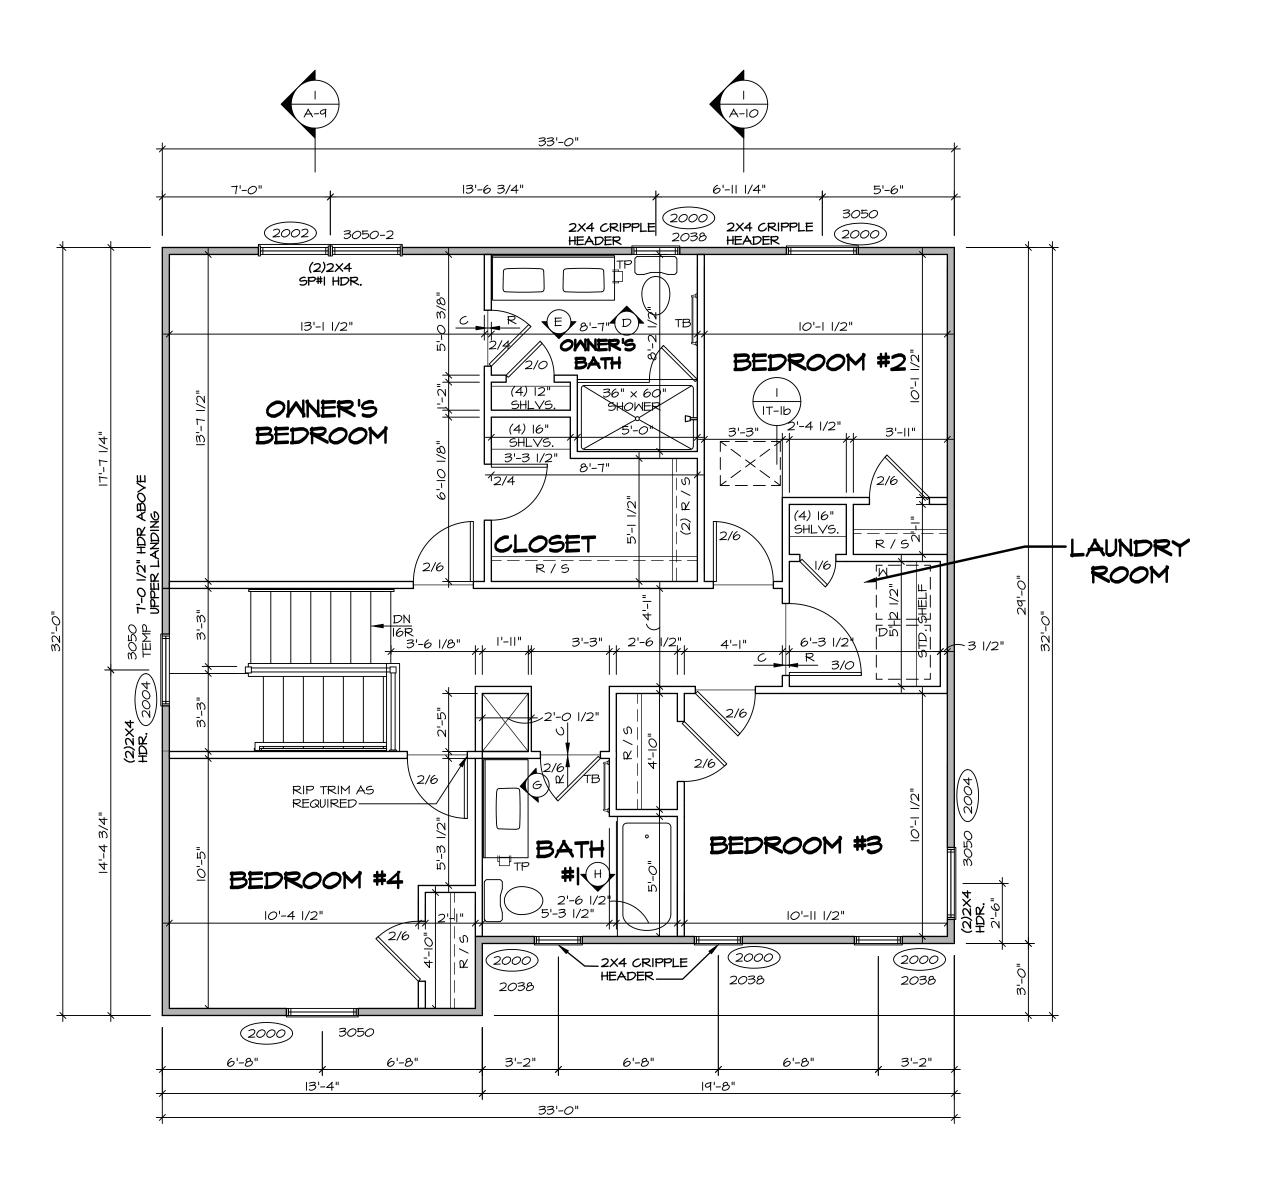

FLOOR PLAN NOTES

ALL HEADERS ARE (2) 2x6 w/ 2x4 WALLS OR (3) 2x6 w/ 2x6 WALLS, UNLESS OTHERWISE NOTED.

2. ALL HEADERS TO HAVE (1) 2x4 OR 2x6 JACK AND KING

RYAN

- STUD EACH END, UNLESS OTHERWISE NOTED.

 3. ALL EXTERIOR WALLS TO BE 4" W/ OSB OR 3 I/2"
 W/ T-PLY, ALL INTERIOR WALLS TO BE 3 I/2", UNLESS
- OTHERWISE NOTED. . HATCHED AREAS INDICATE DROPPED CEILINGS. ALL DROPPED CEILINGS ARE 12" UNLESS OTHERWISE NOTED.
 . SEE "BRACED WALL PANEL DETAIL SHEET" FOR SPECIAL
- WALL FRAMING LOCATIONS AND HEADER SIZES, IF APPLICABLE.

 6. SEE STANDARD DETAIL CATEGORY "IT" SHEET(S) FOR INTERIOR TRIM DETAILS.

 7. SEE ASIAN DETAIL SHEET "AD" FOR HOUSE (CORRECT OF TRIM OPTION TABLE)
- SPECIFIC INTERIOR TRIM OPTION TABLE.
- ALL WINDOWS HAVE 7'-0 1/2" HEADER HEIGHT UNLESS OTHERWISE NOTED.
- 9. ALL HEADERS IN NON-BEARING WALLS SHALL BE A SINGLE FLAT 2X4 OR 2X6 ATTACHED TO CRIPPLES ABOVE, UNLESS OTHERWISE NOTED.

 10. TANKED WATER HEATER SHOWN AS BASE CONDITION, OPTIONAL TANKLESS WATER HEATER IS AVAILABLE IN LIEU OF TANKED WATER HEATER.


GYPSUM NOTES

AT GARAGE:


GYPSUM BOARD AT COMMON WALLS, CEILINGS, BEAM WRAPS AND SUPPORTS PER STANDARD DETAIL FA-I(b) FIRE ASSEMBLIES OR AS REQUIRED BY LOCAL CODE.

AT STAIRS:

1/2" GYPSUM BOARD AT UNDERSIDE OF STAIRS AND WALLS

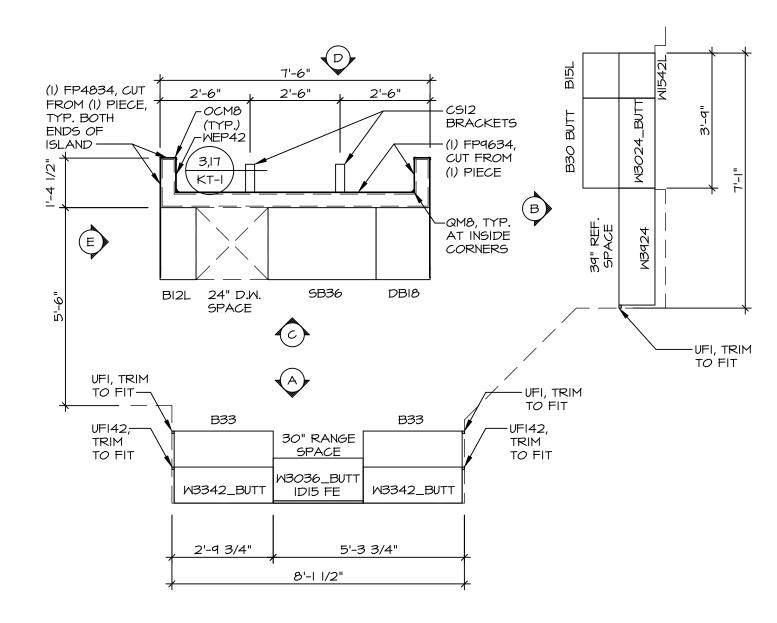




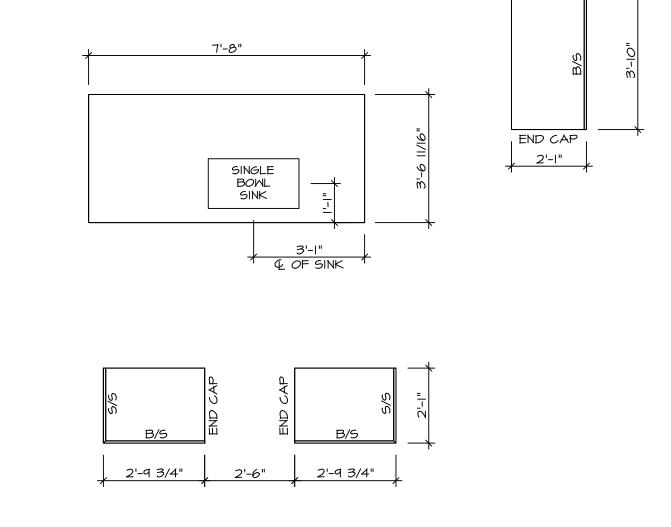


KITCHEN COUNTERTOP


PLAN KC - 3489


SCALE: 3/8" = 1'-0"

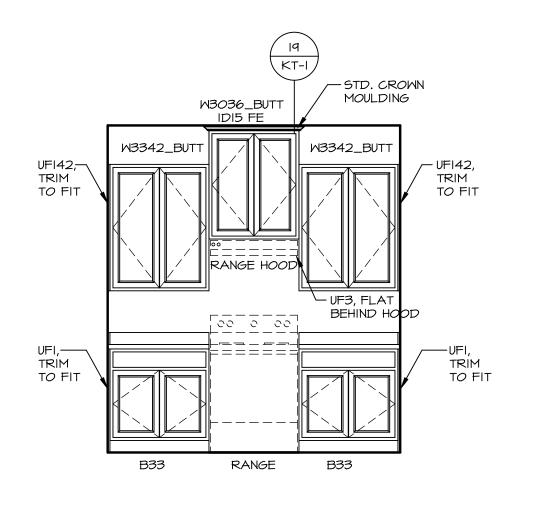


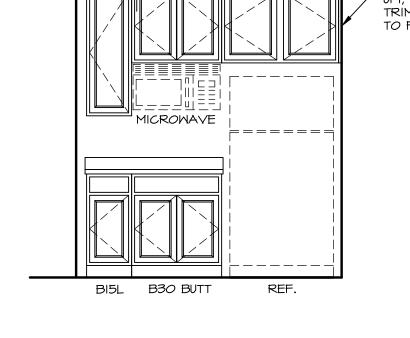

WI542L W3024_BUTT W3924

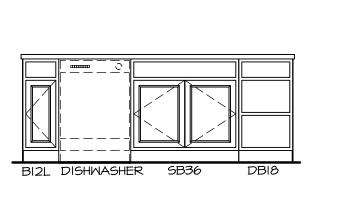

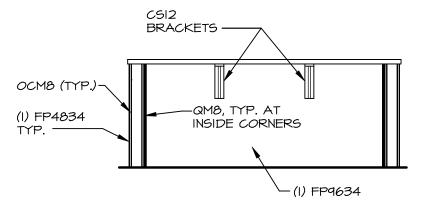

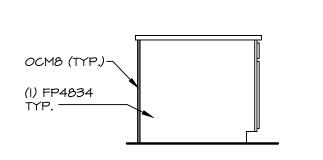










ELEVATION "E"


SCALE: 3/8" = 1'-0"

NOTE:
CABINET LAYOUT(S) ARE
BASED ON FINISHED
DIMENSION TO DRYWALL.


NOTE:
KITCHEN ELEVATIONS/PLANS CALL
OUT STANDARD MOLDING. REFER TO
DETAIL II/KT-I FOR REPLACEMENT
BASED ON CABINET STYLE.

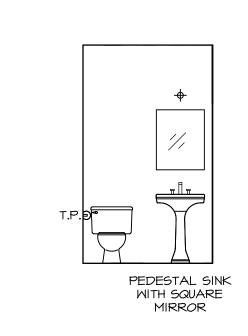




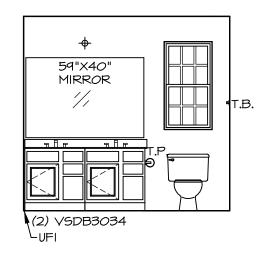




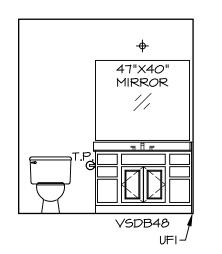



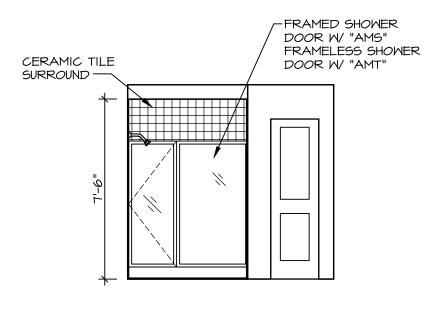



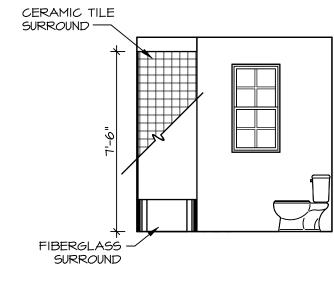



NOTES:

- TEMPERED GLASS SHOWER
 ENCLOSURE WITH SWING DOOR OR
 OPTIONAL SLIDING DOOR BY DIVISION
 TUB ACCESS PANELS PROVIDED AS
 NEEDED, ALL MATERIALS BY DIVISION
 REFER TO SHEET IT-2 FOR TUB AND
 SHOWER DETAILS.
 ALL VSDB24-42 DRAWERS TO BE SET ON
 RIGHT HAND.
 ALL BATH ELEVATIONS ARE SHOWN PER PLAN.

MODEL **EGHENY**DRAWING TITLE

BATH ELEVATIONS