

FLOOR PLAN NOTES

- I. ALL HEADERS ARE (2) 2x6 W 2x4 WALLS OR (3) 2x6 W 2x6 WALLS, UNLESS OTHERWISE NOTED.

 2. ALL HEADERS TO HAVE (1) 2x4 OR 2x6 JACK AND KING
- STUD EACH END, UNLESS OTHERWISE NOTED.

 3. ALL EXTERIOR WALLS TO BE 4" W 05B OR 3 1/2"
 W/ T-PLY, ALL INTERIOR WALLS TO BE 3 1/2", UNLESS
 OTHERWISE NOTED.
- 4. HATCHED AREAS INDICATE DROPPED CEILINGS. ALL
 DROPPED CEILINGS ARE 12" UNLESS OTHERWISE NOTED.

 5. SEE "BRACED WALL PANEL DETAIL SHEET" FOR SPECIAL
 WALL FRAMING LOCATIONS AND HEADER SIZES, IF
- APPLICABLE.

 6. SEE STANDARD DETAIL CATEGORY "IT" SHEET(S) FOR INTERIOR TRIM DETAILS.
- 7. SEE ARCHITECTURAL DETAIL SHEET "AD" FOR HOUSE SPECIFIC INTERIOR TRIM OPTION TABLE.

 8. ALL WINDOWS HAVE T-O 1/2" HEADER HEIGHT UNLESS
- OTHERWISE NOTED.

 ALL HEADERS IN NON-BEARING WALLS SHALL BE A SINGLE FLAT 2X4 OR 2X6 ATTACHED TO CRIPPLES
- ABOVE, UNLESS OTHERWISE NOTED.

 10. TANKED WATER HEATER SHOWN AS BASE CONDITION, OPTIONAL TANKLESS WATER HEATER IS AVAILABLE IN LIEU OF TANKED WATER HEATER.


GYPSUM NOTES

AT GARAGE:

GYPSUM BOARD AT COMMON WALLS, CEILINGS, BEAM WRAPS AND SUPPORTS PER STANDARD DETAIL FA-I(b) FIRE ASSEMBLIES OR AS REQUIRED BY LOCAL CODE.

AT STAIRS:

1/2" SYPSUM BOARD AT UNDERSIDE OF STAIRS AND WALLS IN CLOSET

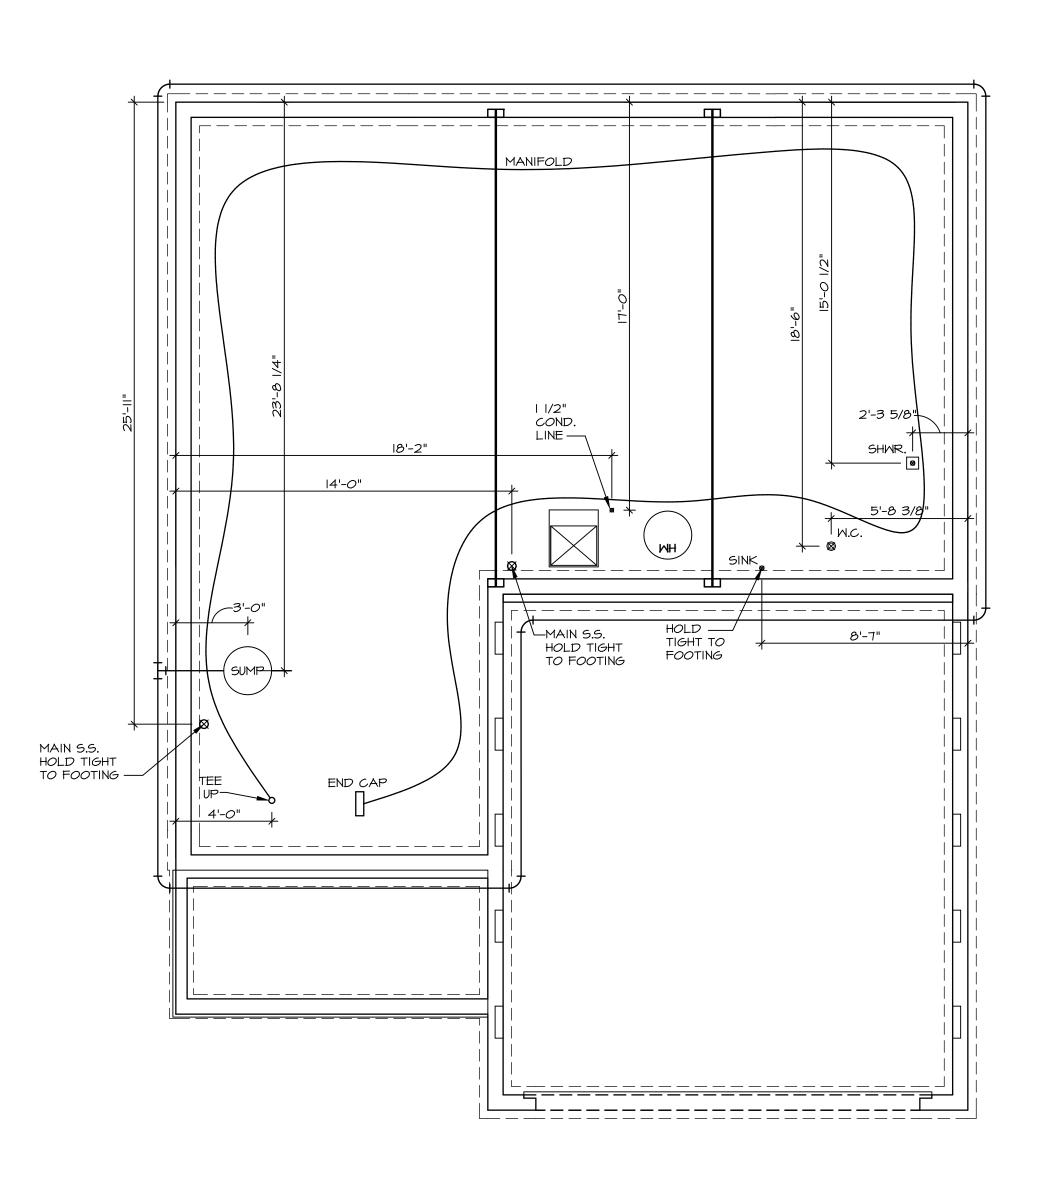





RADON REMEDIATION
RADON REMEDIATION
RADON LODS:

- (4') PERFORATED HOPE 'LOOP'
- MIDST BE PLACED IN STONE BED SLIGHTLY HIGHER THAN ANY INTERIOR DRAINTILE
- LOOP TO BE SEPARATE PROMANY DRAINTILE ELEMENTS
- SCREWS TO BE INSTALLED THROUGH LOOP AT THE UP INTO STACK
STACK REQUIREMENTS.
- 3' PVC STACK (4') IF BASENEST IS GREATER THAN 2200 SGFT)
- MO PART OF STACK (5') TO BE HOST ZONEST IN SADON VENT OR OTHER
- SCREWS TO SE INSTALLED THROUGH LOOP AT THE UP INTO STACK
- 10 PART OF STACK (4') IF BASENEST IS GREATER THAN 2200 SGFT)
- MO PART OF STACK (5') TO BE HOST ZONEST IN SADON VENT OR OTHER
- RIPISCOCK PRINSTALL PLANT CHEEKE ON THE PRINSTALL PLANT CHEEKE OF THE P

REMARKS	
REV. NO. DATE	
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NVR	NVR, Inc. Architectural Services Architects 5285 Westview Drive, Suite 100 Frederick, MD 21703
SET NO. ALGOO VERSION OI DRAWN BY TN DATE: OB/O9/2017	OPTION
>	No
	OPTION DESCRIPTION
	EGHENY VERSION OI BRAWN BY TN DATE: O8/O9/2017 SET NO. ALGOO NVR. Inc owner, expressly reserves its common law copyright and other property rights in these plans. These plans are not to be reproduced, changed, or copied in any form or manner whatsoever, any form or manner whatsoever, any form of party, without first any third party, without first

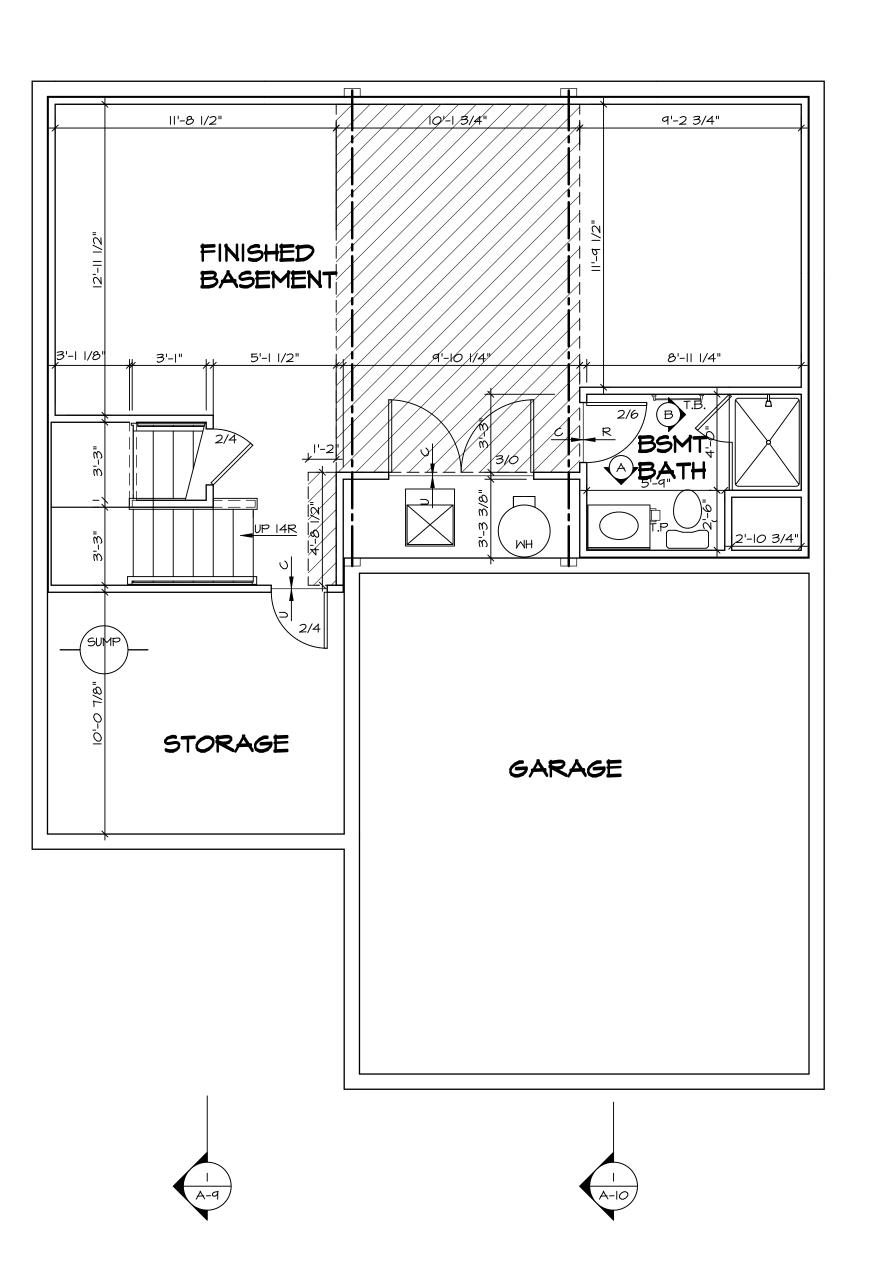



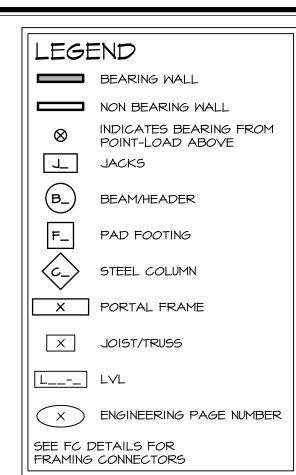

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 2. ALL HEADERS TO HAVE (1) 2x4 OR 2x6 JACK AND KING STUD EACH END, UNLESS OTHERWISE NOTED.
- 3. ALL EXTERIOR WALLS TO BE 4" W/ OSB OR 3 1/2" W/ T-PLY, ALL INTERIOR WALLS TO BE 3 1/2", UNLESS OTHERWISE NOTED.
- 4. HATCHED AREAS INDICATE DROPPED CEILINGS. ALL
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- 6. SEE STANDARD DETAIL CATEGORY "IT" SHEET(S) FOR INTERIOR TRIM DETAILS.
- 7. SEE ARCHITECTURAL DETAIL SHEET "AD" FOR HOUSE SPECIFIC INTERIOR TRIM OPTION TABLE.

 8. ALL WINDOWS HAVE 7'-0 1/2" HEADER HEIGHT UNLESS
- OTHERWISE NOTED.

 9. ALL HEADERS IN NON-BEARING WALLS SHALL BE A SINGLE FLAT 2X4 OR 2X6 ATTACHED TO CRIPPLES
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AT STAIRS:

1/2" GYPSUM BOARD AT UNDERSIDE OF STAIRS AND WALLS






	FIRST FLOOR J	IACK SCHE	DULE	
IDENTIFIER	DESCRIPTION	OPTIONS	ENG. NUM.	REMARKS
IOIL	JACK - (2) 2X4 SPF STUD GRADE		1004	
JIO2	JACK - (2) 2X6 SPF STUD GRADE		1004	
SOIL	JACK - (5) 2X4 SP#I		1008	
JIO4	JACK - (5) 2X4 SP#I		1008	
TOIL	JACK - (2) 2X6 SPF #2	ELC	1014	
80IL	JACK - (2) 2X4 SPF STUD GRADE	ELC	1014	
POIL	JACK - (2) 2X6 SPF STUD GRADE	ELC	1016	
OIL	JACK - (3) 2X4 SPF STUD GRADE	ELC	1016	
III	JACK - (2) 2X4 SPF STUD GRADE		1025	
JII2	JACK - (2) 2X4 SPF STUD GRADE		1025	
SIIL	JACK - (2) 2X4 SPF STUD GRADE		1033	
JII5	JACK - (2) 2X4 SPF STUD GRADE		1006	
J120	JACK - (2) 2X4 SPF STUD GRADE		1027	
JI2I	JACK - (2) 2X4 SPF STUD GRADE		1027	
JI22	JACK - (2) 2X4 SPF STUD GRADE		1027	
JI24	JACK - (2) 2X4 SPF STUD GRADE		1027	_


FIELD INSTALLED FIRST FLOOR BEAM/HEADER SCHEDULE					
IDENTIFIER	DESCRIPTION	LENGTH	OPTIONS	ENG. NUM.	REMARKS
BIOI	BEAM STEEL - WIOX30	20'-6"		1008	

	STEFI	COLUMN	SCHEDULE		
	J 1 L L 1	- OOLOPIN			
IDENTIFIER	STYLE	HEIGHT	OPTIONS	ENG. NUM.	REMARKS

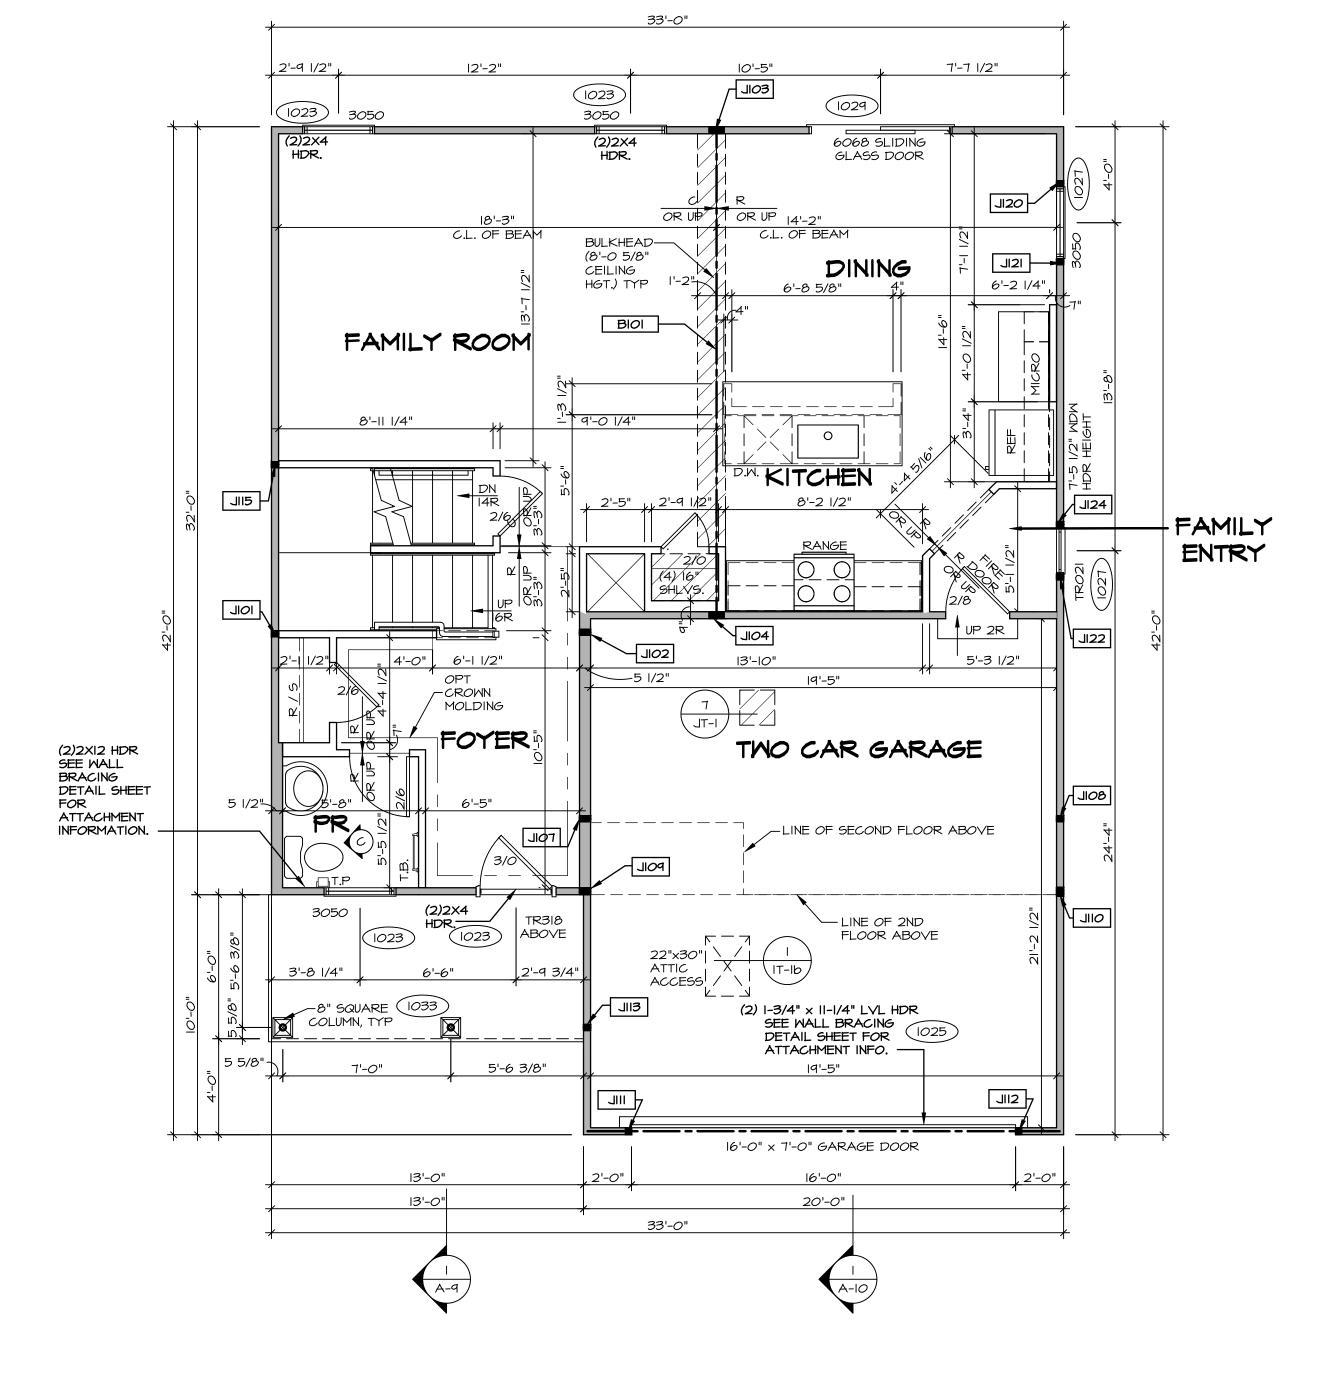

FIRST FLOOR PLAN

SCALE: 1/4" = 1'-0"

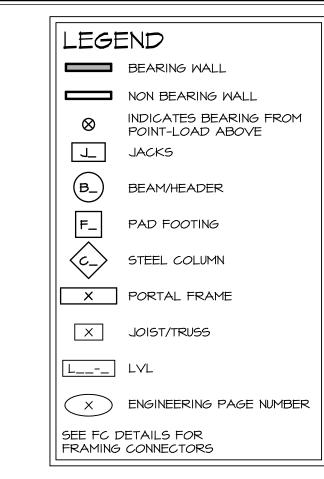

	FRAMING CONNECTORS
F	LOOR PLAN NOTES RYAN
١.	ALL HEADERS ARE (2) 2x6 w/ 2x4 WALLS OR (3) 2x6 w/
	2x6 WALLS, UNLESS OTHERWISE NOTED.
2.	ALL HEADERS TO HAVE (I) 2x4 OR 2x6 JACK AND KING
	STUD EACH END, UNLESS OTHERWISE NOTED.
3.	ALL EXTERIOR WALLS TO BE 4" w/ OSB OR 3 1/2"
	W/ LAMINATED FIBROUS STRUCTURAL SHEATHING, ALL
,	INTERIOR WALLS TO BE 3 1/2", UNLESS OTHERWISE NOTED.
4.	HATCHED AREAS INDICATE DROPPED CEILINGS. ALL
=	DROPPED CEILINGS ARE 12" UNLESS OTHERWISE NOTED. SEE "BRACED WALL PANEL DETAIL SHEET" FOR SPECIAL
Э.	WALL FRAMING LOCATIONS AND HEADER SIZES, IF
	APPLICABLE.
6	SEE STANDARD DETAIL CATEGORY "IT" SHEET(S) FOR
٥.	INTERIOR TRIM DETAILS.
7.	SEE ARCHITECTURAL DETAIL SHEET "AD" FOR HOUSE
	SPECIFIC INTERIOR TRIM OPTION TABLE.
8.	ALL WINDOWS HAVE 7'-0 1/2" HEADER HEIGHT UNLESS
	OTHERWISE NOTED.
9.	ALL HEADERS IN NON-BEARING WALLS SHALL BE A
	SINGLE FLAT 2X4 OR 2X6 ATTACHED TO CRIPPLES
	ABOVE, UNLESS OTHERWISE NOTED.
10.	TANKED WATER HEATER SHOWN AS BASE CONDITION,
	OPTIONAL TANKLESS WATER HEATER IS AVAILABLE IN
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GYPSUM NOTES


AT GARAGE:

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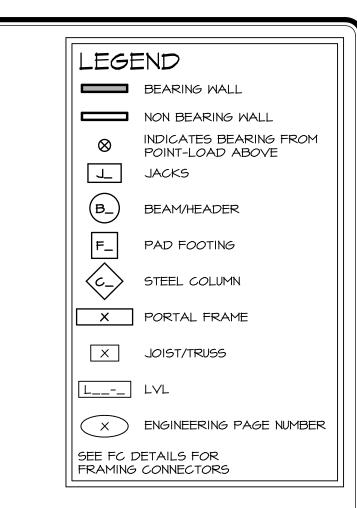
AT STAIRS:

1/2" GYPSUM BOARD AT UNDERSIDE OF STAIRS AND WALLS IN CLOSET NVR, Inc.

Architectural Services



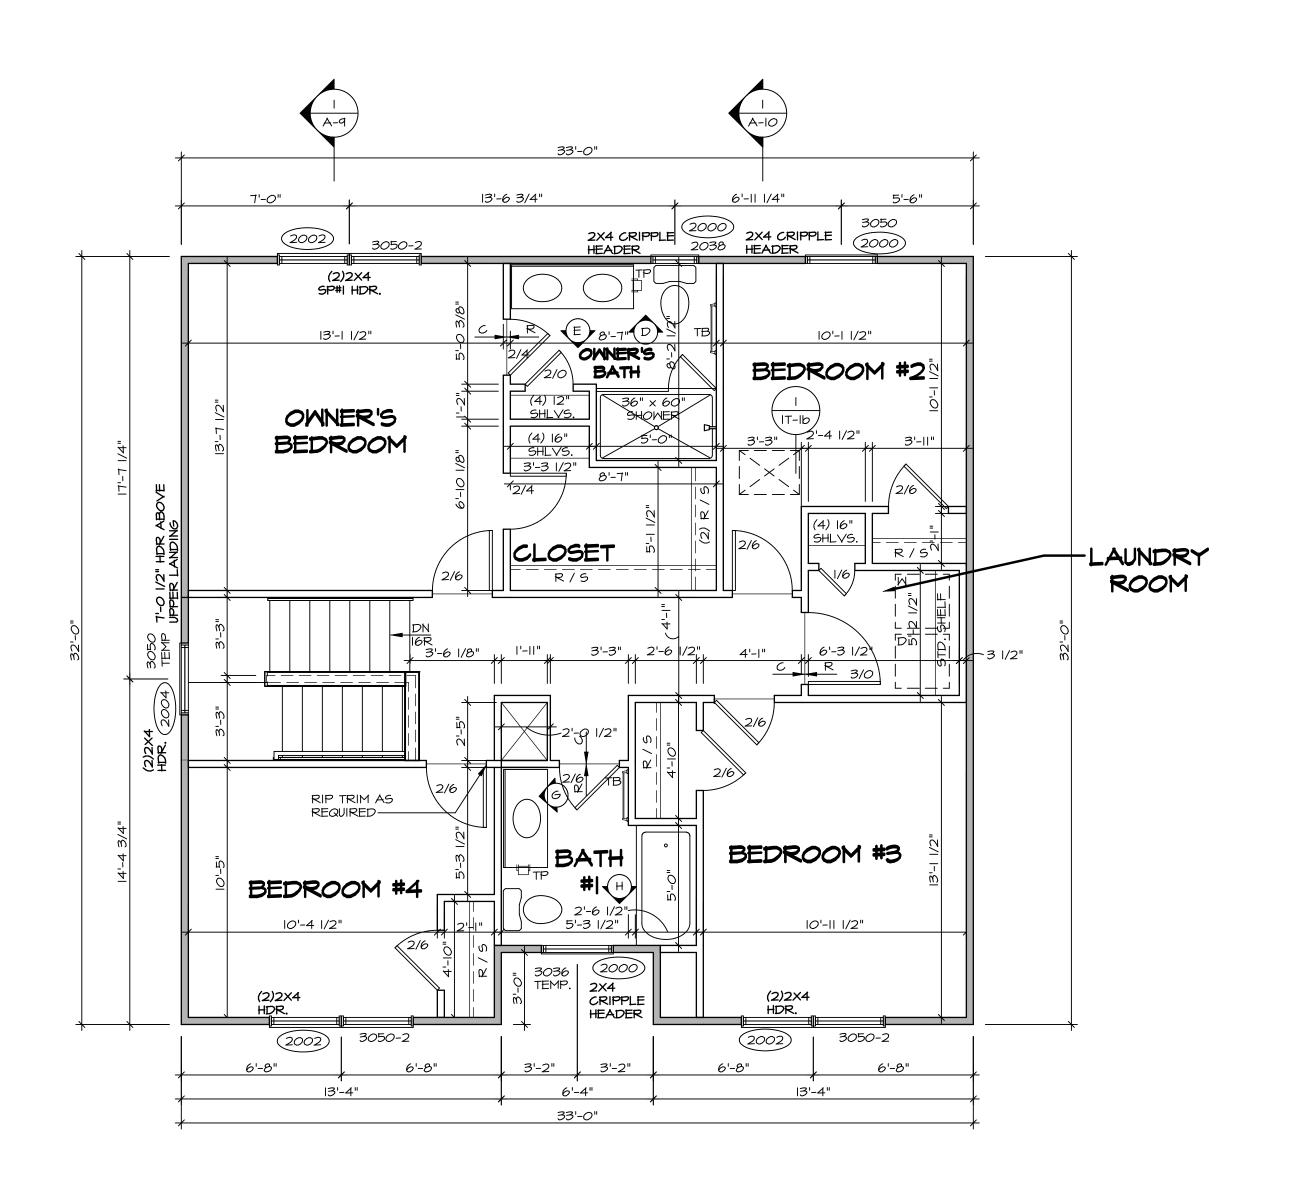



RYAN

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- 8. ALL WINDOWS HAVE 7'-0 I/2" HEADER HEIGHT UNLESS OTHERWISE NOTED.
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1/2" GYPSUM BOARD AT UNDERSIDE OF STAIRS AND WALLS IN CLOSET essly
aw copyright
hits in these
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or copied in
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NVR, Inc. Architectural Services Architects 285 Westview Drive, Suite 100 Frederick, MD 21703

DRAWN BY YON

DATE: OB/IO/2017


OPTION

OR PLAN


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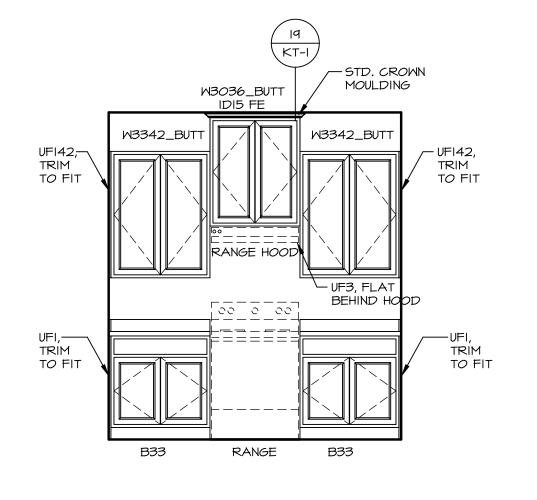






KITCHEN COUNTERTOP

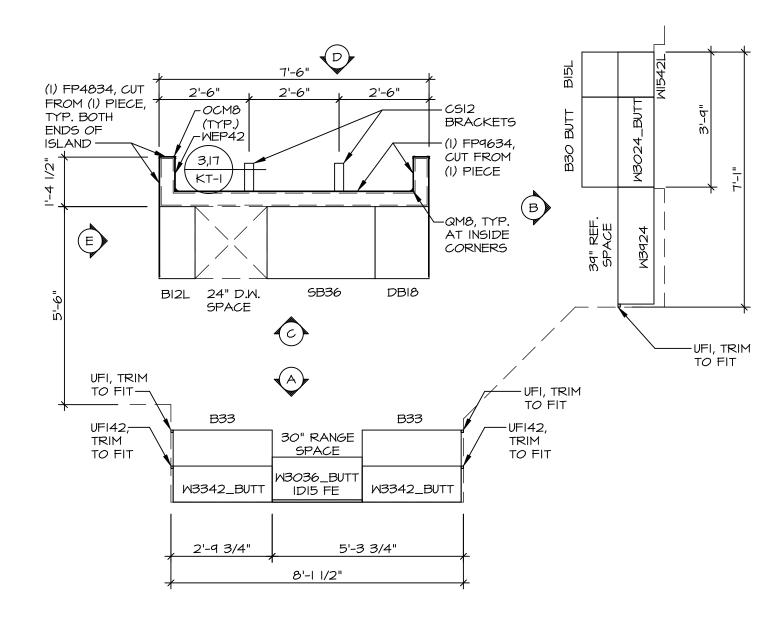
PLAN KC - 3489


SCALE: 3/8" = 1'-0"

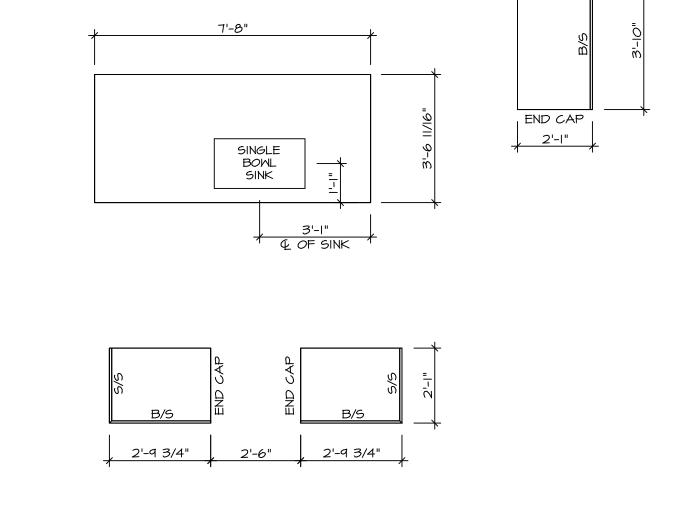

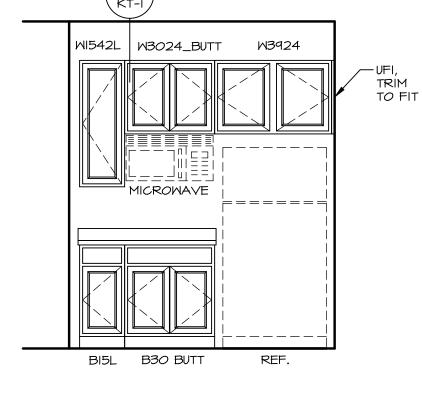

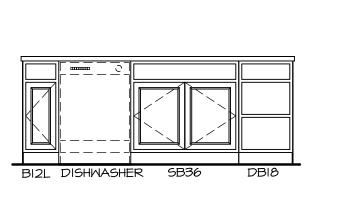

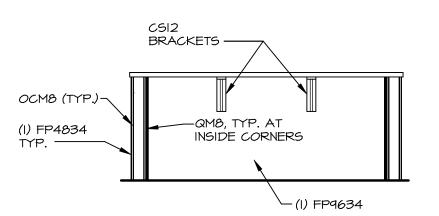

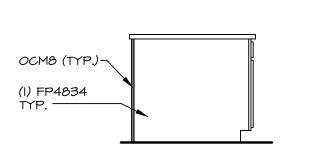










E ELEVATION "E"


SCALE: 3/8" = 1'-0"

NOTE:
CABINET LAYOUT(S) ARE
BASED ON FINISHED
DIMENSION TO DRYWALL.


NOTE:
KITCHEN ELEVATIONS/PLANS CALL
OUT STANDARD MOLDING. REFER TO
DETAIL II/KT-I FOR REPLACEMENT
BASED ON CABINET STYLE.

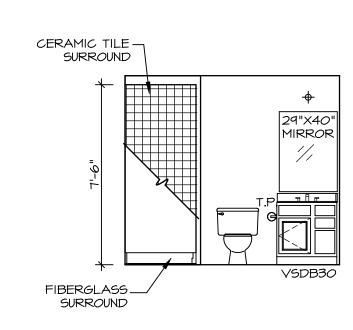




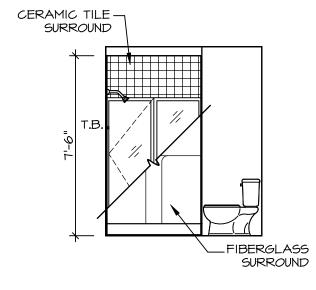




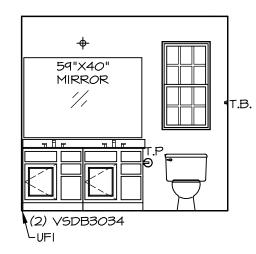




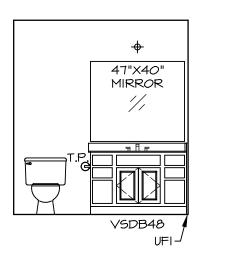




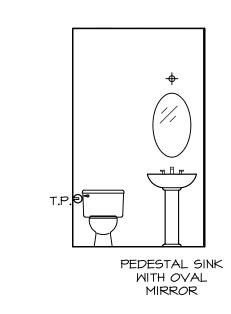



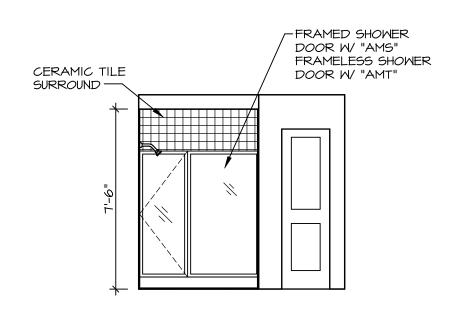



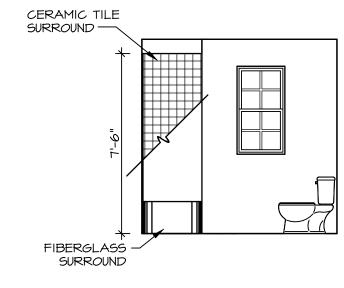



NOTES:

- TEMPERED GLASS SHOWER
 ENCLOSURE WITH SWING DOOR OR
 OPTIONAL SLIDING DOOR BY DIVISION
 TUB ACCESS PANELS PROVIDED AS
 NEEDED, ALL MATERIALS BY DIVISION
 REFER TO SHEET IT-2 FOR TUB AND
 SHOWER DETAILS.
 ALL VSDB24-42 DRAWERS TO BE SET ON
 RIGHT HAND.
 ALL BATH ELEVATIONS ARE SHOWN PER PLAN.

MODEL
ALLEGHENY
DRAWING TITLE
BATH ELEVATIONS