



PLUMBING PLAN

SCALE: 1/4" = 1'-0"

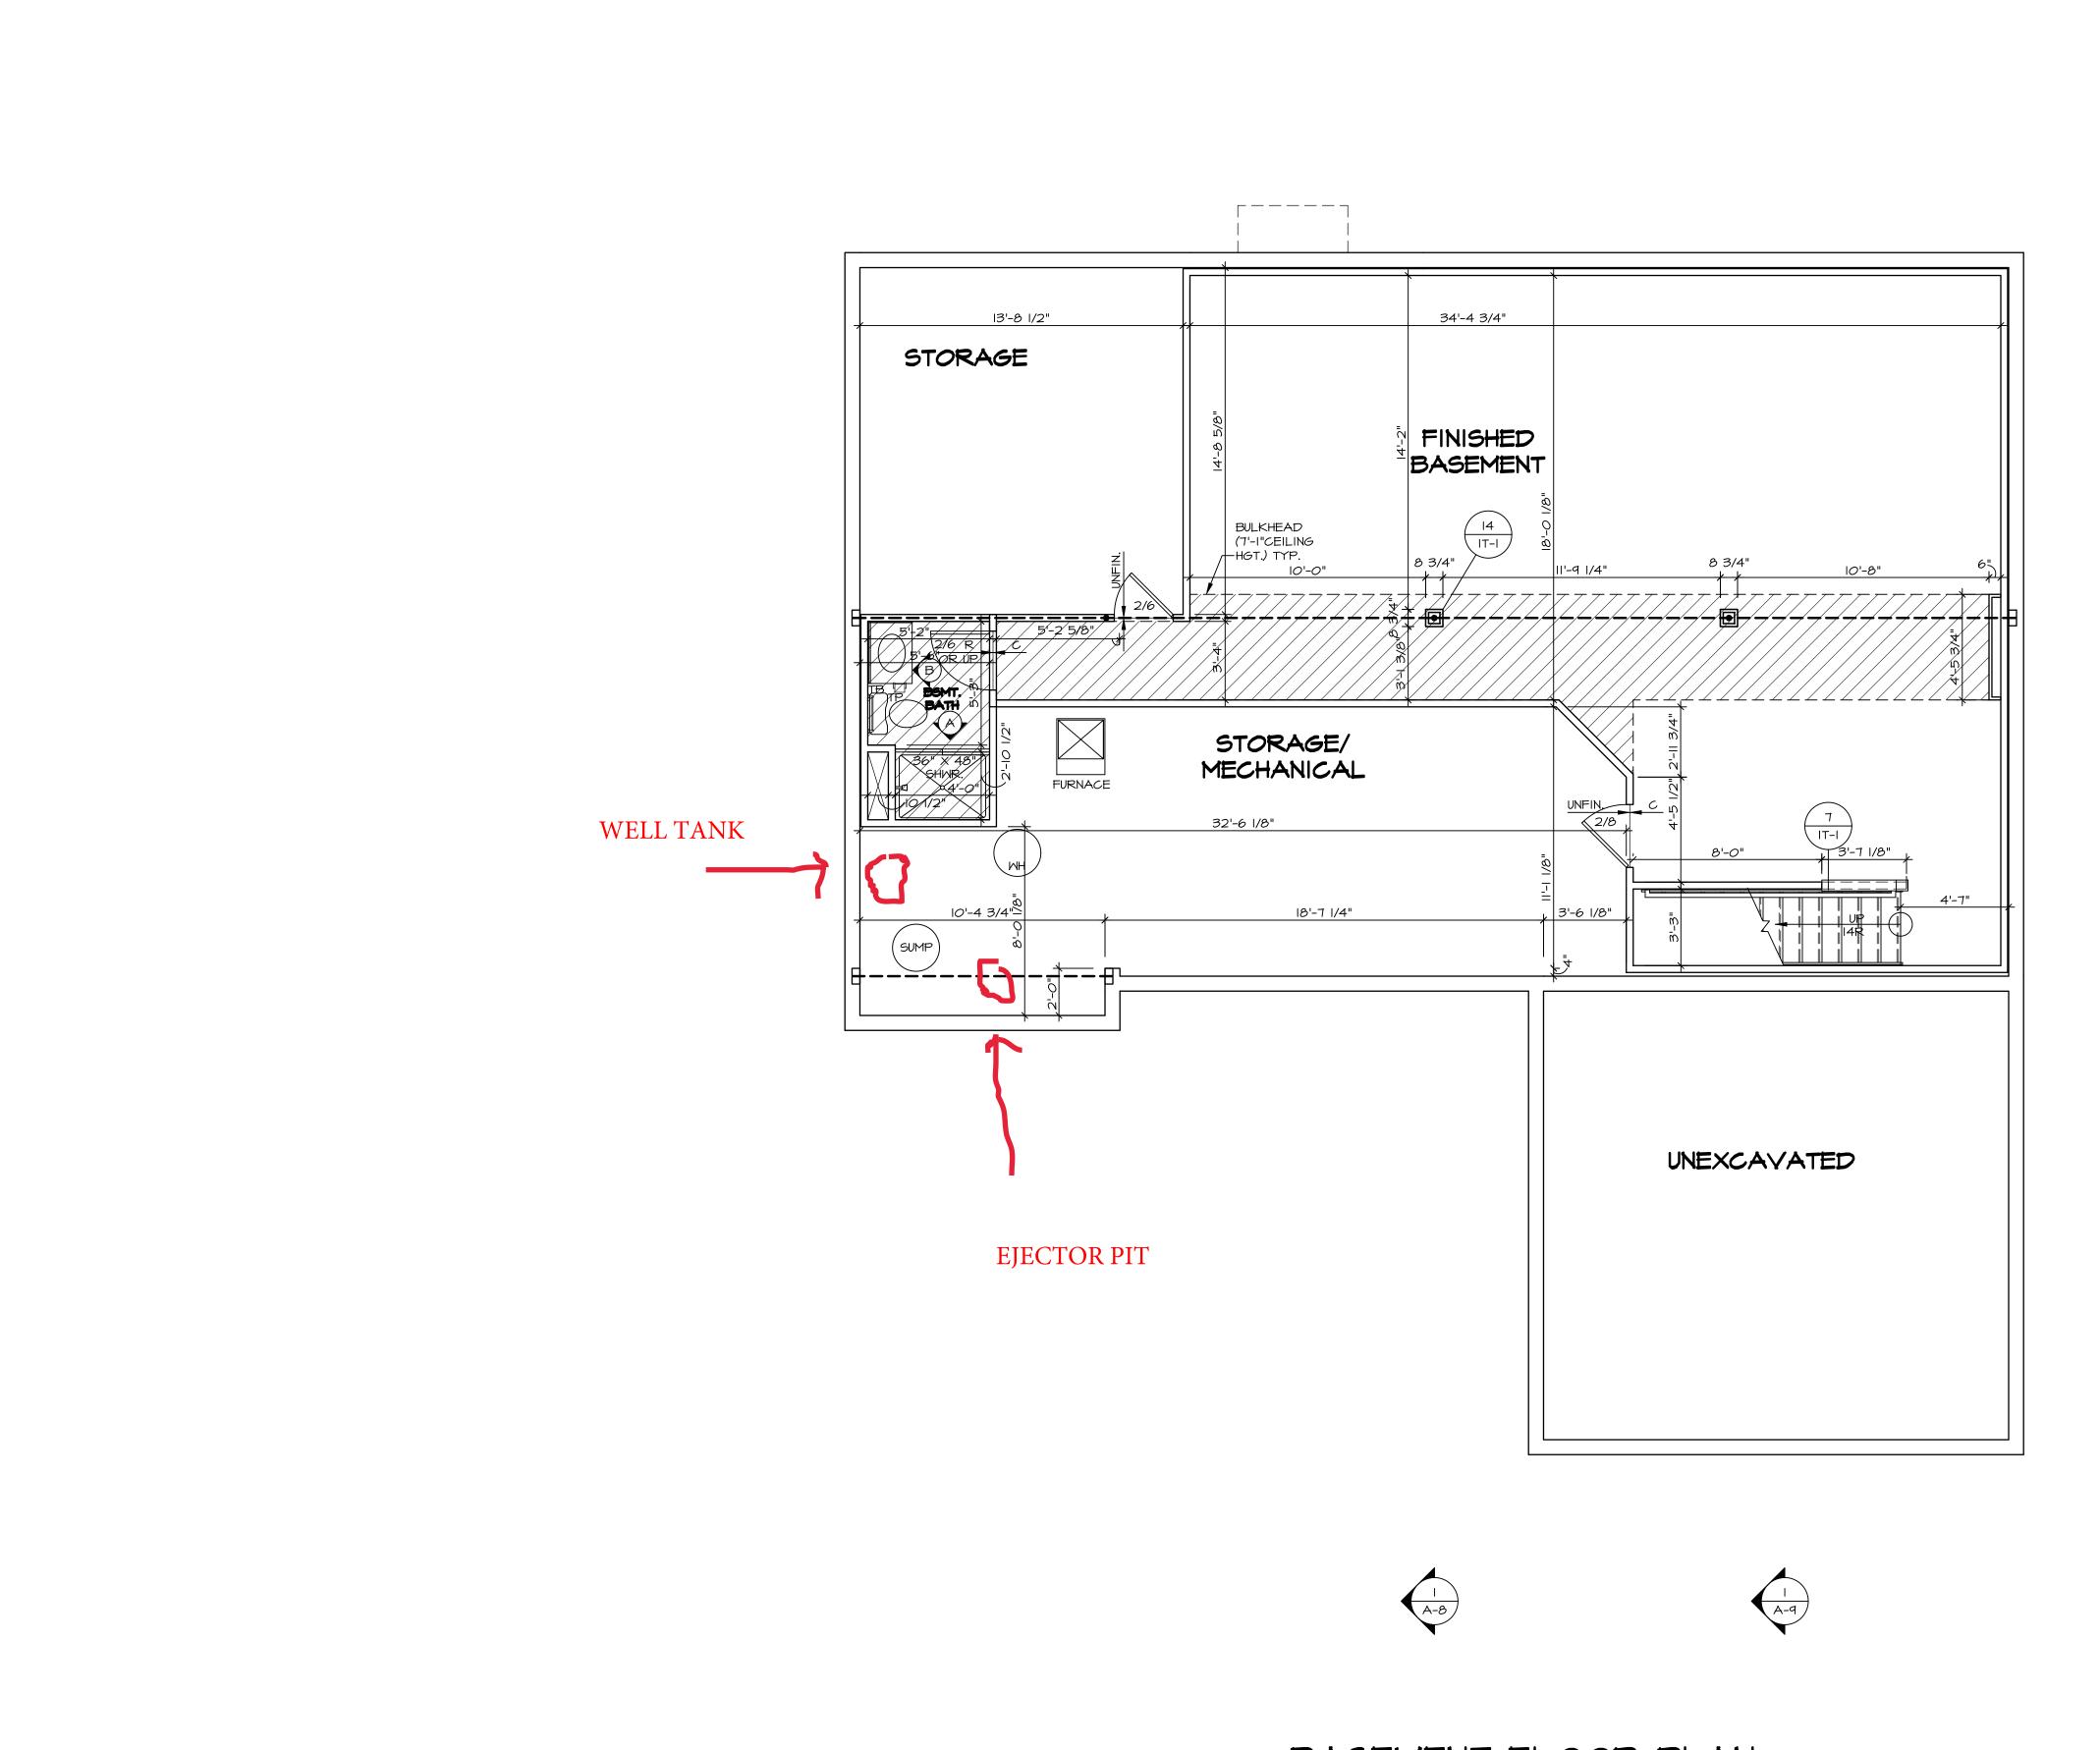

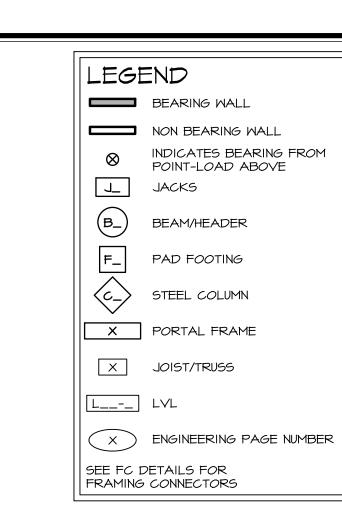

FLOOR PLAN NOTES

ALL HEADERS ARE (2) 2x6 W/ 2x4 WALLS OR (3) 2x6 W/ 2x6 WALLS, UNLESS OTHERWISE NOTED. 2. ALL HEADERS TO HAVE (1) 2x4 OR 2x6 JACK EACH END, UNLESS OTHERWISE NOTED.

3. ALL EXTERIOR WALLS TO BE 4" AND ALL INTERIOR WALLS TO BE 3 I/2", UNLESS OTHERWISE NOTED
4. HATCHED AREAS INDICATE DROPPED CEILINGS. ALL DROPPED CEILINGS ARE I2" UNLESS OTHERWISE NOTED.

SEE "BRACED WALL PANEL DETAIL SHEET" FOR SPECIAL WALL FRAMING LOCATIONS AND HEADER SIZES, IF

APPLICABLE. 6. SEE STANDARD DETAIL CATEGORY "IT" SHEET(S) FOR INTERIOR TRIM DETAILS.

SEE ARCHITECTURAL DETAIL SHEET "AD" FOR HOUSE SPECIFIC INTERIOR TRIM OPTION TABLE.

ALL WINDOWS HAVE 7'-0 1/2" HEADER HEIGHT UNLESS OTHERWISE NOTED.

GYPSUM NOTES


AT GARAGE:

GYPSUM BOARD AT COMMON WALLS, CEILINGS, BEAM WRAPS AND SUPPORTS PER STANDARD DETAIL FA-I(b) FIRE ASSEMBLIES OR AS REQUIRED BY LOCAL CODE.


AT STAIRS:

1/2" GYPSUM BOARD AT UNDERSIDE OF STAIRS AND WALLS IN CLOSET

BASEMENT FLOOR PLAN A-6 SCALE: 1/4" = 1'-0"

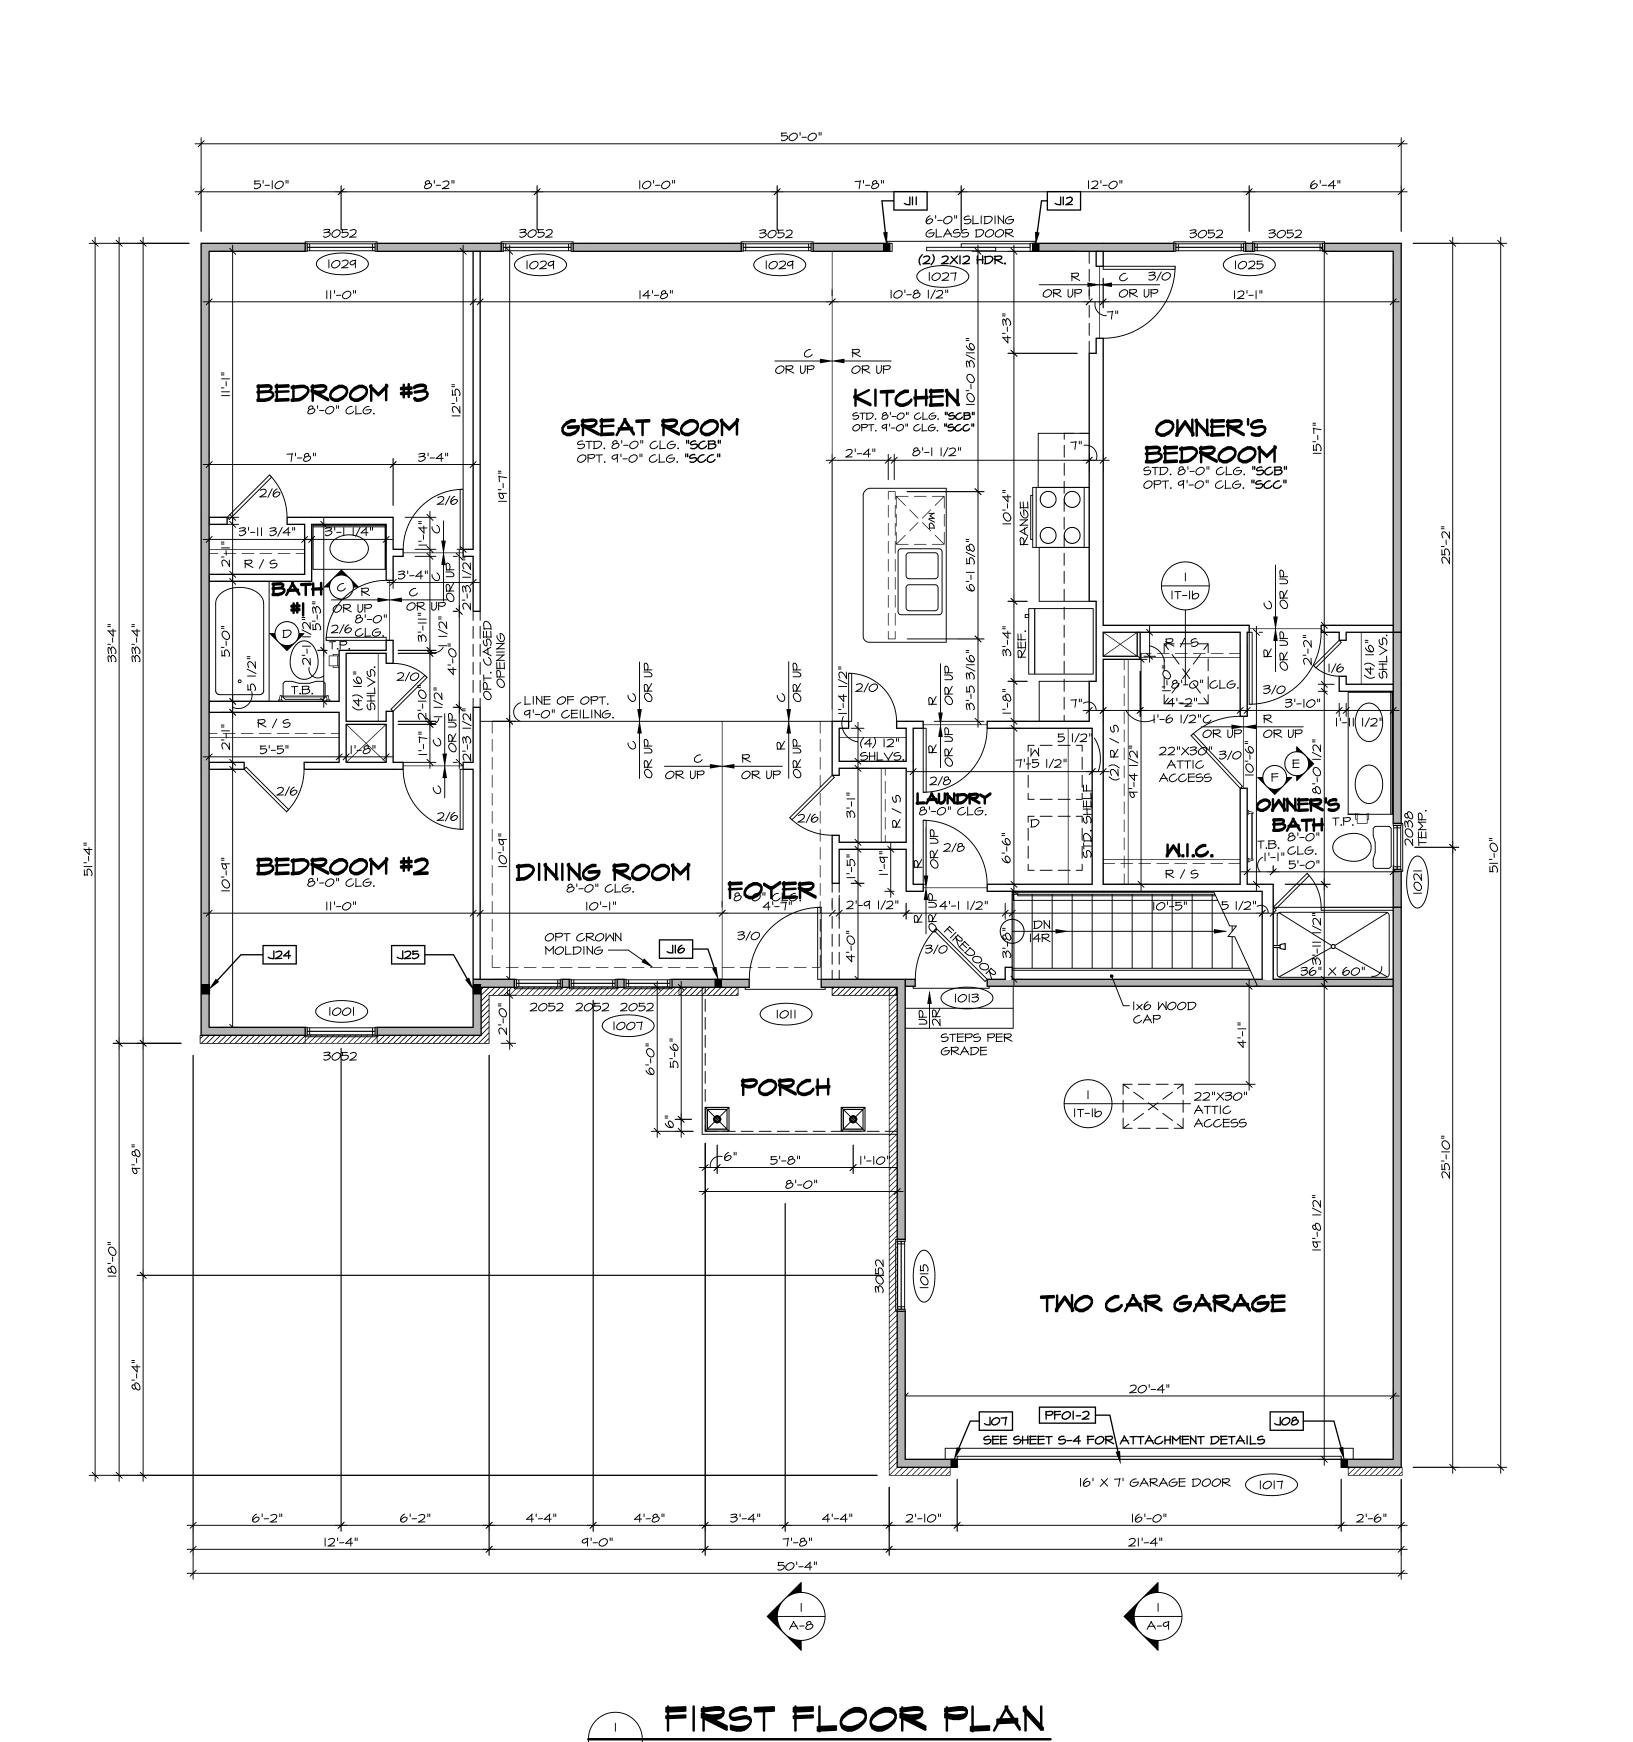

SCALE: 1/4" = 1'-0"

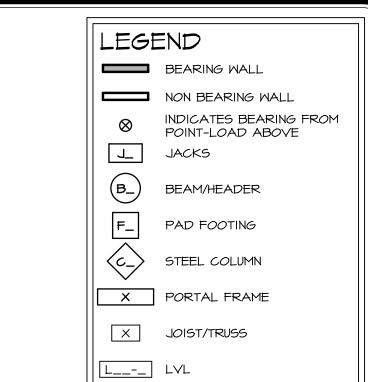

X ENGINEERING PAGE NUMBER

FLOOR PLAN NOTES

ALL HEADERS ARE (2) 2x6 w/ 2x4 WALLS OR (3) 2x6 w/ 2x6 WALLS, UNLESS OTHERWISE NOTED.
 ALL HEADERS TO HAVE (I) 2x4 OR 2x6 JACK AND KING STUD EACH END, UNLESS OTHERWISE NOTED.
 ALL EXTERIOR WALLS TO BE 4" w/ OSB OR 3 I/2" w/ T-PLY, ALL INTERIOR WALLS TO BE 3 I/2", UNLESS

SEE FC DETAILS FOR FRAMING CONNECTORS

OTHERWISE NOTED.

4. HATCHED AREAS INDICATE DROPPED CEILINGS. ALL DROPPED CEILINGS ARE 12" UNLESS OTHERWISE NOTED.

5. SEE "BRACED WALL PANEL DETAIL SHEET" FOR SPECIAL

5. SEE "BRACED WALL PANEL DETAIL SHEET" FOR SPECIA WALL FRAMING LOCATIONS AND HEADER SIZES, IF APPLICABLE.6. SEE STANDARD DETAIL CATEGORY "IT" SHEET(S) FOR

INTERIOR TRIM DETAILS.

7. SEE ARCHITECTURAL DETAIL SHEET "AD" FOR HOUSE SPECIFIC INTERIOR TRIM OPTION TABLE.

8. ALL WINDOWS HAVE 7'-0 1/2" HEADER HEIGHT UNLESS OTHERWISE NOTED.

ALL HEADERS IN NON-BEARING WALLS SHALL BE A SINGLE FLAT 2X4 OR 2X6 ATTACHED TO CRIPPLES ABOVE, UNLESS OTHERWISE NOTED.

GYPSUM NOTES

AT GARAGE:

GYPSUM BOARD AT COMMON WALLS, CEILINGS, BEAM WRAPS AND SUPPORTS PER STANDARD DETAIL FA-I(b) FIRE ASSEMBLIES OR AS REQUIRED BY LOCAL CODE.

AT STAIRS:

1/2" GYPSUM BOARD AT UNDERSIDE OF STAIRS AND WALLS IN CLOSET

LVL PLY TO PLY FASTENING SCHEDULE:

- I.A (2) PLY UP TO AND INCLUDING II 7/8" TALL: FASTEN PLIES W/ (2) ROWS 16D NAILS AT 12" O.C. 2.A (2) PLY 14" TO AND 18" TALL (INCLUSIVE): FASTEN PLIES W/ (3) ROWS 16D NAILS AT 12" O.C. 3.A (2) PLY 20" TALL AND OVER: FASTEN PLIES W/ (4) ROWS 16D NAILS AT 12" O.C.
- 4.A (3) PLY UP TO AND INCLUDING II 7/8" TALL: FASTEN PLIES W/ (2) ROWS 16D NAILS AT 12" O.C. FROM EACH SIDE
- 5.A (3) PLY 14" TO AND 18" TALL (INCLUSIVE): FASTEN PLIES W/ (3) ROWS 16D NAILS AT 12" O.C. FROM EACH SIDE

6.A - (3) PLY 20" TALL AND OVER: FASTEN PLIES W/ (4) ROWS 16D NAILS AT 12" O.C. FROM EACH SIDE

FIELD INSTALLED FIRST FLOOR BEAM/HEADER SCHEDULE

IDENTIFIER DESCRIPTION LENGTH OPTIONS ENG. NUM. REMARKS

PFOI-2 EXT HEADER - 2XI2 - 2 PLY 20'-9" GCB 1017


FIRST FLOOR JACK SCHEDULE				
IDENTIFIER	DESCRIPTION	OPTIONS	ENG. NUM.	REMARKS
J07	JACK - (2) 2X4 SPF STUD GRADE	GCB	1017	
30L	JACK - (2) 2X4 SPF STUD GRADE	GCB	1017	
IIL	JACK - (2) 2X4 SPF STUD GRADE		1027	
JI2	JACK - (2) 2X4 SPF STUD GRADE		1027	
JI6	JACK - (2) 2X4 SPF STUD GRADE	ELB	1033	
J24	JACK - (3) 2X4 SPF STUD GRADE		1036	
J25	JACK - (3) 2X4 SPF STUD GRADE		1036	

SET NO. AIAOO
VERSION OI
DRAWN BY SGA
DATE: 9/9/15
OPTION
5285


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DRAWING TITLE
FIRST FLOOR PLAN


4

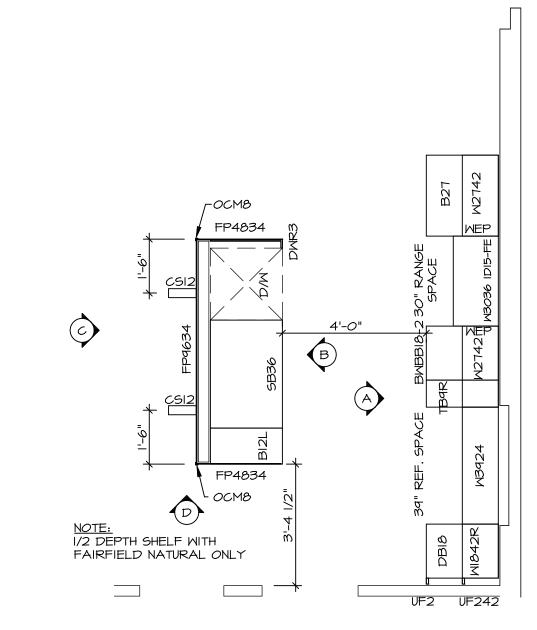


KITCHEN CABINET PLAN / KC-3431(TC) SCALE: 3/8" = 1'-0" ALTERNATE KITCHEN LAYOUT (TC) "KD2"

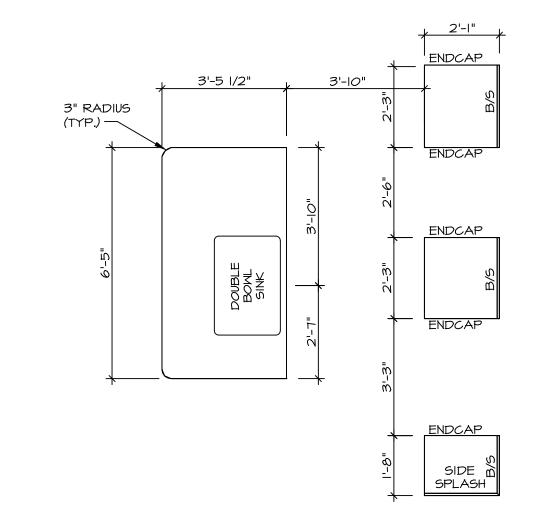



KITCHEN COUNTERTOP PLAN / KC-3431(TC) SCALE: 3/8" = 1'-0" ALTERNATE KITCHEN LAYOUT (TC) "KD2"

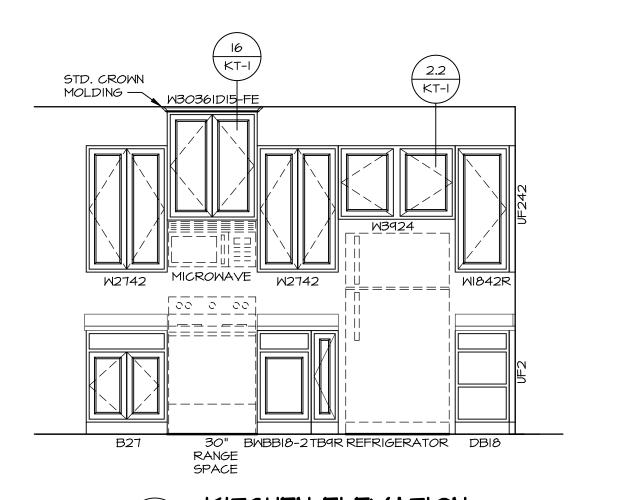

SCALE: 3/8" = I'-O" ALTERNATE KITCHEN LAYOUT (TC) **"KD2"**

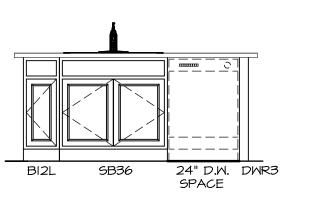

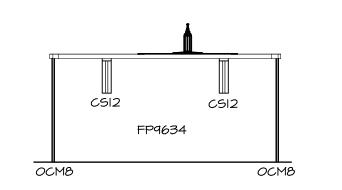

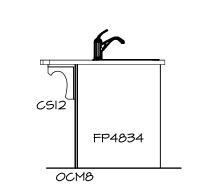









I. CABINET LAYOUT (S) ARE BASED ON FINISHED DIMENSIONS TO DRYWALL.

2. IF KITCHEN PLANS/ELEVATIONS CALL-OUT STANDARD MOLDING, REFER TO STANDARD DETAIL (II/KT-I) FOR REPLACEMENT BASED ON CABINET STYLE.

3. ALL (UF#) FILLERS ARE TO BE "TRIM TO FIT" UNLESS OTHERWISE NOTED.


4. CABINET MUST BE SET, SHIMMED, LEVELED AND PLUMB W AD KINING BASE CABINETS

AND PLUMB W/ ADJOINING BASE CABINETS.

5. SET PRE-FINISHED SCRIBE MOLDING AT CABINET BULKHEADS AND AT ENDS (WHERE CABINETS MEET DRYWALL.) PRE-FINISHED SCRIBE MOLDING SHALL BE USED TO PAD

OUT CABINET SIDES AT STILE FOR RETURN
PIECES OF THE FACE-MOUNTED CABINET
CROWN MOLDING.

6. HARDWARE INSTALL NOTE: KNOBS GO ON
OPERABLE DOORS AND DRAWERS FOR ALL
KITCHEN AND BATH AREAS. DRAWER FRONTS AND DOORS GET (I) KNOB/PULL. NO HARDWARE ON FALSE DRAWER FRONTS.

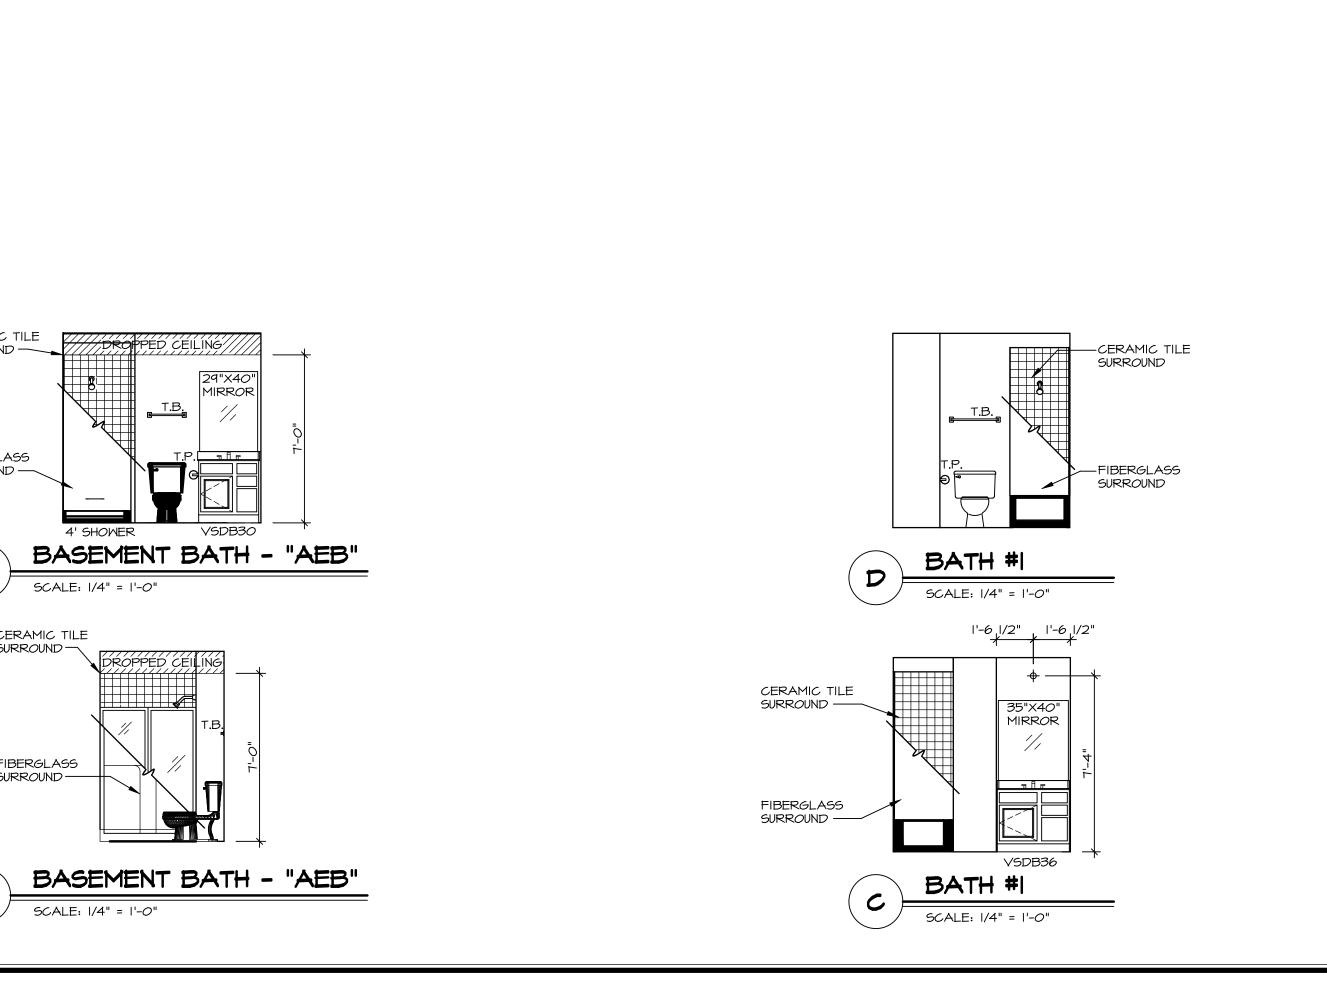


CERAMIC TILE SURROUND

FIBERGLASS
SURROUND —

CERAMIC TILE SURROUND

FIBERGLASS
SURROUND —

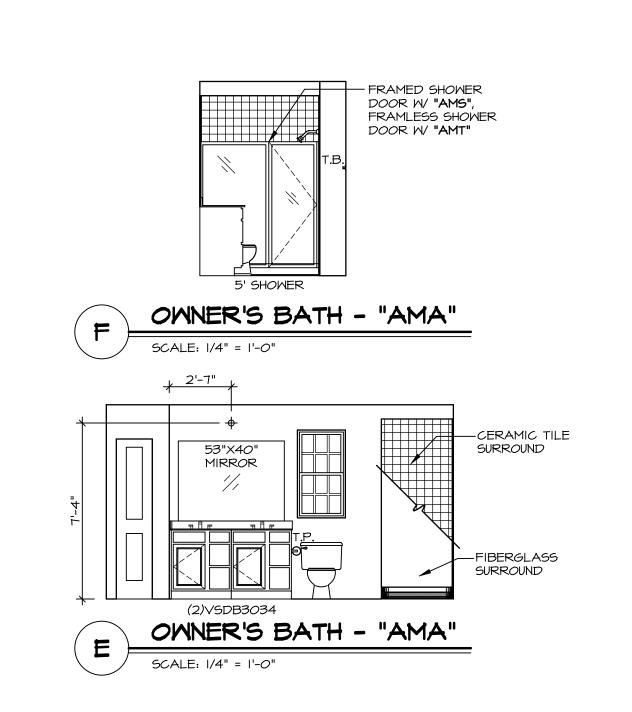

NOTES:

I. TEMPERED GLASS SHOWER ENCLOSURE WITH SWING DOOR OR

OPTIONAL SLIDING DOOR BY DIVISION

2. TUB ACCESS PANELS PROVIDED AS
NEEDED, ALL MATERIALS BY DIVISION
3. REFER TO SHEET IT-2 FOR TUB AND
SHOWER DETAILS.
4. ALL VSDB24-42 DRAWERS TO BE SET ON
RIGHT HAND.

5. BATH ELEVATIONS ARE SHOWN PER PLAN.

