



PLUMBING PLAN

SCALE: 1/4" = 1'-0"

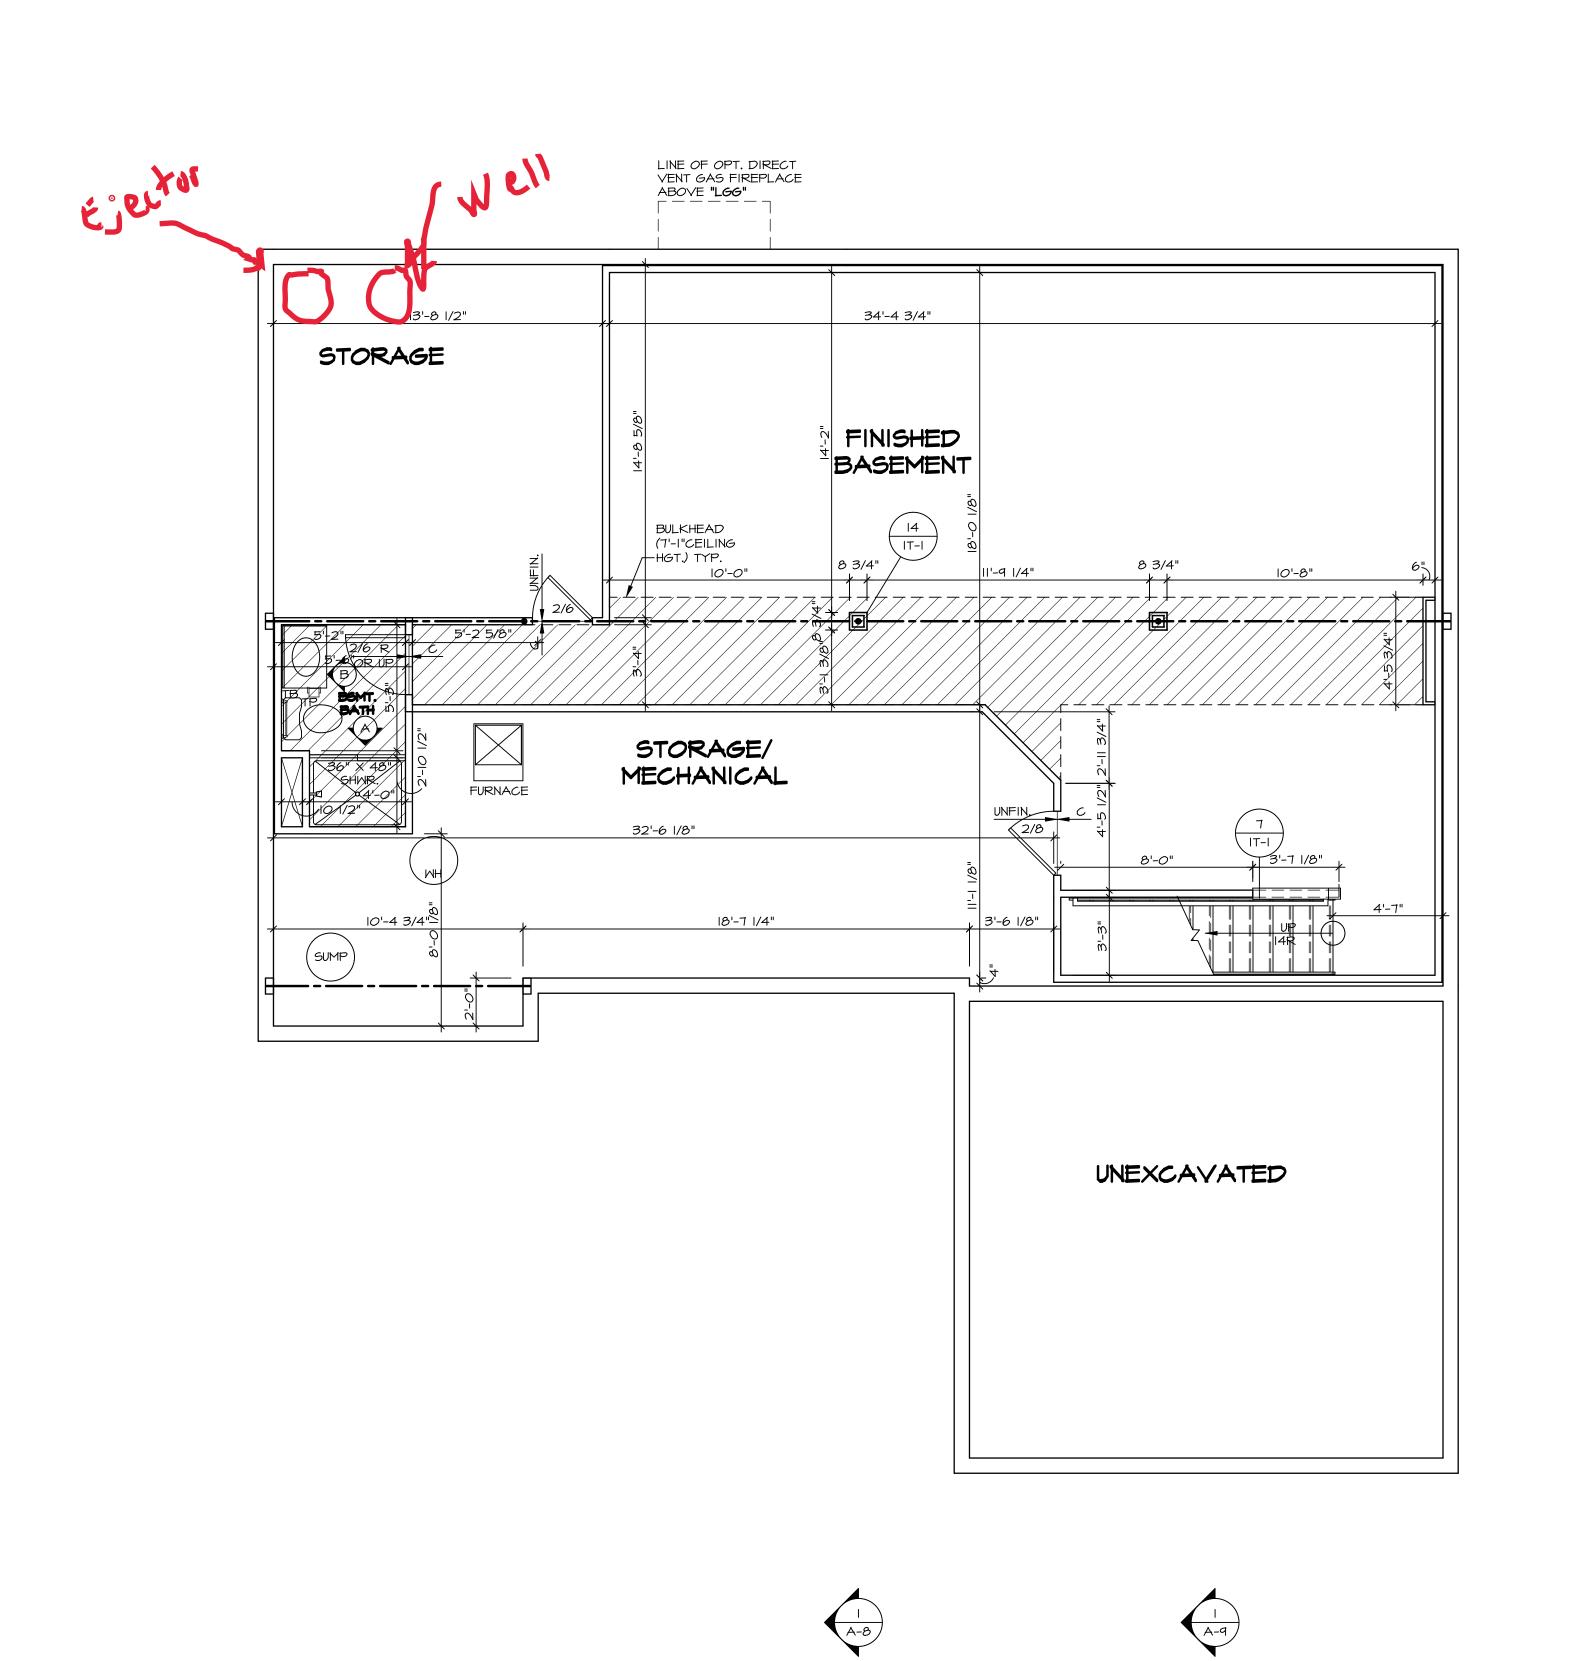

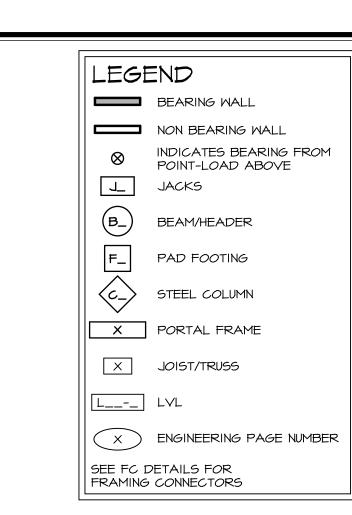

# FLOOR PLAN NOTES

 ALL HEADERS ARE (2) 2x6 w/ 2x4 WALLS OR (3) 2x6 w/ 2x6 WALLS, UNLESS OTHERWISE NOTED.
 ALL HEADERS TO HAVE (I) 2x4 OR 2x6 JACK EACH END, UNLESS OTHERWISE NOTED.

3. ALL EXTERIOR WALLS TO BE 4" AND ALL INTERIOR WALLS TO BE 3 I/2", UNLESS OTHERWISE NOTED
4. HATCHED AREAS INDICATE DROPPED CEILINGS. ALL DROPPED CEILINGS ARE I2" UNLESS OTHERWISE NOTED.
5. SEE "BRACED WALL PANEL DETAIL SHEET" FOR SPECIAL WALL FRAMING LOCATIONS AND HEADER SIZES, IF

APPLICABLE.

APPLICABLE.
6. SEE STANDARD DETAIL CATEGORY "IT" SHEET(S) FOR INTERIOR TRIM DETAILS.
7. SEE ARCHITECTURAL DETAIL SHEET "AD" FOR HOUSE SPECIFIC INTERIOR TRIM OPTION TABLE.
8. ALL WINDOWS HAVE 7'-O 1/2" HEADER HEIGHT UNLESS OTHERWISE NOTED.

## GYPSUM NOTES


AT GARAGE:


GYPSUM BOARD AT COMMON WALLS, CEILINGS, BEAM WRAPS AND SUPPORTS PER STANDARD DETAIL FA-I(b) FIRE ASSEMBLIES OR AS REQUIRED BY LOCAL CODE.

AT STAIRS:

1/2" GYPSUM BOARD AT UNDERSIDE OF STAIRS AND WALLS IN CLOSET

BASEMENT FLOOR PLAN A-6 SCALE: 1/4" = 1'-0"

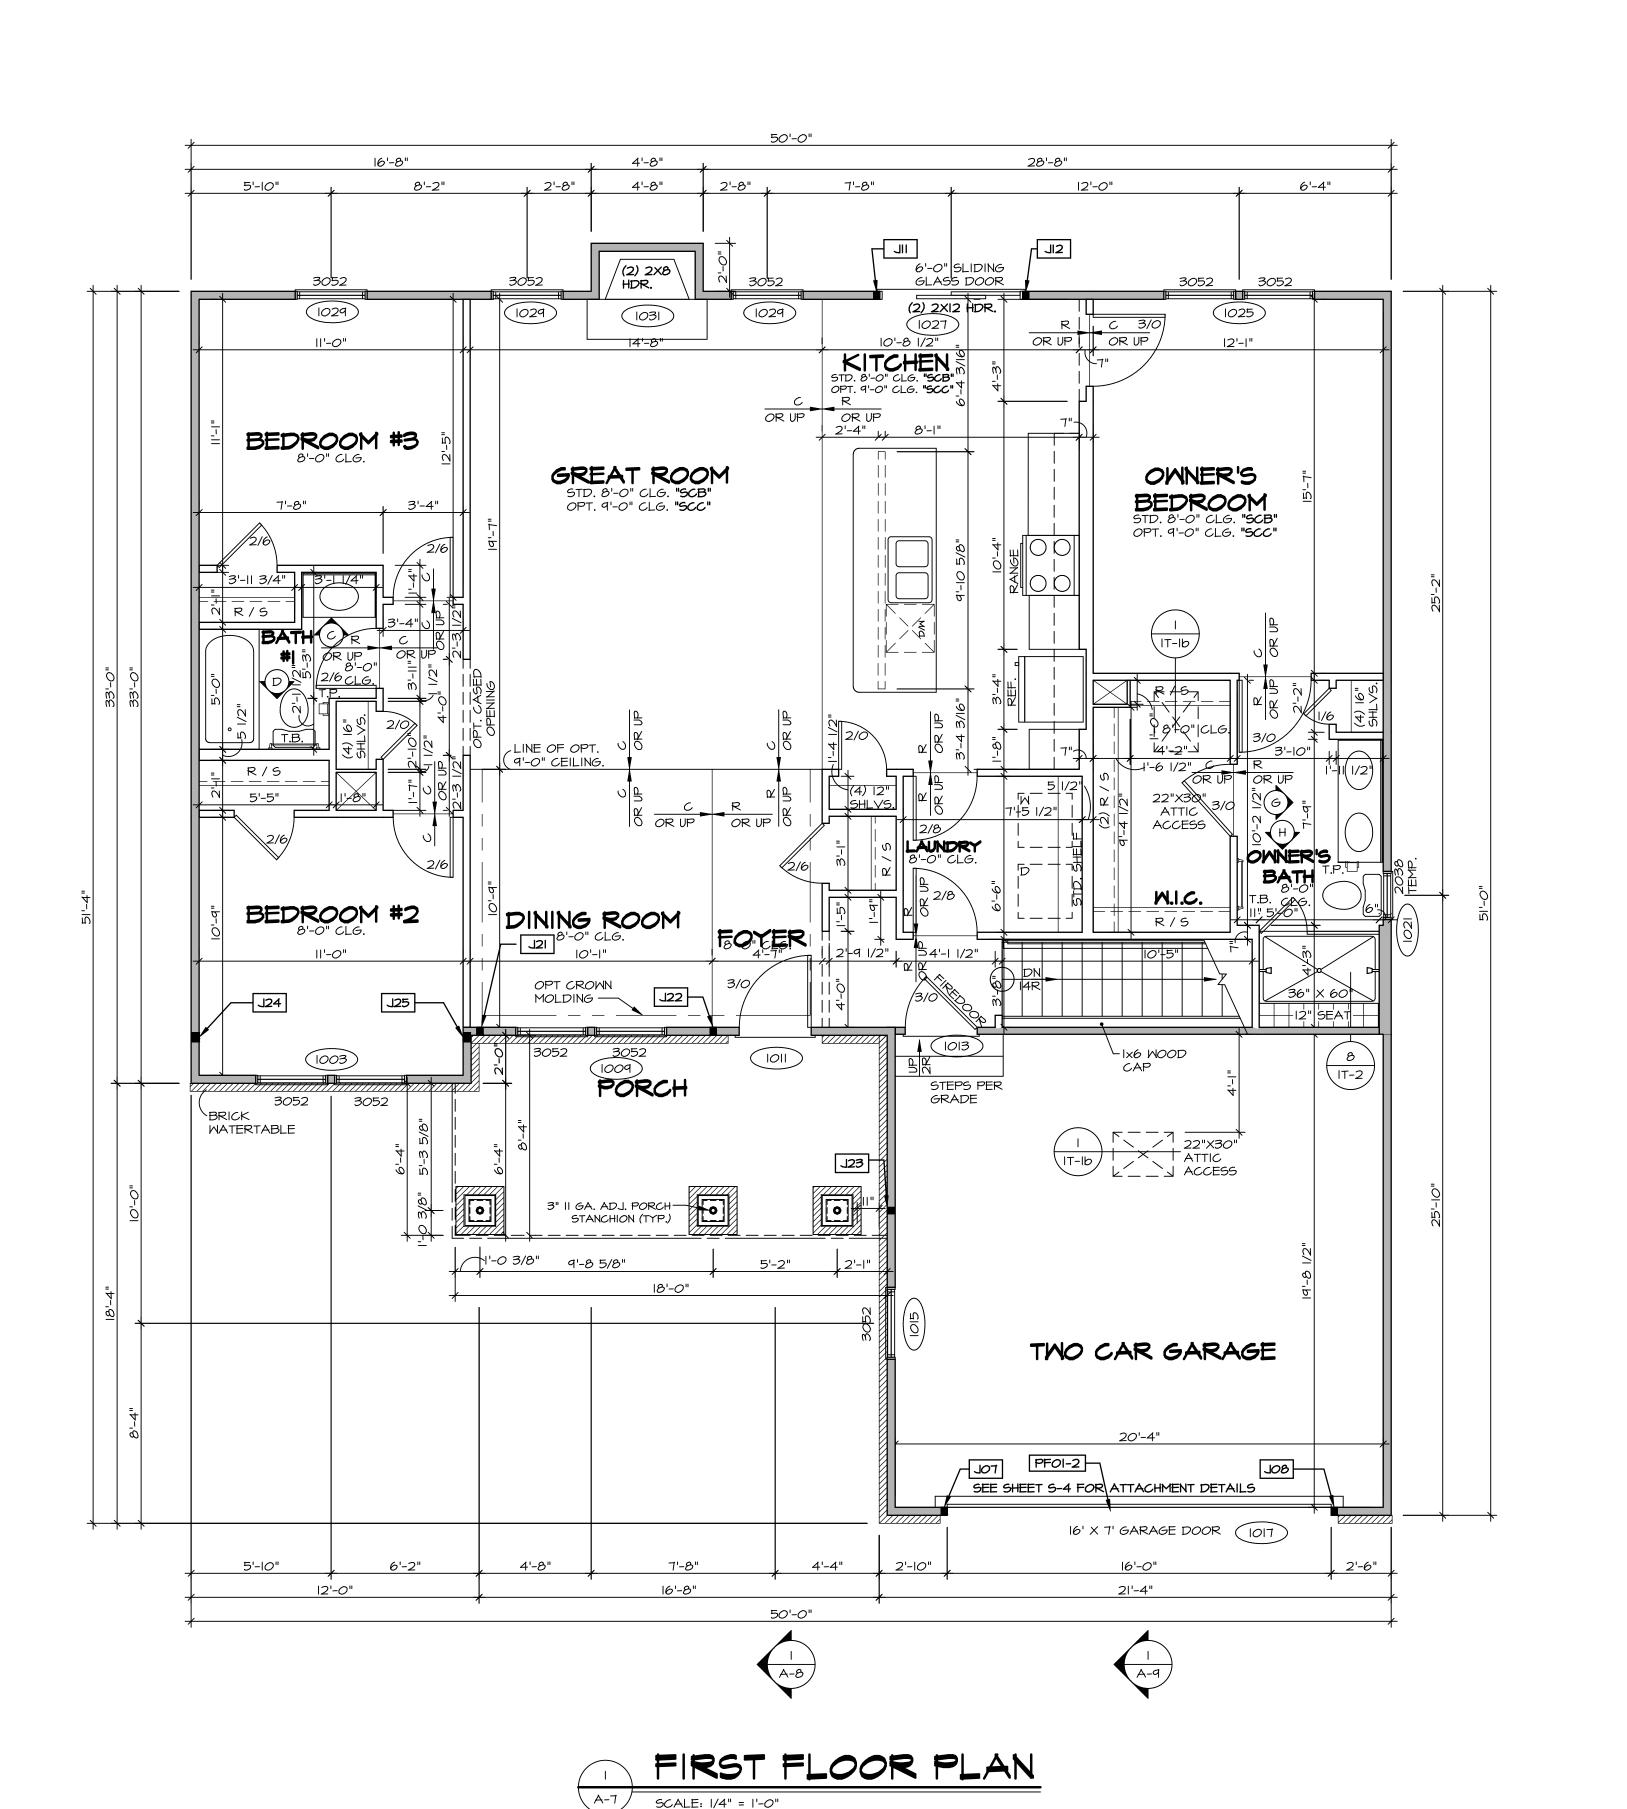

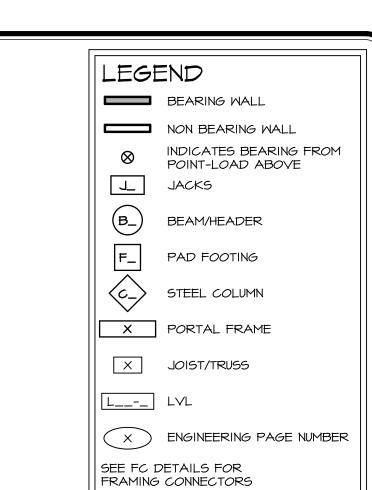

## FLOOR PLAN NOTES

ALL HEADERS ARE (2) 2x6 w/ 2x4 WALLS OR (3) 2x6 w/ 2x6 MALLS, UNLESS OTHERWISE NOTED. ALL HEADERS TO HAVE (1) 2x4 OR 2x6 JACK AND KING STUD EACH END, UNLESS OTHERWISE NOTED. ALL EXTERIOR WALLS TO BE 4" W/ OSB OR 3 1/2" W/ T-PLY, ALL INTERIOR WALLS TO BE 3 1/2", UNLESS

OTHERWISE NOTED. HATCHED AREAS INDICATE DROPPED CEILINGS. ALL DROPPED CEILINGS ARE 12" UNLESS OTHERWISE NOTED. SEE "BRACED WALL PANEL DETAIL SHEET" FOR SPECIAL WALL FRAMING LOCATIONS AND HEADER SIZES, IF

APPLICABLE. SEE STANDARD DETAIL CATEGORY "IT" SHEET(S) FOR INTERIOR TRIM DETAILS. SEE ARCHITECTURAL DETAIL SHEET "AD" FOR HOUSE

SPECIFIC INTERIOR TRIM OPTION TABLE. 8. ALL MINDOWS HAVE 7'-0 1/2" HEADER HEIGHT UNLESS OTHERWISE NOTED. ALL HEADERS IN NON-BEARING WALLS SHALL BE A SINGLE FLAT 2X4 OR 2X6 ATTACHED TO CRIPPLES

ABOVE, UNLESS OTHERWISE NOTED.

### GYPSUM NOTES

AT GARAGE:

GYPSUM BOARD AT COMMON WALLS, CEILINGS, BEAM WRAPS AND SUPPORTS PER STANDARD DETAIL FA-I(b) FIRE ASSEMBLIES OR AS REQUIRED BY LOCAL CODE.

AT STAIRS:

1/2" GYPSUM BOARD AT UNDERSIDE OF STAIRS AND WALLS IN CLOSET

### LVL PLY TO PLY FASTENING SCHEDULE:


- I.A (2) PLY UP TO AND INCLUDING II 7/8" TALL: FASTEN PLIES W/ (2) ROWS I6D NAILS AT I2" O.C. 2.A - (2) PLY 14" TO AND 18" TALL (INCLUSIVE): FASTEN PLIES W (3) ROWS 16D NAILS AT 12" O.C. 3.A - (2) PLY 20" TALL AND OVER: FASTEN PLIES W/ (4) ROWS 16D NAILS AT 12" O.C.
- 4.A (3) PLY UP TO AND INCLUDING II 7/8" TALL: FASTEN PLIES W/ (2) ROWS 16D NAILS AT 12" O.C. FROM EACH SIDE
- 5.A (3) PLY 14" TO AND 18" TALL (INCLUSIVE): FASTEN PLIES W/ (3) ROWS 16D NAILS AT 12" O.C. FROM EACH SIDE


6.A - (3) PLY 20" TALL AND OVER: FASTEN PLIES W/ (4) ROWS 16D NAILS AT 12" O.C. FROM EACH SIDE

FIELD INSTALLED FIRST FLOOR BEAM/HEADER SCHEDULE IDENTIFIER DESCRIPTION OPTIONS ENG. NUM. REMARKS LENGTH PFOI-2 EXT HEADER - 2XI2 - 2 PLY 20'-9" GCB 1017

FIRST FLOOR JACK SCHEDULE				
IDENTIFIER	DESCRIPTION	OPTIONS	ENG. NUM.	REMARKS
J07	JACK - (2) 2X4 SPF STUD GRADE	GCB	1017	
30E	JACK - (2) 2X4 SPF STUD GRADE	GCB	1017	
=	JACK - (2) 2X4 SPF STUD GRADE		1027	
<u> </u> 2	JACK - (2) 2X4 SPF STUD GRADE		1027	
J21	JACK - (2) 2X4 SPF STUD GRADE	ELL	1033	
J22	JACK - (2) 2X4 SPF STUD GRADE	ELL	1033	
J23	JACK - (2) 2X4 SPF STUD GRADE	ELL	1033	
J24	JACK - (3) 2X4 SPF STUD GRADE		1036	
J25	JACK - (3) 2X4 SPF STUD GRADE		1036	


© NVR, In The own copyright in these to be copied i whatsoeve assigned first obta

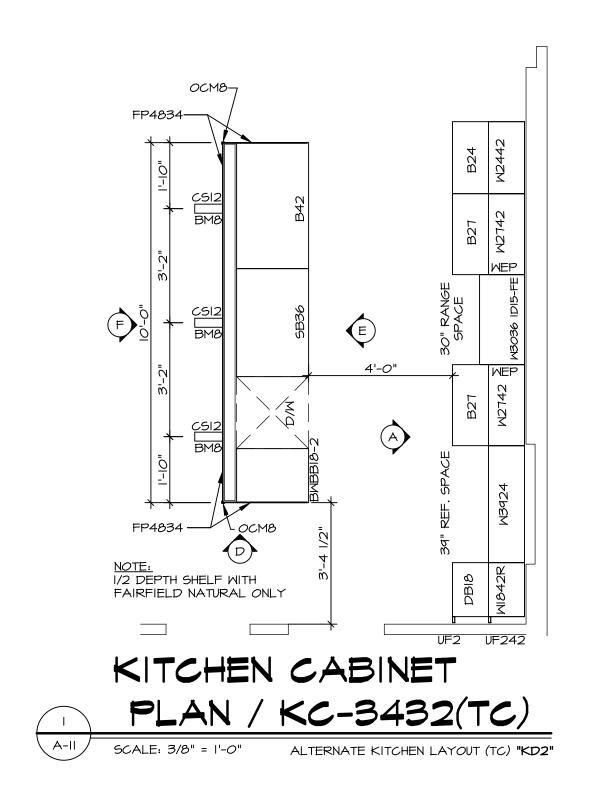

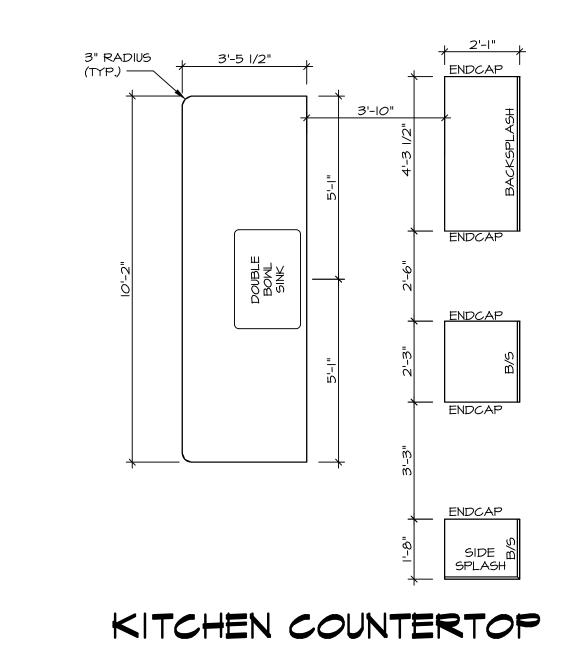



PLAN / KC-3432(TC)

ALTERNATE KITCHEN LAYOUT (TC) "KD2"

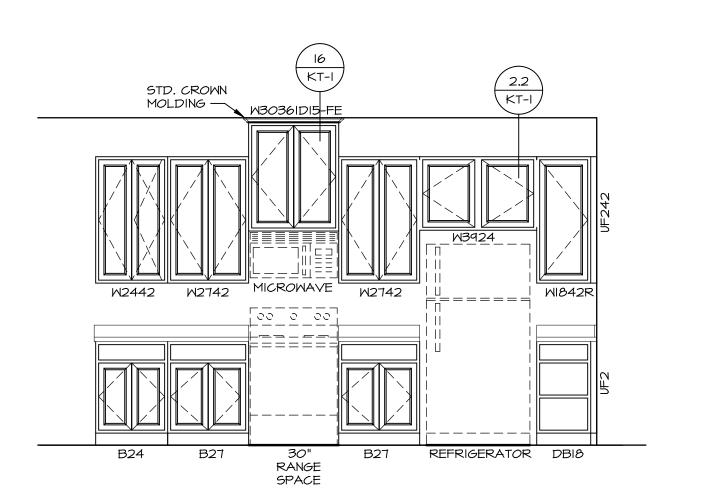


SCALE: 3/8" = 1'-0"

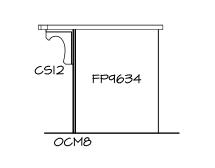

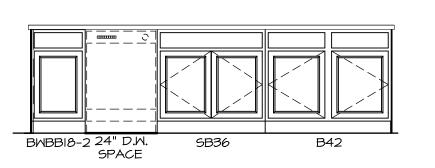

SCALE: 3/8" = 1'-0"

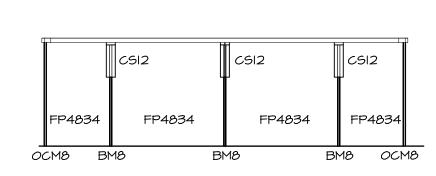









NOTE

I. CABINET LAYOUT (S) ARE BASED ON FINISHED DIMENSIONS TO DRYWALL.

2. IF KITCHEN PLANS/ELEVATIONS CALL-OUT STANDARD MOLDING, REFER TO STANDARD DETAIL (II/KT-I) FOR REPLACEMENT BASED

DETAIL (II/KT-I) FOR REPLACEMENT BASED
ON CABINET STYLE.

3. ALL (UF#) FILLERS ARE TO BE "TRIM TO FIT"
UNLESS OTHERWISE NOTED.

4. CABINET MUST BE SET, SHIMMED, LEVELED

AND PLUMB W/ ADJOINING BASE CABINETS.

5. SET PRE-FINISHED SCRIBE MOLDING AT
CABINET BULKHEADS AND AT ENDS (WHERE
CABINETS MEET DRYWALL.) PRE-FINISHED
SCRIBE MOLDING SHALL BE USED TO PAD
OUT CABINET SIDES AT STILE FOR RETURN
PIECES OF THE FACE-MOUNTED CABINET
CROWN MOLDING.

CROWN MOLDING.

6. HARDWARE INSTALL NOTE: KNOBS GO ON OPERABLE DOORS AND DRAWERS FOR ALL KITCHEN AND BATH AREAS. DRAWER FRONTS AND DOORS GET (I) KNOB/PULL. NO HARDWARE ON FALSE DRAWER FRONTS.

COMM-LOT

TARA ESTATES - OOBT

STREET ADDRESS

TB77 TIMBERVIEW CT

CITY

FRANKLIN

OH

450

copyright and other property rights in these plans. These plans are not to be reproduced, changed, or copied in any form or manner whatsoever, nor are they to be assigned to any third party, without first obtaining the expressed written consent of NVR, Inc.


NVR, Inc. 5285 Westview Drive, Suite 100 Frederick, MD 21703

VERSION OI
DRAWN BY RJC
DATE: 9/11/15
OPTION

SET NO. A
VERSION C
DRAWN BY
DATE: q

XIANO TITLE
TCHEN LAYOUT


=

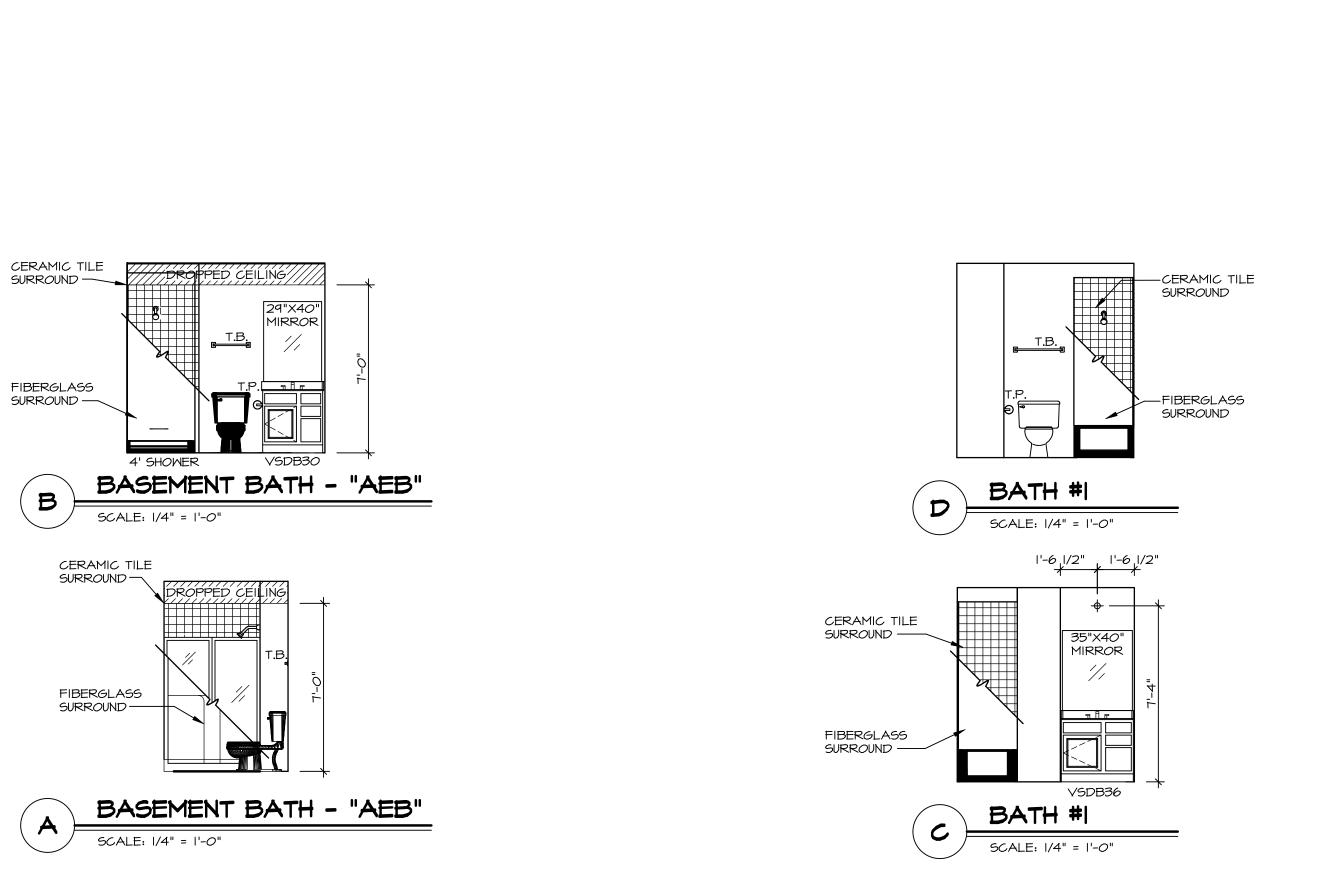


FIBERGLASS
SURROUND —

CERAMIC TILE SURROUND

FIBERGLASS SURROUND —

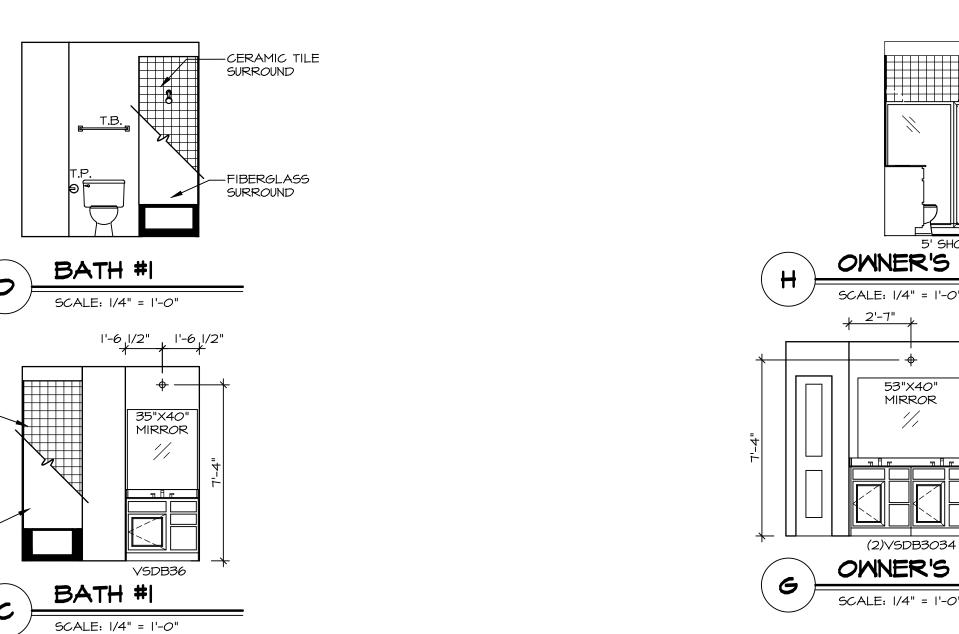

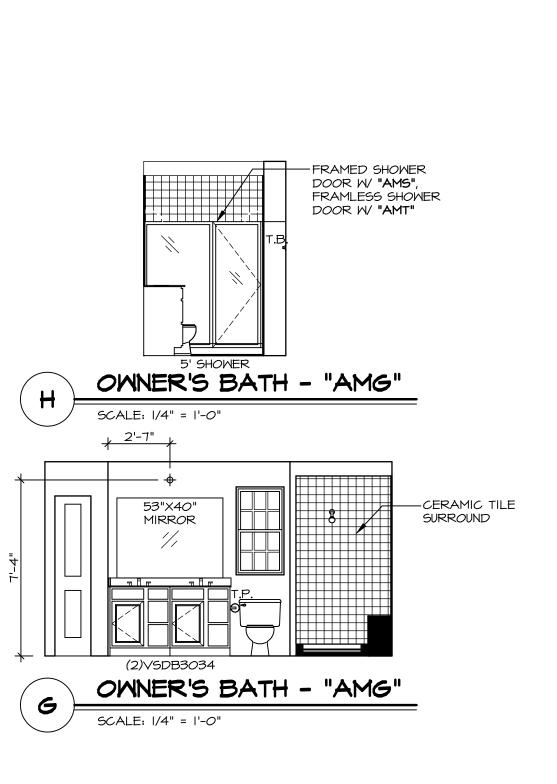

NOTES:

I. TEMPERED GLASS SHOWER
ENCLOSURE WITH SWING DOOR OR
OPTIONAL SLIDING DOOR BY DIVISION

2. TUB ACCESS PANELS PROVIDED AS
NEEDED, ALL MATERIALS BY DIVISION
3. REFER TO SHEET IT-2 FOR TUB AND
SHOWER DETAILS.
4. ALL VSDB24-42 DRAWERS TO BE SET ON
RIGHT HAND.

5. BATH ELEVATIONS ARE SHOWN PER PLAN.