
VG 774 9797 KNOLL CREEK CT CENTERVILLE, OH 45458

2 Story Basement
Vent floor drain
1 shower - 2 valves
1 tub
WATER SOFTENER ROUGH-IN - HOSE BIB RAN SEPERATELY
2 hose bibs - valves required
AA valve on kitchen sink
ice maker
WATER HEATER ELECTRIC 50 GALLON

Gas Furnace

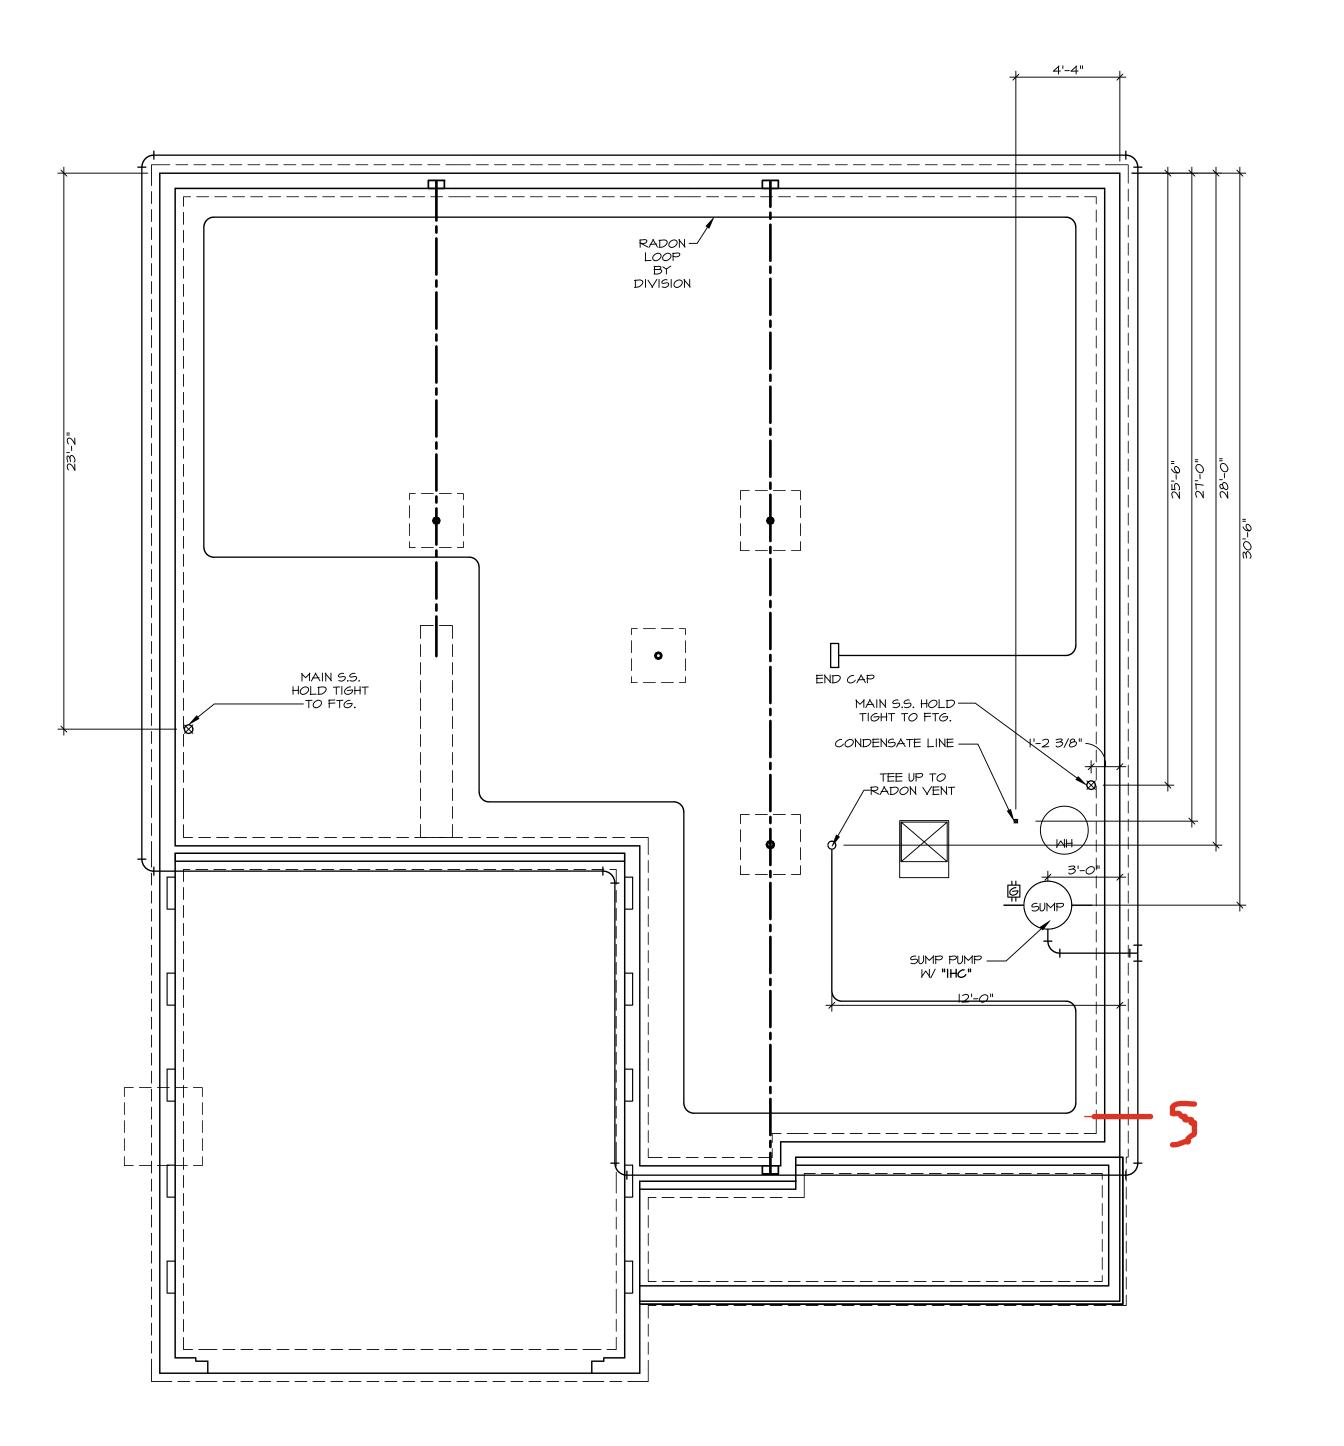



PLUMBING NOTES:

RADON REMEDIATION
RADON LOOP:

- (4") PERFORATED HDPE "LOOP"

- MUST BE PLACED IN STONE BED SLIGHTLY HIGHER THAN ANY INTERIOR DRAINTILE

- LOOP TO BE SEPARATE FROM ANY DRAINTILE ELEMENTS

- TO BE CORRUGATED HDPE PIPE

- SCREWS TO BE INSTALLED THROUGH LOOP AT TEE UP INTO STACK
STACK REQUIREMENTS:

- 3" PVC STACK (4" IF BASEMENT IS GREATER THAN 2200 SQFT.)


- NO PART OF STACK IS TO BE HORIZONTAL (45° ELBOWS PERMITTED AS REQUIRED)


- PIPE TO BE PHYSICALLY LABELED IN THE FIELD AS "RADON VENT" OR OTHER
JURISDICTIONALLY REQUIRED LANGUAGE (ON EVERY LEVEL OF HOUSE)

- ROOF TERMINATION TO BE IN TOP 1/3 OF ROOF

- SCREEN OR VENT CAP INSTALLED TO KEEP PESTS OUT OF RADON VENT AT ROOF TERMINATION.

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NVR, Inc. 5285 Westview Drive, Suite 100 Frederick, MD 21703	NVR, Inc. 5285 Westview Drive, Suite 100 Frederick, MD 21703	iserves its erty rights ns are not	inged, or r manner ey to be tv without	sed written		
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## FLOOR PLAN NOTES:

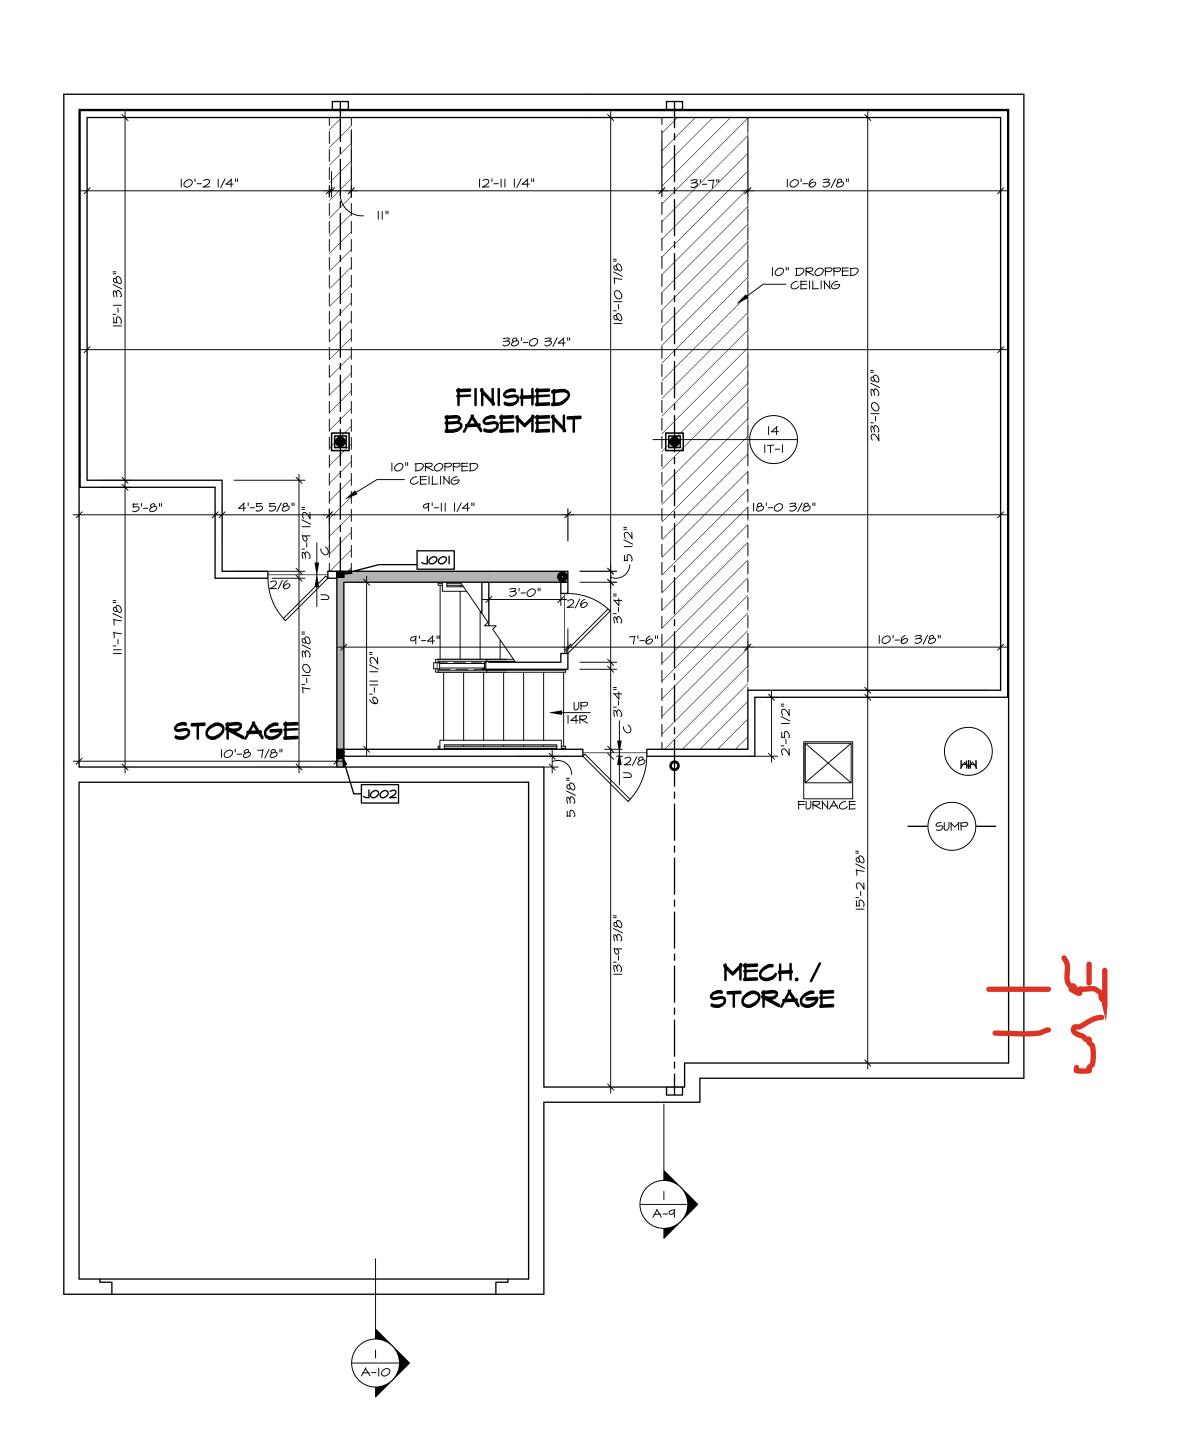- ALL HEADERS ARE (2) 2x6 w/ 2x4 WALLS OR (3) 2x6 w/ 2x6 WALLS, UNLESS OTHERWISE NOTED.
   ALL HEADERS TO HAVE (I) 2x4 OR 2x6 JACK AND KING STUD EACH END, UNLESS OTHERWISE NOTED.
   MULTI-OPENING HEADERS TO HAVE (2) JACKS AT INTERMEDIATE BEARING, UNLESS OTHERWISE NOTED. NO ADDITIONAL FLOOR SYSTEM BLOCKING OR CONTINUOUS LOAD PATH JACKS ARE REQUIRED UNLESS OTHERWISE NOTED.
- 3. ALL EXTERIOR WALLS TO BE 4" OR 6" AND ALL INTERIOR WALLS TO BE 3 I/2", UNLESS OTHERWISE NOTED.
  4. HATCHED AREAS INDICATE DROPPED CEILINGS. ALL DROPPED CEILINGS ARE I2" UNLESS OTHERWISE NOTED. SEE ARCHITECTURAL DETAIL 8/IT-IB FOR 3/4" FIRE
- STOPPING AT BULKHEAD / CEILING PANELS
  5. SEE "BRACED WALL PANEL DETAIL SHEET" FOR SPECIAL WALL FRAMING LOCATIONS AND HEADER SIZES, IF APPLICABLE.
- 6. SEE STANDARD DETAIL CATEGORY "IT" SHEET(S) FOR INTERIOR TRIM DETAILS.
- SEE DETAIL SHEET "AD" FOR HOUSE SPECIFIC INTERIOR
  TRIM OPTION TABLE.
   ALL HEADERS IN NON-BEARING WALLS SHALL BE A
- 8. ALL HEADERS IN NON-BEARING WALLS SHALL BE A SINGLE FLAT 2X4 OR 2X6 ATTACHED TO CRIPPLES ABOVE, UNLESS OTHERWISE NOTED.

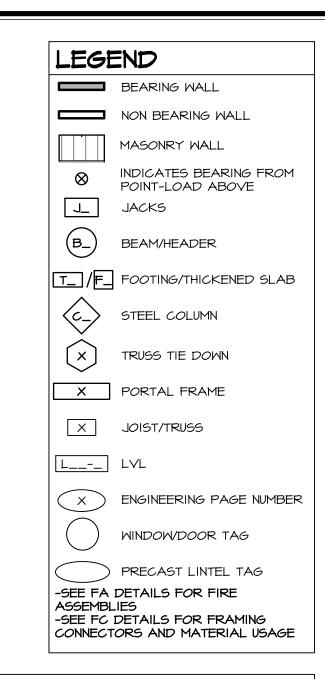  9. TANKED WATER HEATER SHOWN AS BASE CONDITION,
- OPTIONAL TANKLESS WATER HEATER IS AVAILABLE IN LIEU OF TANKED WATER HEATER.

  IO. INTERIOR HEADER HEIGHT FOR 8' CEILING WILL BE 6'-II",
- 9' CEILING WILL BE 7'-II", IO' CEILING WILL BE 8'-3", UNLESS OTHERWISE NOTED.

  II. BASEMENT FINISH DIMENSIONS ASSUME A I/2" GAP BETWEEN FRAME WALL AND CONCRETE WALL.

  I2. ALL INTERIOR BEARING WALLS SHALL HAVE GYPSUM
- 12. ALL INTERIOR BEARING WALLS SHALL HAVE GYPSUM APPLIED TO AT LEAST ONE SIDE OR HAVE MID-HEIGHT BLOCKING INSTALLED.
- BLOCKING INSTALLED.

  13. NON-BEARING WALLS OVER CONCRETE TO BE HELD 1/2"

  SHORT OF FRAMING ABOVE.

## GYPSUM NOTES:

AT GARAGE:

GYPSUM BOARD AT COMMON WALLS, CEILINGS, BEAM WRAPS AND SUPPORTS PER STANDARD DETAIL FA-I(b) FIRE ASSEMBLIES OR AS REQUIRED BY LOCAL CODE.

AT STAIRS:

1/2" GYPSUM BOARD AT UNDERSIDE OF STAIRS AND WALLS IN CLOSET

	BASEMENT JA	CK SCHEDU	LE	
DENTIFIER	DESCRIPTION	OPTIONS	ENG. NUM.	REMARKS
100L	JACK - (2) 2X4 SPF STUD GRADE		B0009, B0015	
J002	JACK - (3) 2X4 SPF STUD GRADE		B0007	

BASEMENT FLOOR PLAN

SCALE: 1/4" = 1'-0"


DRAWING TITLE

BASEMENT FLOOR PLAN

OPTION DESCRIPTION

Solves\ LEHIGH LGHOD 01\\ DCY-VG-0774\\ 3330588\ Sheets\ Lot\ Sheets\ Sheets\ Lot\ Sheets\ Sh

	FIRST FLOOR JACK S	CHEDULE	
IDENTIFIER	DESCRIPTION	OPTIONS	ENG. NUM.
JIOO	JACK - (5) 2X4 SP#I		2000
SOIL	JACK - (4) 2X6 SPF STUD GRADE	ELC	2000
JI06	JACK - (4) 2X6 SPF STUD GRADE		1016
TOIL	JACK - (4) 2X4 SPF STUD GRADE		1016
80IL	JACK - (2) 2X4 SPF STUD GRADE		1036
POIL	JACK - (2) 2X4 SPF STUD GRADE		1032
JII4	JACK - (2) 2X4 SPF STUD GRADE		1073
JII5	JACK - (3) 2X6 SPF STUD GRADE		1073
BIIL	JACK - (2) 2X4 SPF STUD GRADE		1026
PIIL	JACK - (5) 2X6 SP#I	SXC	1044, 1049
J120	JACK - (5) 2X6 SPF STUD GRADE	GCB, GCF	1044, 1049
JI2I	JACK - (2) 2X4 SPF STUD GRADE	GCB, GCF	1055
JI22	JACK - (2) 2X4 SPF STUD GRADE	GCB, GCF	1055

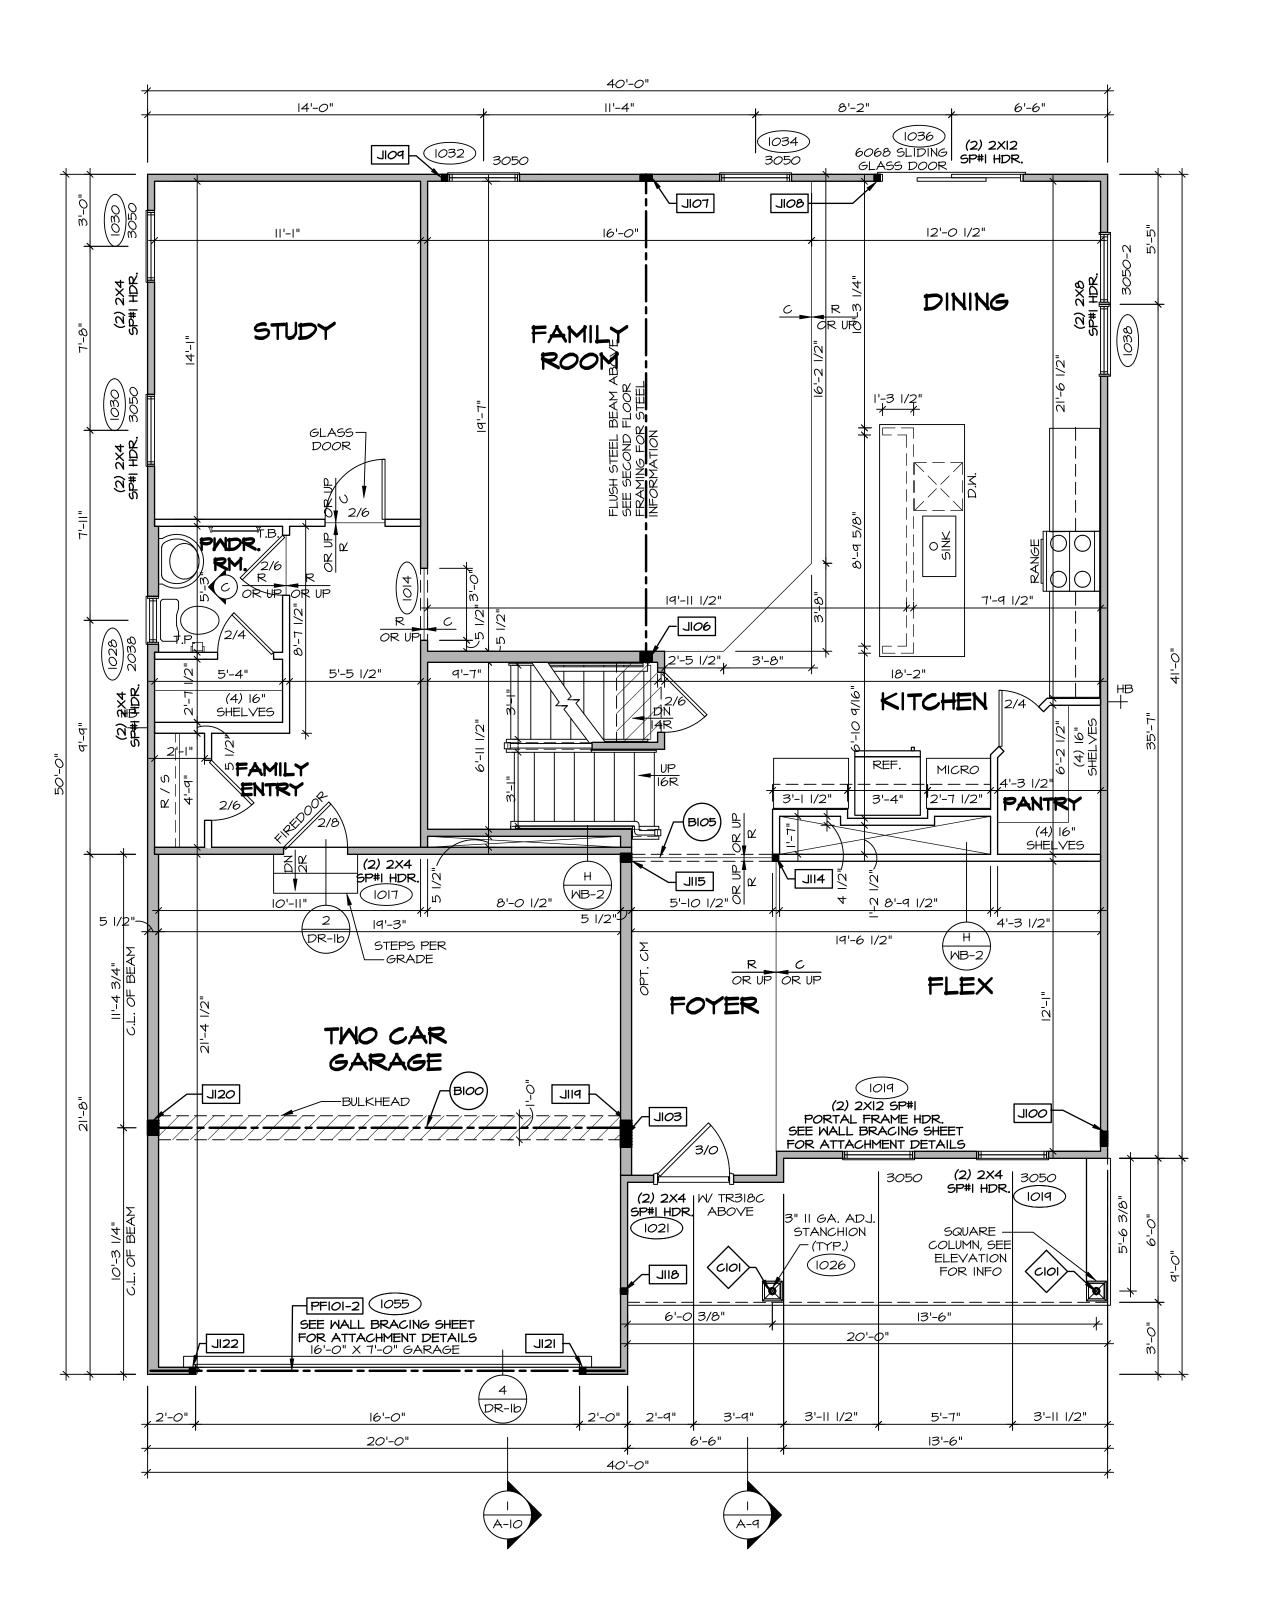



ALL WINDOWS HAVE 7'-0 1/2" HEADER HEIGHT UNLESS OTHERWISE NOTED

### FLOOR PLAN NOTES:

- ALL HEADERS ARE (2) 2x6 w/ 2x4 WALLS OR (3) 2x6 w/ 2x6 WALLS, UNLESS OTHERWISE NOTED. ALL HEADERS TO HAVE (1) 2x4 OR 2x6 JACK AND KING STUD EACH END, UNLESS OTHERWISE NOTED. MULTI-OPENING HEADERS TO HAVE (2) JACKS AT INTERMEDIATE BEARING, UNLESS OTHERWISE NOTED. NO ADDITIONAL FLOOR SYSTEM BLOCKING OR CONTINUOUS LOAD PATH JACKS ARE REQUIRED UNLESS OTHERWISE NOTED.
- ALL EXTERIOR WALLS TO BE 4" OR 6" AND ALL INTERIOR WALLS TO BE 3 I/2", UNLESS OTHERWISE NOTED. HATCHED AREAS INDICATE DROPPED CEILINGS. ALL DROPPED CEILINGS ARE 12" UNLESS OTHERWISE NOTED. SEE ARCHITECTURAL DETAIL 8/IT-IB FOR 3/4" FIRE STOPPING AT BULKHEAD / CEILING PANELS
- SEE "BRACED WALL PANEL DETAIL SHEET" FOR SPECIAL WALL FRAMING LOCATIONS AND HEADER SIZES, IF
- APPLICABLE. SEE STANDARD DETAIL CATEGORY "IT" SHEET(S) FOR INTERIOR TRIM DETAILS. SEE DETAIL SHEET "AD" FOR HOUSE SPECIFIC INTERIOR
- TRIM OPTION TABLE. ALL HEADERS IN NON-BEARING WALLS SHALL BE A SINGLE FLAT 2X4 OR 2X6 ATTACHED TO CRIPPLES ABOVE, UNLESS OTHERWISE NOTED. TANKED WATER HEATER SHOWN AS BASE CONDITION,
- OPTIONAL TANKLESS WATER HEATER IS AVAILABLE IN LIEU OF TANKED WATER HEATER. . INTERIOR HEADER HEIGHT FOR 8' CEILING WILL BE 6'-II", 9' CEILING WILL BE 7'-II", IO' CEILING WILL BE 8'-3",
- UNLESS OTHERWISE NOTED. BASEMENT FINISH DIMENSIONS ASSUME A 1/2" GAP
- BETWEEN FRAME WALL AND CONCRETE WALL. ALL INTERIOR BEARING WALLS SHALL HAVE GYPSUM
- APPLIED TO AT LEAST ONE SIDE OR HAVE MID-HEIGHT BLOCKING INSTALLED. 3. NON-BEARING WALLS OVER CONCRETE TO BE HELD 1/2" SHORT OF FRAMING ABOVE.

	LEGE	D
•		BEARING WALL
		NON BEARING WALL
		MASONRY WALL
	$\otimes$	INDICATES BEARING FROM POINT-LOAD ABOVE
).	<u></u>	JACKS
•	B_	BEAM/HEADER
-	T_ /F_	FOOTING/THICKENED SLAB
	⟨c_>	STEEL COLUMN
	×	TRUSS TIE DOWN
	X	PORTAL FRAME
	X	JOIST/TRUSS


# GYPSUM NOTES:

AT GARAGE:

GYPSUM BOARD AT COMMON WALLS, CEILINGS, BEAM WRAPS AND SUPPORTS PER STANDARD DETAIL FA-I(b) FIRE ASSEMBLIES OR AS REQUIRED BY LOCAL CODE.

AT STAIRS:

1/2" GYPSUM BOARD AT UNDERSIDE OF STAIRS AND WALLS

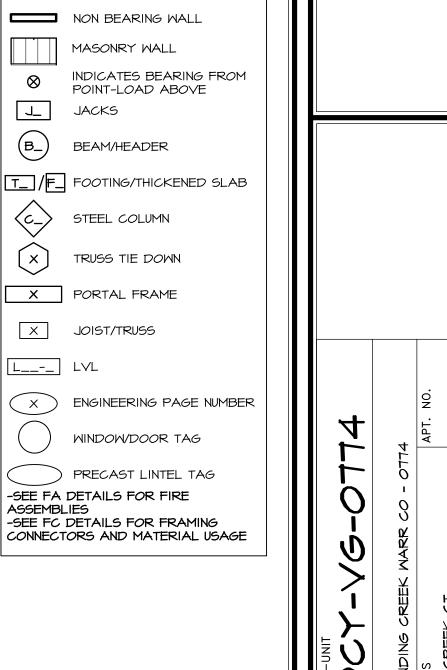


## LVL PLY TO PLY FASTENING SCHEDULE: (WHERE APPLICABLE BASED ON LVL USAGE)

- I.A (2) PLY UP TO AND INCLUDING II 7/8" TALL: FASTEN PLIES W/ (2) ROWS 16D NAILS AT 12" O.C. OR ALT I 1/2" WIDE LVL FASTEN PLIES W/ (3) ROWS 12D NAILS AT 12"O.C.
- 2.A (2) PLY 14" UP TO AND INCLUDING 18": FASTEN PLIES W/ (3) ROWS 16D NAILS AT 12" O.C. OR ALT I I/2" WIDE LVL FASTEN PLIES W/ (4) ROWS I2D NAILS AT I2"O.C.
- 3.A (2) PLY 20" TALL AND OVER: FASTEN PLIES W/ (4) ROWS 16D NAILS AT 12" O.C. OR ALT 1 1/2" WIDE LVL FASTEN PLIES W/ (5) ROWS 12D NAILS AT 12"O.C.
- 4.A (3) PLY UP TO AND INCLUDING II 7/8" TALL: FASTEN PLIES W/ (2) ROWS 16D NAILS AT 12" O.C. FROM EACH SIDE OR ALT I 1/2" WIDE LVL FASTEN PLIES W/ (3) ROWS 12D NAILS AT 12"O.C. FROM EACH SIDE. 5.A - (3) PLY 14" UP TO AND INCLUDING 18": FASTEN PLIES W/ (3) ROWS 16D NAILS AT 12"O.C.
- FROM EACH SIDE OR ALT I 1/2" WIDE LVL FASTEN PLIES W/(4) ROWS 12D NAILS AT 12"O.C. FROM EACH SIDE.
  6.A - (3) PLY 20" TALL AND OVER: FASTEN PLIES W/ (4) ROWS 16D NAILS AT 12" O.C. FROM EACH SIDE
- OR ALT I 1/2" WIDE LYL FASTEN PLIES W/ (5) ROWS 12D NAILS AT 12"O.C. FROM EACH SIDE.

  7.A (4) PLY (ALL SIZES); FASTEN PLIES WITH (3) ROWS OF SDW22634 STRUCTURAL WOOD SCREWS, OR EQUIVALENT, AT 16" O.C. STAGGERED. SEE SHOP DRAWING FOR ADDITIONAL INFORMATION.

F	IELD INSTALLED FIRS	T FLOOR	BEAM/HEAD	DER SCH	EDULE
IDENTIFIER	DESCRIPTION	LENGTH	OPTIONS	ENG. NUM.	REMARKS
BI00	BEAM STEEL - WI2X35	20'-1 1/2"	SXC	1044, 1049	
BI <i>0</i> 5	INT HEADER - 2X8 - 2 PLY	6'-7"		1073	
PFIOI-2	LVL 1.75 - 11-04	19'-9"	GCB, GCF	1055	2-PLY, I.A, PORTAL FRAME

	STEEL	_ COLUMN	SCHEDULE		
IDENTIFIER	STYLE	HEIGHT	OPTIONS	ENG. NUM.	REMARKS
CIOI	STANCHION PORCH - 3 IN DIA IIGA ADJ	8'-8 5/8"		1026	

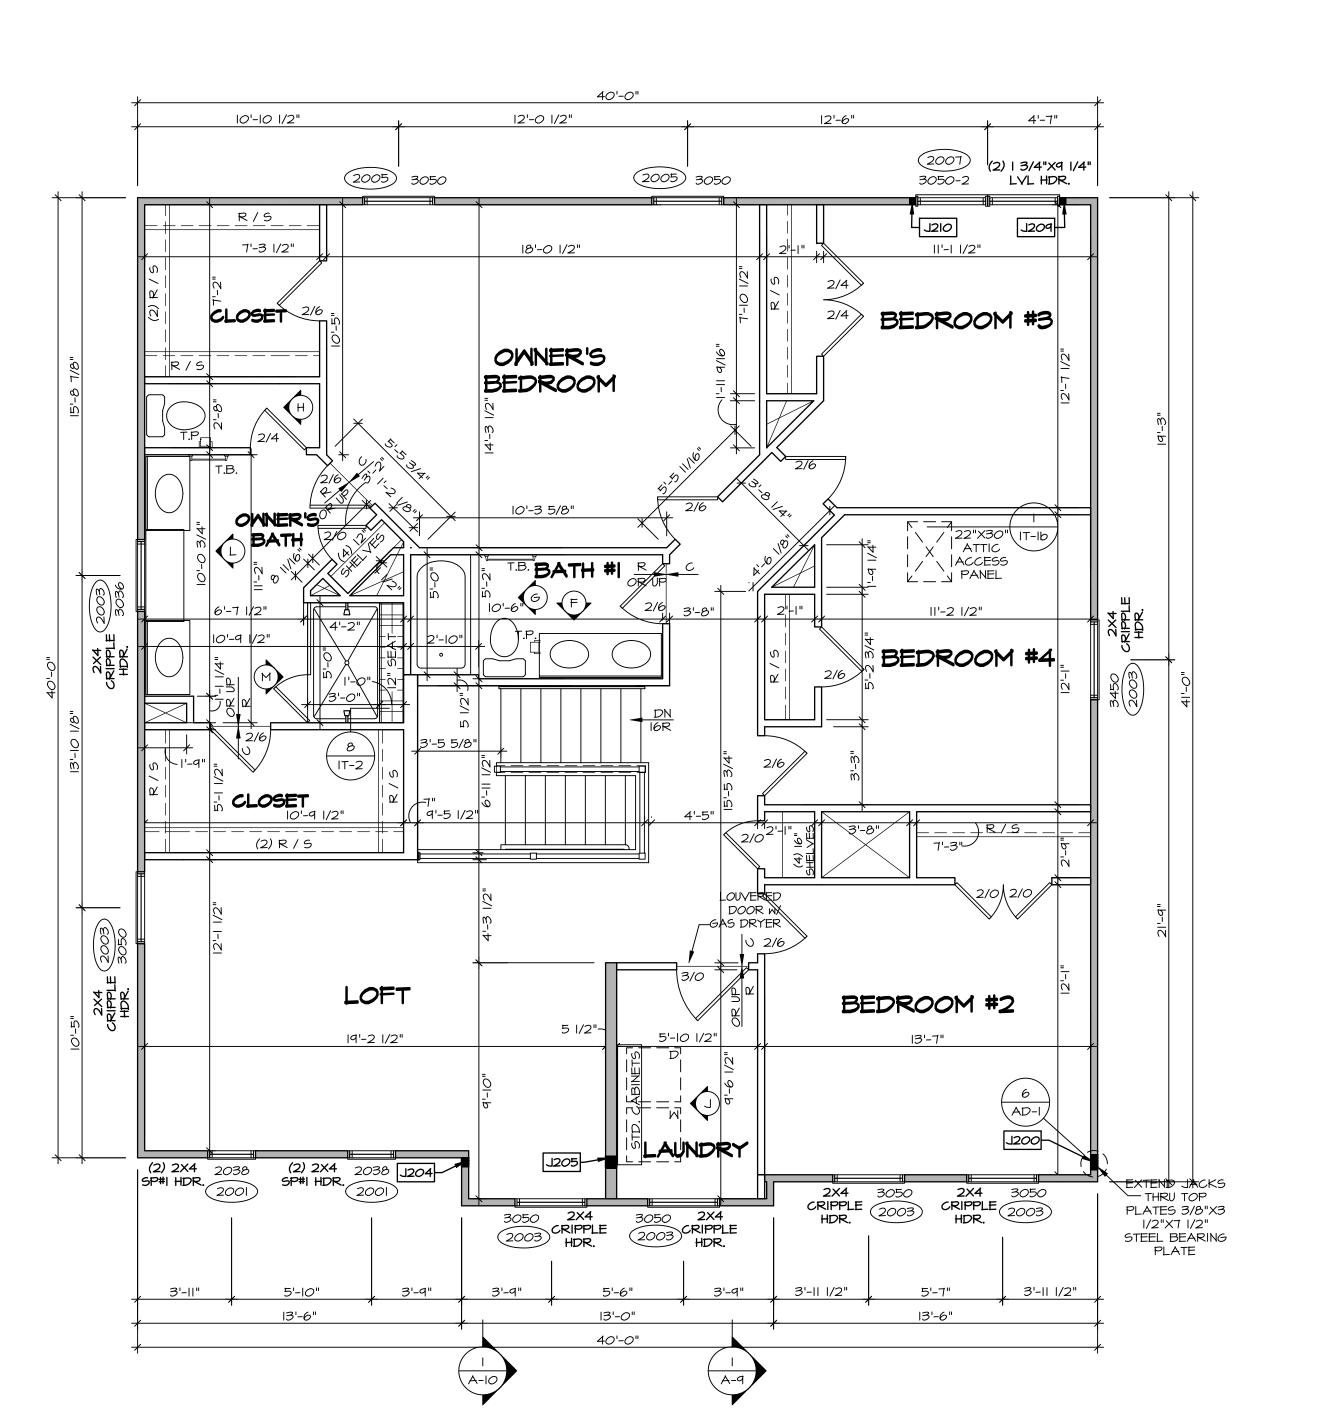

SCALE: 1/4" = 1'-0"

SECOND FLOOR PLAN

ALL WINDOWS HAVE 7'-0 1/2" HEADER HEIGHT UNLESS OTHERWISE NOTED

### FLOOR PLAN NOTES:

ALL HEADERS ARE (2) 2x6 w/ 2x4 WALLS OR (3) 2x 2x6 WALLS, UNLESS OTHERWISE NOTED.
ALL HEADERS TO HAVE (1) 2x4 OR 2x6 JACK AND k STUD EACH END, UNLESS OTHERWISE NOTED.
MULTI-OPENING HEADERS TO HAVE (2) JACKS AT INTERMEDIATE BEARING, UNLESS OTHERWISE NOTED. ADDITIONAL FLOOR SYSTEM BLOCKING OR CONTINUE LOAD PATH JACKS ARE REQUIRED UNLESS OTHERWIS

NOTED. ALL EXTERIOR WALLS TO BE 4" OR 6" AND ALL INTERIOR WALLS TO BE 3 1/2", UNLESS OTHERWISE HATCHED AREAS INDICATE DROPPED CEILINGS. AL DROPPED CEILINGS ARE 12" UNLESS OTHERWISE NOT SEE ARCHITECTURAL DETAIL 8/IT-IB FOR 3/4" FIRE STOPPING AT BULKHEAD / CEILING PANELS

SEE "BRACED WALL PANEL DETAIL SHEET" FOR SPI WALL FRAMING LOCATIONS AND HEADER SIZES, IF

APPLICABLE. SEE STANDARD DETAIL CATEGORY "IT" SHEET(S) FO INTERIOR TRIM DETAILS.

SEE DETAIL SHEET "AD" FOR HOUSE SPECIFIC INTER TRIM OPTION TABLE.

ALL HEADERS IN NON-BEARING WALLS SHALL BE A SINGLE FLAT 2X4 OR 2X6 ATTACHED TO CRIPPLES

ABOVE, UNLESS OTHERWISE NOTED.
TANKED WATER HEATER SHOWN AS BASE CONDITION OPTIONAL TANKLESS WATER HEATER IS AVAILABLE LIEU OF TANKED WATER HEATER.

D. INTERIOR HEADER HEIGHT FOR 8' CEILING WILL BE 6 9' CEILING WILL BE 7'-II", IO' CEILING WILL BE 8'-3", UNLESS OTHERWISE NOTED.

BASEMENT FINISH DIMENSIONS ASSUME A 1/2" GAP

BETWEEN FRAME WALL AND CONCRETE WALL.

2. ALL INTERIOR BEARING WALLS SHALL HAVE GYPSUM

APPLIED TO AT LEAST ONE SIDE OR HAVE MID-HEIGHT BLOCKING INSTALLED. 3. NON-BEARING WALLS OVER CONCRETE TO BE HELD 1/2" SHORT OF FRAMING ABOVE.

		_
	LEGEND	
2x6 w/	BEARING WALL	
KING	NON BEARING WALL	
D. NO	MASONRY WALL	
NUOUS WISE	NDICATES BEARING FROM POINT-LOAD ABOVE	
NOTED.	J_ JACKS	
ALL OTED. E	B_ BEAM/HEADER	
PECIAL	T_/F_ FOOTING/THICKENED SLAB	
- FOR	STEEL COLUMN	
RIOR	X TRUSS TIE DOWN	
A S	X PORTAL FRAME	
ON, LE IN	X JOIST/TRUSS	
6'-II",	L LVL	

# GYPSUM NOTES:

AT GARAGE:

GYPSUM BOARD AT COMMON WALLS, CEILINGS, BEAM WRAPS AND SUPPORTS PER STANDARD DETAIL FA-I(b) FIRE ASSEMBLIES OR AS REQUIRED BY LOCAL CODE.

AT STAIRS:

1/2" GYPSUM BOARD AT UNDERSIDE OF STAIRS AND WALLS IN CLOSET

SECOND FLOOR JACK SCHEDULE						
IDENTIFIER	DESCRIPTION	OPTIONS	ENG. NUM.	REMARKS		
J200	JACK - (5) 2X4 SP#I		2000			
J204	JACK - (3) 2X4 SPF STUD GRADE	ELC	2000			
J205	JACK - (4) 2X6 SPF STUD GRADE	ELC	2000	EXTEND THRU TOP PLATE		
J209	JACK - (2) 2X4 SPF STUD GRADE		2007			
J210	JACK - (2) 2X4 SPF STUD GRADE		2007			

LEG	END				
	BEARING	MALL			
	NON BEAF	RING WALL			
	MASONRY	MALL			
8		S BEARING FROM AD ABOVE			
J	JACKS				
B_	BEAM/HE/	ADER			
T/E	FOOTING/	THICKENED SLAB			
(c_)	STEEL CO	PLUMN			
$ $ $\otimes$	TRUSS TIE	E DOWN			
X	PORTAL	FRAME			
X	JOIST/TRI	JSS		T	T
L	LVL				
X	) ENGINEER	ING PAGE NUMBER	$\ $		ī. NO.
	MINDOM/I	DOOR TAG	7	4 1 10	APT.
		LINTEL TAG	\( \tilde{\} \)	9	
ASSEM			ΙÓ	8	
		OR FRAMING MATERIAL USAGE	٦. ا	0 <u>7</u>	
			DCY-V6	COMM-LOT VLGS OF WINDING CREEK MA	STREET ADDRESS
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SCHE	1	Г			100
rions	ENG. NUM.	REMARKS			iite 1
LC	2000				VR, Inc. w Drive, Suite
LC	2000	EXTEND THRU TO PLATE		<b>&gt;</b>	, Inc Drive
	2007				<u>~</u> ≥





- CABINET LAYOUT (S) ARE BASED ON FINISHED DIMENSIONS TO DRYWALL.


  2. IF KITCHEN PLANS/ELEVATIONS CALL-OUT STANDARD MOLDING, REFER TO STANDARD DETAIL II/KT-I FOR REPLACEMENT BASED
- ON CABINET STYLE. 3. ALL (UF#) FILLERS ARE TO BE "TRIM TO FIT" UNLESS OTHERWISE NOTED.
- 4. CABINET MUST BE SET, SHIMMED, LEVELED AND PLUMB W/ ADJOINING BASE CABINETS.
  5. SET PRE-FINISHED SCRIBE MOLDING AT CABINET BULKHEADS AND AT ENDS (WHERE CABINETS MEET DRYWALL.) PRE-FINISHED SCRIBE MOLDING SHALL BE USED TO PAD OUT CABINET SIDES AT STILE FOR RETURN PIECES OF THE FACE-MOUNTED CABINET
- CROWN MOLDING.
  6. HARDWARE INSTALL NOTE: KNOBS GO ON OPERABLE DOORS AND DRAWERS FOR ALL
  KITCHEN AND BATH AREAS. DRAWER FRONTS
  AND DOORS GET (I) KNOB/PULL. NO HARDWARE ON FALSE DRAWER FRONTS. REFER TO STANDARD DETAIL **5/KT-Ib**


CABINETS ARE NOT REPRESENTATIVE OF ALL STYLES AND ARE MEANT AS A GENERAL


DEPICTION
OF THE INTENDED CABINET LAYOUT

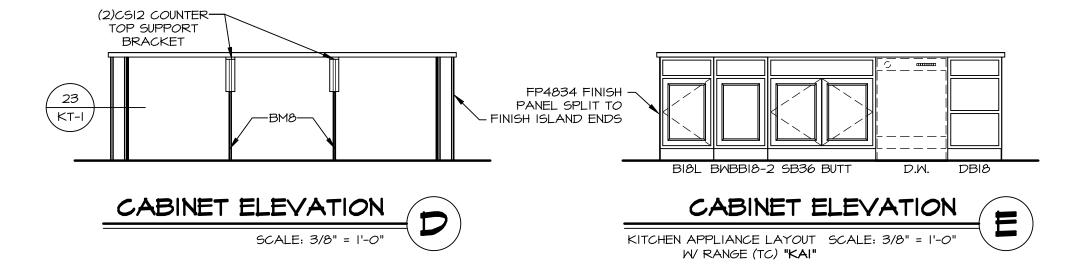


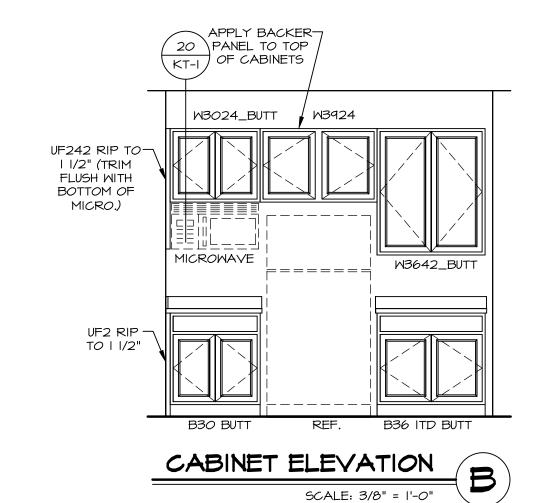


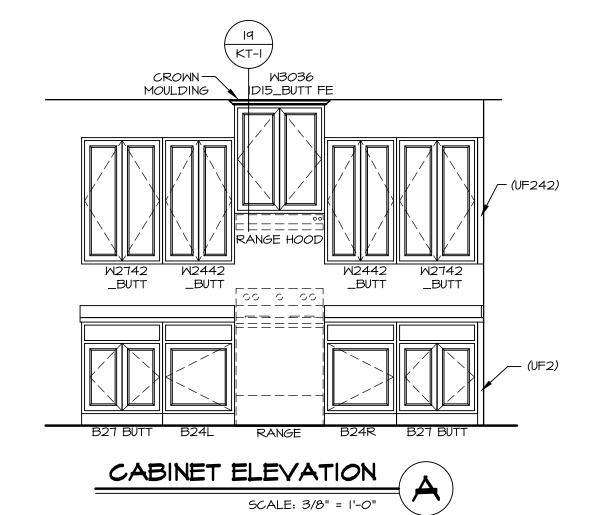


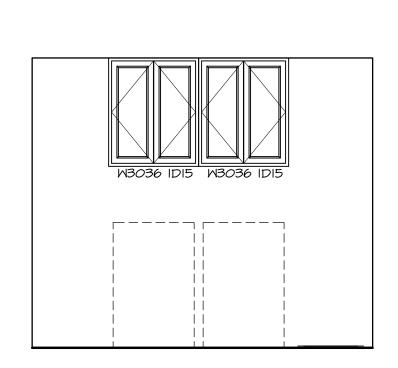

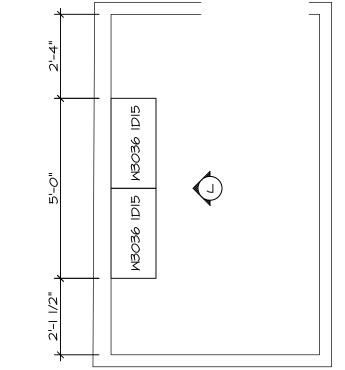

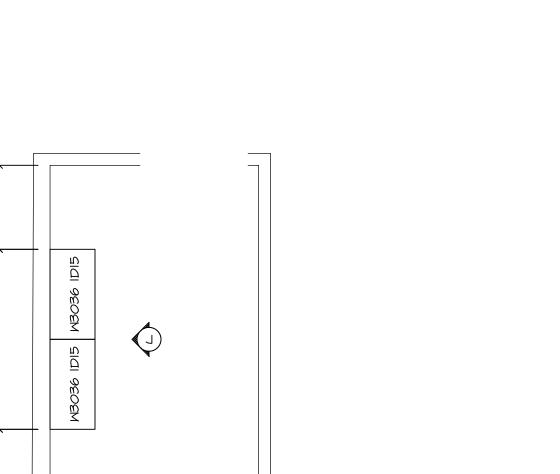

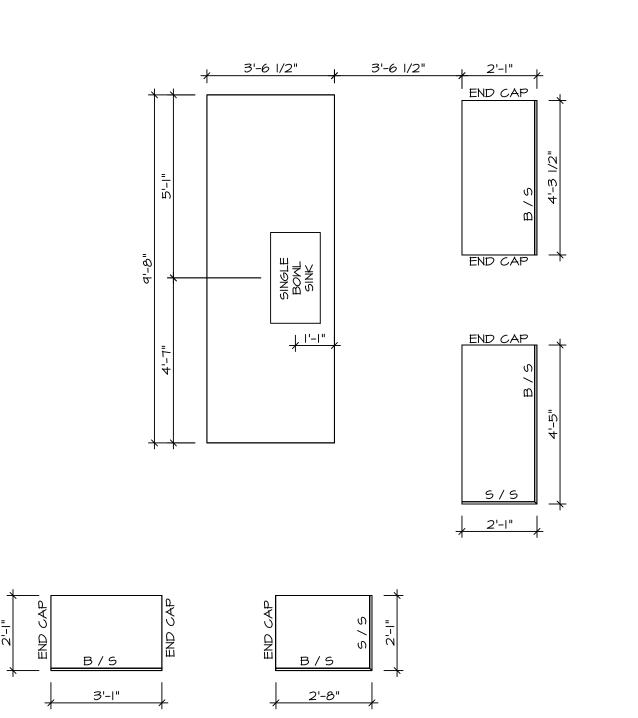

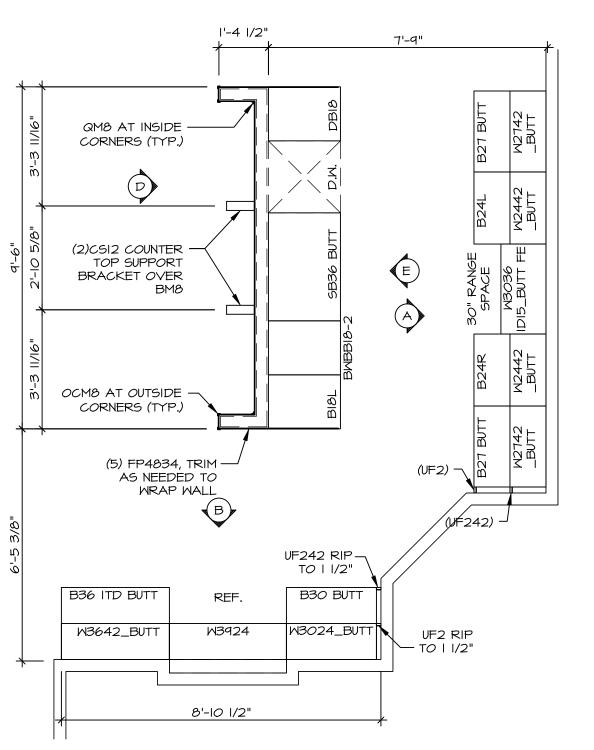














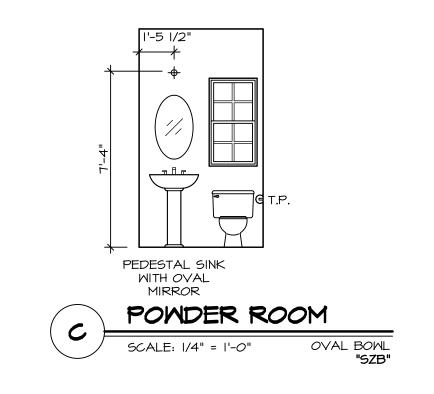


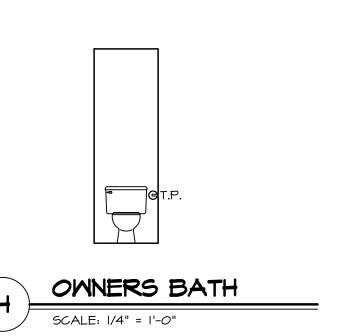


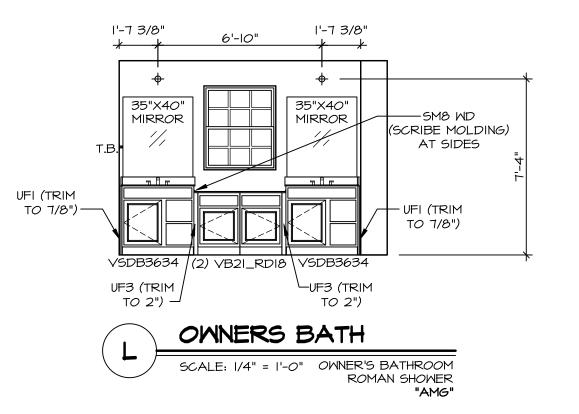

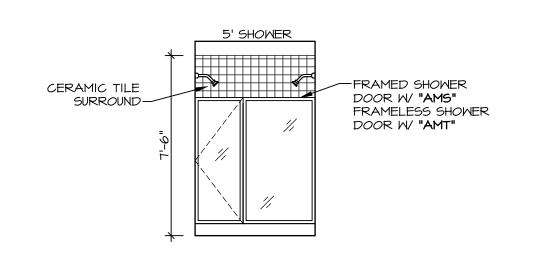

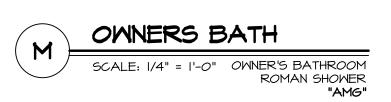

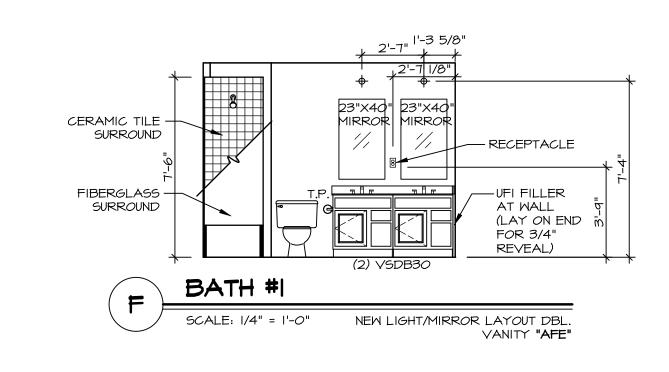

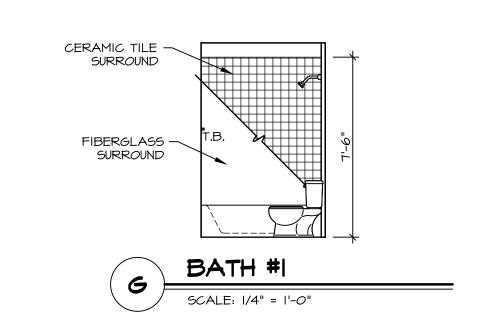

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DATE:
OPTION

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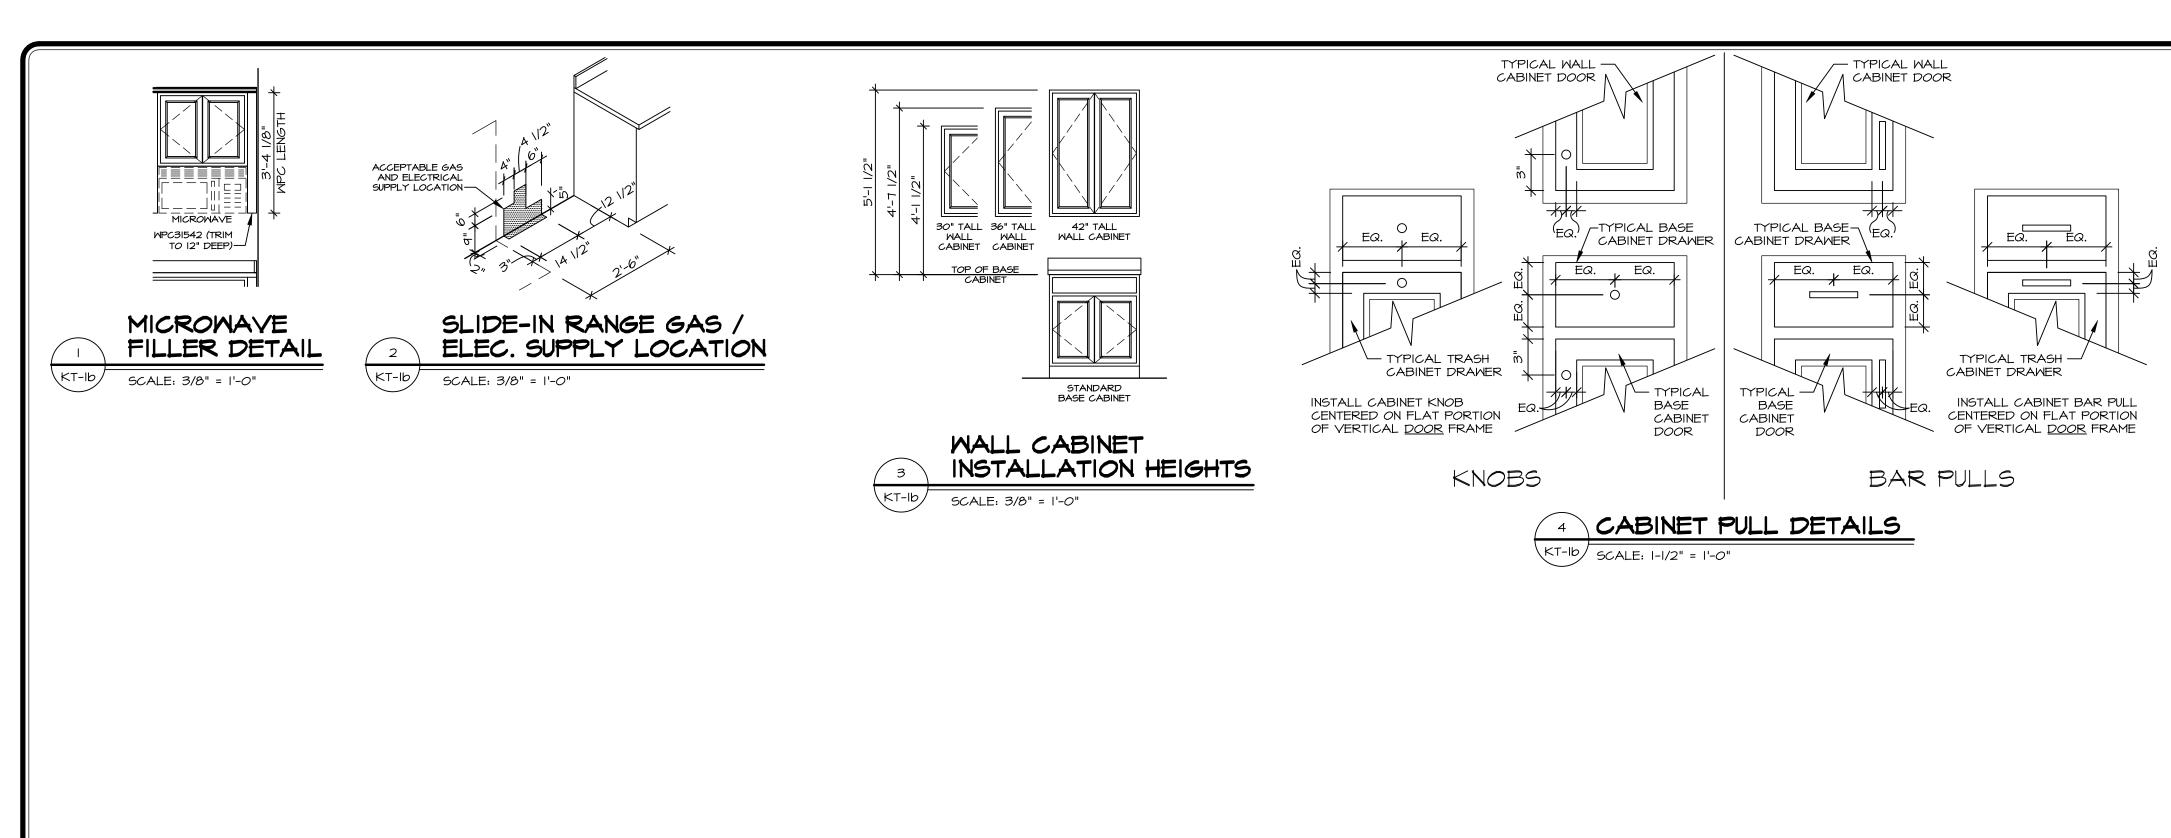
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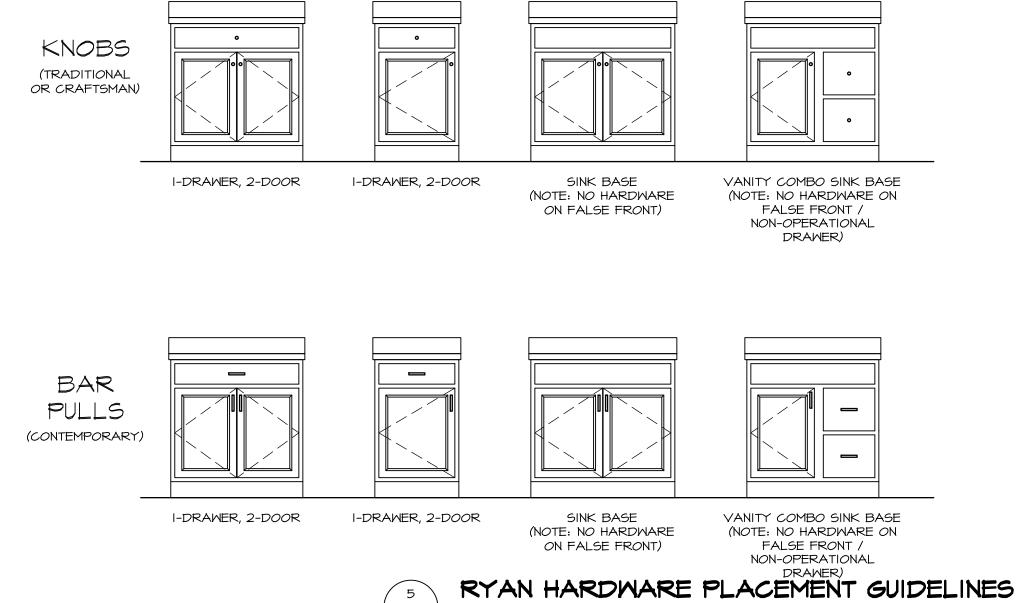
BATH NOTES:

TEMPERED GLASS SHOWER ENCLOSURE WITH SWING DOOR OR OPTIONAL SLIDING DOOR BY DIVISION.
 TUB ACCESS PANELS PROVIDED AS NEEDED, ALL MATERIALS BY DIVISION.
 REFER TO DETAILS IT- FOR TUB AND SHOWER.
 ALL VANITIES WITH DRAWERS TO BE SET WITH DRAWERS ON RIGHT HAND SIDE.
 BATH ELEVATIONS ARE SHOWN PER PLAN.
 ALL DIMENSIONS SHOWN ON BATH ELEVATIONS ARE ROUGH FRAMING REFERENCES ONLY.

DRAWING TITLE
BATH ELEVATION

<u>A-</u>





SCALE: 1/2" = 1'-0"

RYA		BINET HARD	=
		<u>BATH</u>	NON-BATH
TRADITIONAL	DOORS	ROUND KNOBS	ROUND KNOBS
<u>TRADITIONAL</u>	DRAWERS	ROUND KNOBS	ROUND KNOBS
CRAFTSMAN	DOORS	SQUARE KNOBS	SQUARE KNOBS
<u>ORAL ISHIAN</u>	DRAWERS	SQUARE KNOBS	SQUARE KNOBS
	DOORS	BAR PULLS	BAR PULLS
	DRAWERS	BAR PULLS	BAR PULLS
<u>CONTEMPORARY*</u>	HOUSE * DOWNING	SELECTIONS CAN VA AND MADDOX DRAM LESS WILL HAVE A K	IERS THAT ARE 12"
FALSE DOORS A	AND FALSE	DRAWERS DO NOT RE	CEIVE HARDWARE

KNOBS (TRADITIONAL OR CRAFTSMAN)				
	I-DRAWER, 2-DOOR	I-DRAWER, 2-DOOR	SINK BASE	VANITY COMBO SINK BASE
BAR PULLS (contemporary)				

I-DRAWER, 2-DOOR

I-DRAWER, 2-DOOR

HARD	WARE	SPECIFICA	ATIONS
		<u>BATH</u>	NON-BATH
	DOORS	ROUND KNOBS	ROUND KNOBS
TRADITIONAL	DRAWERS AND FALSE DRAWERS	ROUND KNOBS	PULL5
	DOORS	SQUARE KNOBS	SQUARE KNOBS
<u>CRAFTSMAN</u>	DRAWERS AND FALSE DRAWERS	SQUARE KNOBS	SQUARE PULLS
	DOORS	SQUARE KNOBS	BAR PULLS
CONTEMPORARY*	DRAWERS AND FALSE DRAWERS	SQUARE KNOBS	BAR PULLS
	* NOT WITH	SIERRA VISTA CABII	NETS

NOTE:

HARDWARE IS INSTALLED ON ALL DOOR / DRAWER FRONTS (EVEN NON-OPERATIONAL FRONTS.) <u>DO NOT</u> INSTALL HARDWARE ON DECORATIVE DOORS INSTALLED AT THE END OF CABINET RUNS.

NY HOMES HARDWARE PLACEMENT GUIDELINES

SINK BASE

SCALE: 1/2" = 1'-0"

VANITY COMBO SINK BASE

SHEET NO.