

FLOOR PLAN NOTES

- I. ALL HEADERS ARE (2) 2x6 w/ 2x4 WALLS OR (3) 2x6 w/ 2x6 WALLS, UNLESS OTHERWISE NOTED.
- 2. ALL HEADERS TO HAVE (1) 2x4 OR 2x6 JACK EACH END, UNLESS OTHERWISE NOTED.
- 3. ALL EXTERIOR WALLS TO BE 4" AND ALL INTERIOR WALLS TO BE 3 I/2", UNLESS OTHERWISE NOTED

 4. HATCHED ARE IS INDICATE DROPPED CEILINGS. ALL
- 4. HATCHED AREAS INDICATE DROPPED CEILINGS. ALL DROPPED CEILINGS ARE 12" UNLESS OTHERWISE NOTED.
 5. SEE "BRACED WALL PANEL DETAIL SHEET" FOR SPECIAL
- APPLICABLE.

 6. SEE STANDARD DETAIL CATEGORY "IT" SHEET(S) FOR INTERIOR TRIM DETAILS.

WALL FRAMING LOCATIONS AND HEADER SIZES, IF

- INTERIOR TRIM DETAILS.

 7. SEE ARCHITECTURAL DETAIL SHEET "AD" FOR HOUSE SPECIFIC INTERIOR TRIM OPTION TABLE.
- SPECIFIC INTERIOR TRIM OPTION TABLE.

 8. ALL WINDOWS HAVE 7'-0 1/2" HEADER HEIGHT UNLESS OTHERWISE NOTED.

GYPSUM NOTES

AT GARAGE:


GYPSUM BOARD AT COMMON WALLS, CEILINGS, BEAM WRAPS AND SUPPORTS PER STANDARD DETAIL FA-I(b) FIRE ASSEMBLIES OR AS REQUIRED BY LOCAL CODE.


AT STAIRS:


1/2" GYPSUM BOARD AT UNDERSIDE OF STAIRS AND WALLS IN CLOSET

BASEMENT JACK SCHEDULE				
IDENTIFIER	DESCRIPTION	OPTIONS	ENG. NUM.	REMARKS
JOI	JACK - 2×4 SPF STUD GRADE		BI8	
J02	JACK - 2x4 SPF STUD GRADE		B22	



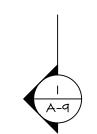


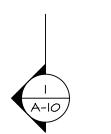

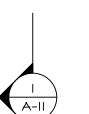



BASEMENT FLOOR PLAN OPTION DESCRIPTION

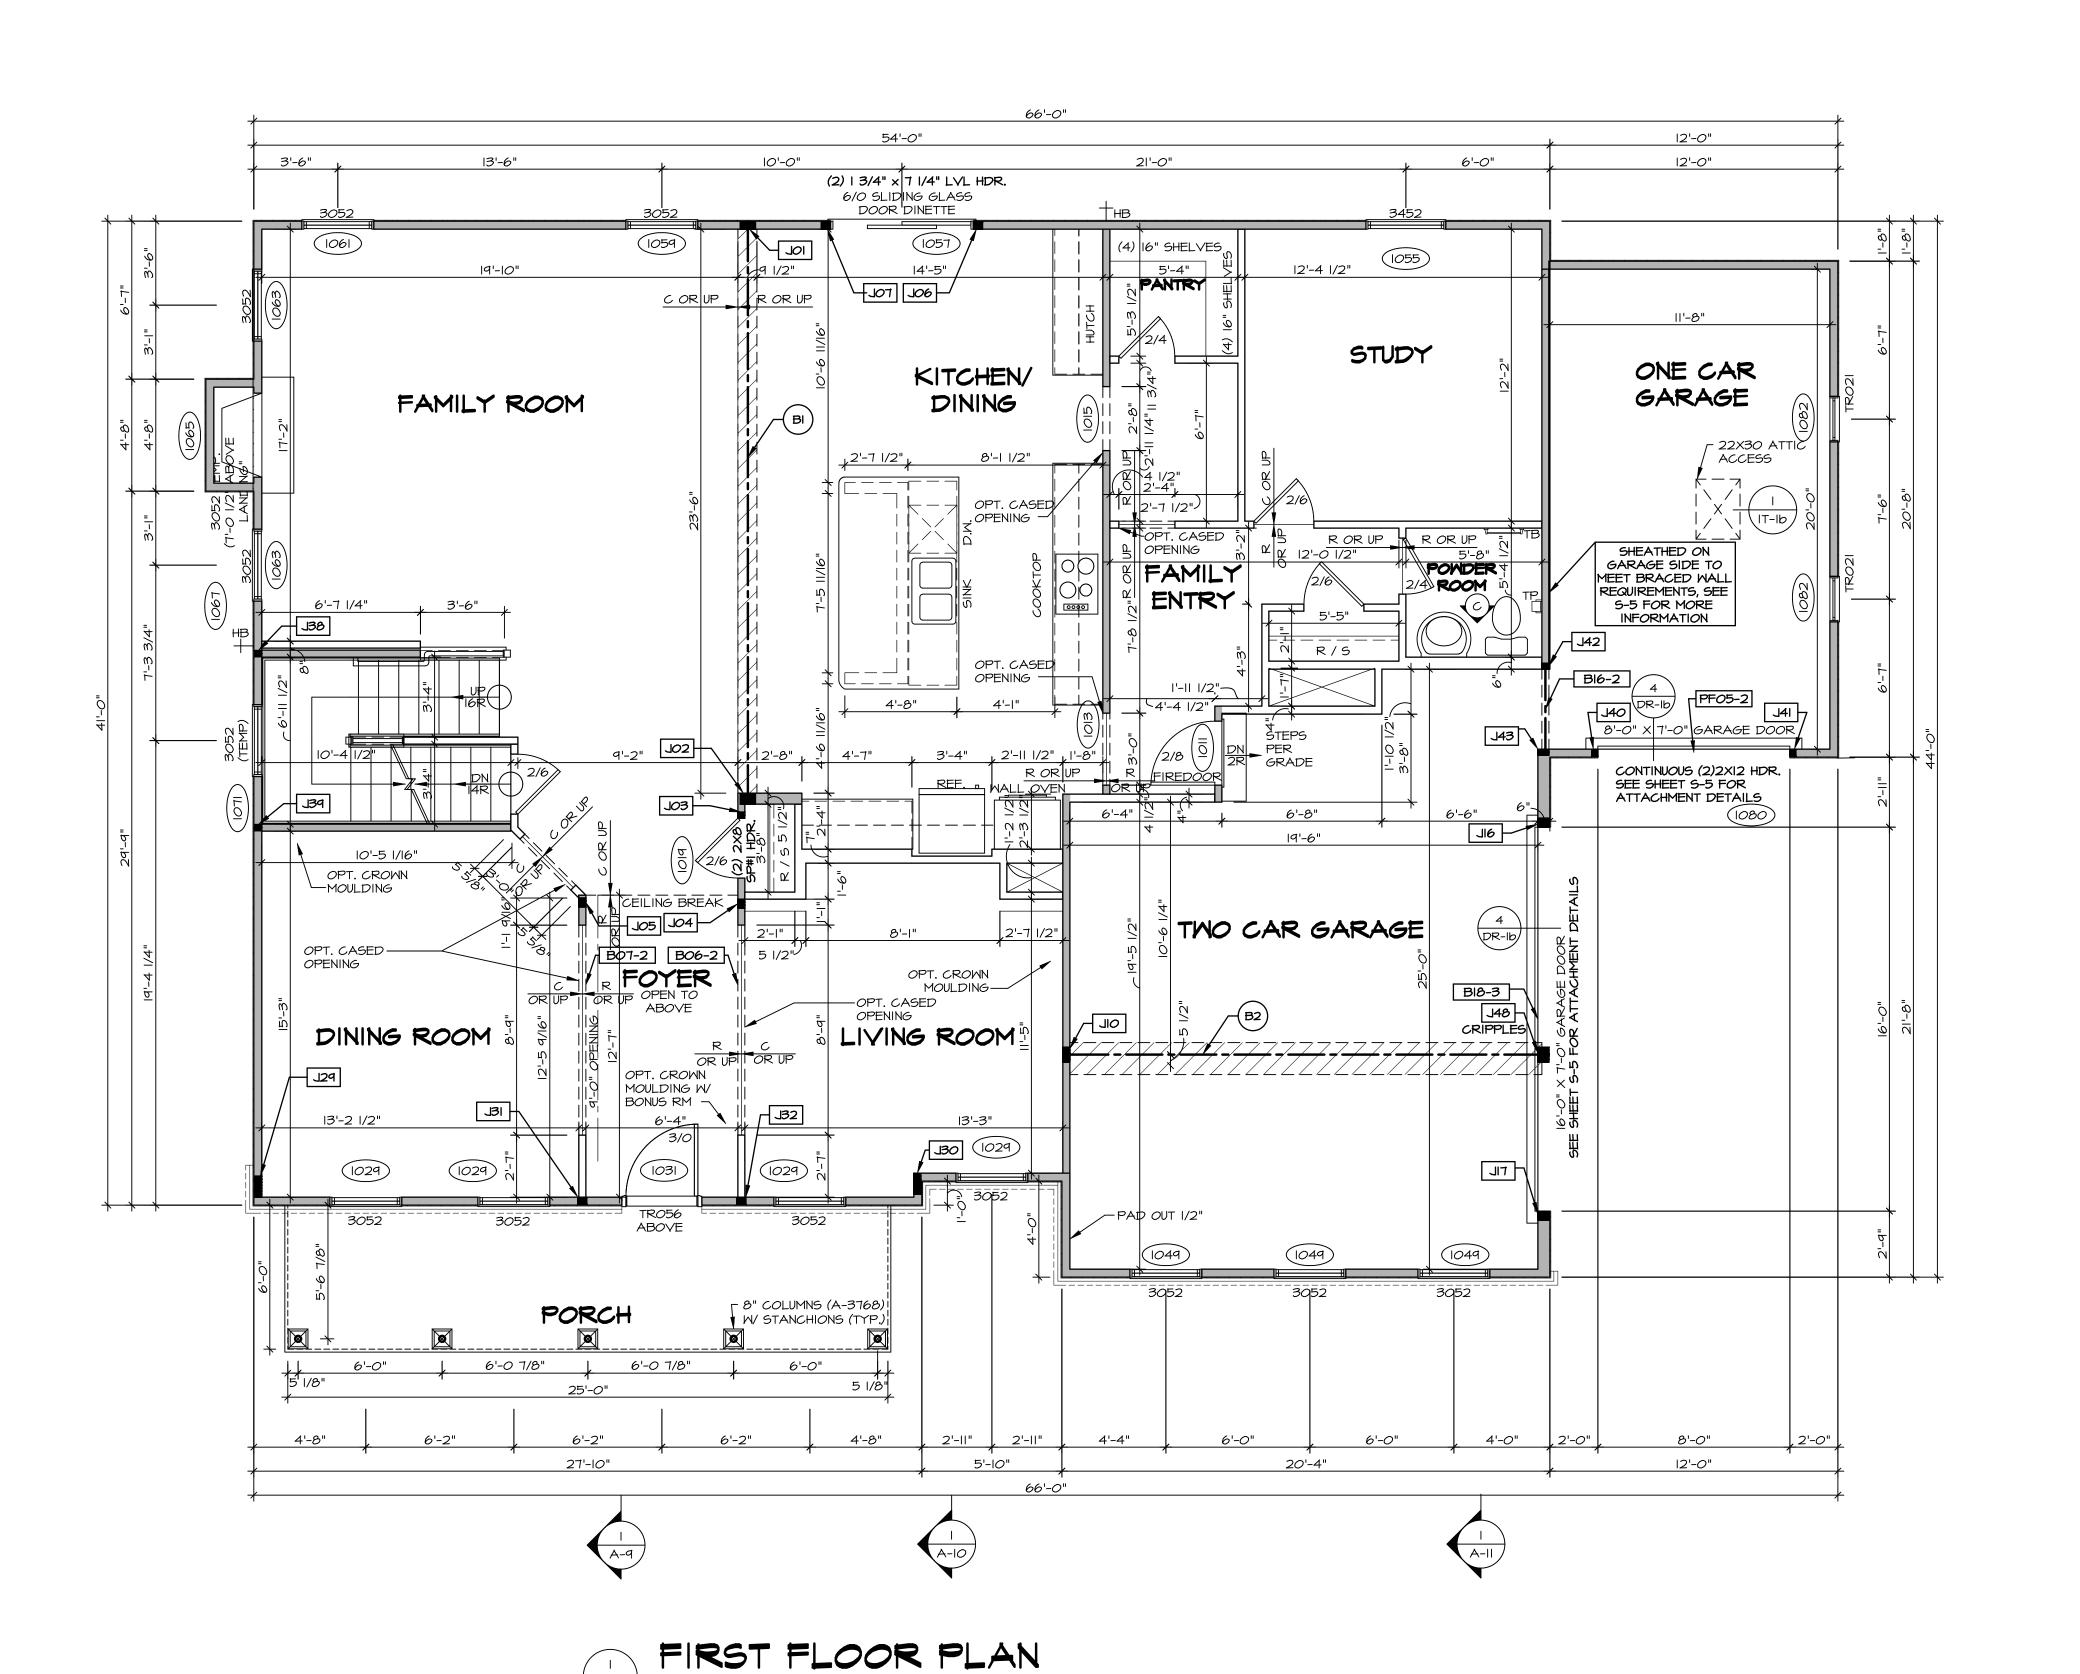

SCALE: 1/4" = 1'-0"

FLOOP

NON BEARING WALL

INDICATES BEARING FR

BEARING WALL

⊗ INDICATES BEARING FROM POINT-LOAD ABOVEJ_ JACKS

B_ BEAM/HEADER

LEGEND

PAD FOOTING

STEEL COLUMN

X PORTAL FRAME

X JOIST/TRUSS

_____ LVL

X ENGINEERING PAGE NUMBER
SEE FC DETAILS FOR
FRAMING CONNECTORS

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2. ALL HEADERS TO HAVE (1) 2x4 OR 2x6 JACK AND KING STUD EACH END, UNLESS OTHERWISE NOTED.

3. ALL EXTERIOR WALLS TO BE 4" w/ OSB OR 3 I/2" w/ T-PLY, ALL INTERIOR WALLS TO BE 3 I/2", UNLESS OTHERWISE NOTED.
4. HATCHED AREAS INDICATE DROPPED CEILINGS. ALL DROPPED CEILINGS ARE I2" UNLESS OTHERWISE NOTED.

5. SEE "BRACED WALL PANEL DETAIL SHEET" FOR SPECIAL WALL FRAMING LOCATIONS AND HEADER SIZES, IF APPLICABLE.
6. SEE STANDARD DETAIL CATEGORY "IT" SHEET(S) FOR INTERIOR TRIM DETAILS.

SEE ARCHITECTURAL DETAIL SHEET "AD" FOR HOUSE SPECIFIC INTERIOR TRIM OPTION TABLE.
 ALL WINDOWS HAVE 7'-O I/2" HEADER HEIGHT UNLESS OTHERWISE NOTED.
 ALL HEADERS IN NON-BEARING WALLS SHALL BE A SINGLE FLAT 2X4 OR 2X6 ATTACHED TO CRIPPLES

GYPSUM NOTES RYAN

AT GARAGE:

AT STAIRS:

GYPSUM BOARD AT COMMON WALLS, CEILINGS, BEAM WRAPS AND SUPPORTS PER STANDARD DETAIL FA-I(b) FIRE ASSEMBLIES OR AS REQUIRED BY LOCAL CODE.

ABOVE, UNLESS OTHERWISE NOTED.

1/2" GYPSUM BOARD AT UNDERSIDE OF STAIRS AND WALLS IN CLOSET

LVL PLY TO PLY FASTENING SCHEDULE: (WHERE APPLICABLE BASED ON LVL USAGE)

I.A - (2) PLY UP TO AND INCLUDING II 7/8" TALL: FASTEN PLIES W/ (2) ROWS I6D NAILS AT I2" O.C. 2.A - (2) PLY I4" TO AND I8" TALL (INCLUSIVE): FASTEN PLIES W/ (3) ROWS I6D NAILS AT I2" O.C. 3.A - (2) PLY 20" TALL AND OVER: FASTEN PLIES W/ (4) ROWS I6D NAILS AT I2" O.C.

4.A - (3) PLY UP TO AND INCLUDING II 7/8" TALL: FASTEN PLIES W/ (2) ROWS 16D NAILS AT 12" O.C. FROM EACH SIDE

5.A - (3) PLY 14" TO AND 18" TALL (INCLUSIVE): FASTEN PLIES W/ (3) ROWS 16D NAILS AT 12" O.C. FROM EACH SIDE
6.A - (3) PLY 20" TALL AND OVER: FASTEN PLIES W/ (4) ROWS 16D NAILS AT 12" O.C. FROM EACH S

6.A - (3) PLY 20" TALL AND OVER: FASTEN PLIES W (4) ROWS 16D NAILS AT 12" O.C. FROM EACH SIDE 7.A - (4) PLY (ALL SIZES): FASTEN PLIES W (2) ROWS 1/2" DIAMETER A307 BOLTS AT 24" O.C. SEE SHOP DRAWING FOR ADDITIONAL INFORMATION.

SLL :	SEE SHOP DRAMING FOR ADDITIONAL INFORMATION.				
F	FIELD INSTALLED FIRST FLOOR BEAM/HEADER SCHEDULE				
IDENTIFIER	DESCRIPTION	LENGTH	OPTIONS	ENG. NUM.	REMARKS
B06-2	LVL - II-l4	12'-8 1/2"	SRW, SQK, SQL, ELC	1017	I.A
B07-2	LVL - II-14	12'-9 1/16"	SRW, SQK, SQL, ELC	1017	I.A
BI	BEAM STEEL - WI2X35	24'-2"		1021	
Bl6-2	LVL - II-I4	3'-10"	MAS,GAA,FBA	1077	I.A
BI8-3	LVL 1.75 - 18	16'-9"	GCC, GAA	1051	5.A
B2	BEAM STEEL - WI2X26	20'-2 1/2"	SRI	1022	
PF05-2	EXT HEADER - 2XI2 - 2 PLY	11'-9"	GCF	1045	PORTAL FRAME

	FIRST FLOOR JA	KCK SCHEDULE		
IDENTIFIER	DESCRIPTION	OPTIONS	ENG. NUM.	REMARKS
IOL	JACK - (5) 2X4 SP#I		1021	
J02	JACK - (5) 2X6 SP#I		1021	
J03	JACK - (2) 2X4 SPF STUD GRADE		1019	
J04	JACK - (3) 2X4 SPF STUD GRADE		1017	
J05	JACK - (3) 2X4 SPF STUD GRADE		1017	
J06	JACK - (3) 2X4 SPF STUD GRADE		1057	
JOT	JACK - (3) 2X4 SPF STUD GRADE		1057	
OIL	JACK - (5) 2X4 SP#I	SRI	1023	
JI6	JACK - (3) 2X6 SPF STUD GRADE	GCC, GAA	1051	
TIL	JACK - (3) 2X6 SPF STUD GRADE	GCC, GAA	1051	
J29	JACK - (7) 2X4 SP#I	ELC	2000	
J30	JACK - (7) 2X4 SP#I	ELC	2000	
J3I	JACK - (3) 2X4 SPF STUD GRADE	SRW, SQK, SQL, ELC	1017	
J32	JACK - (3) 2X4 SPF STUD GRADE	SRW, SQK, SQL, ELC	1017	
J38	JACK - (2) 2X4 SPF STUD GRADE		1007	
J39	JACK - (2) 2X4 SPF STUD GRADE		1007	
J40	JACK - (2) 2X4 SPF STUD GRADE	GCC, GAA	1079	

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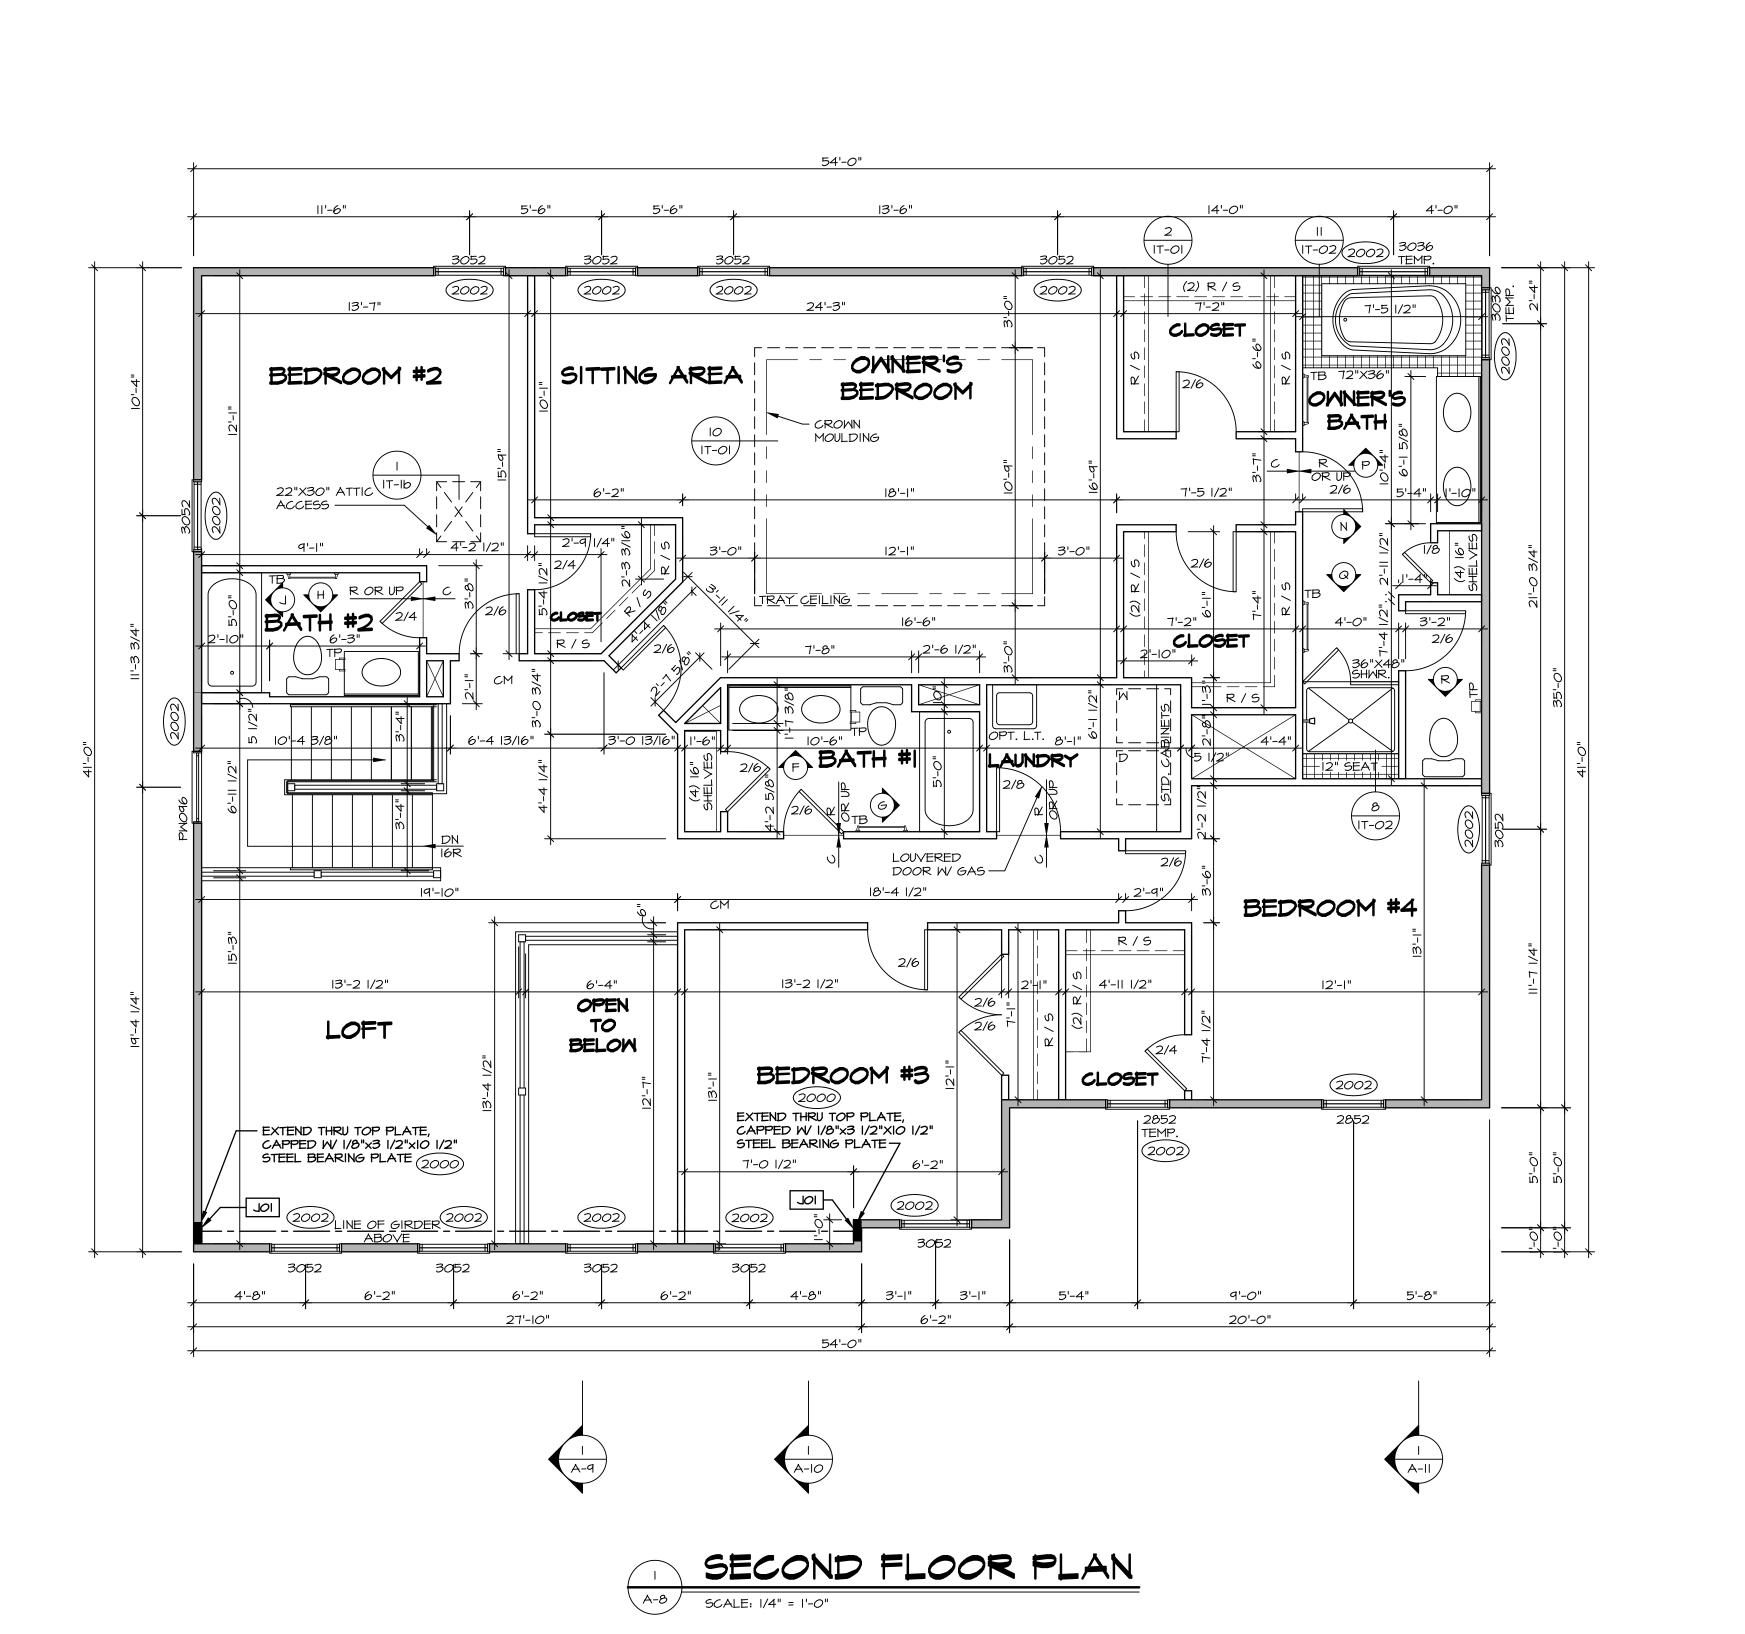
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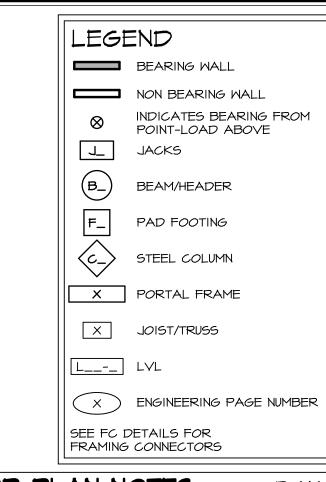
NVR, Inc.
Architectural Services
Architects
5285 Westview Drive, Suite 100
Frederick, MD 21703

VERSION OI DRAWN BY SGA DATE: 6/29/15 OPTION

OR PLAN

4





FLOOR PLAN NOTES RYAN

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SECOND FLOOR JACK SCHEDULE					
IDENTIFIER	DESCRIPTION	OPTIONS	ENG. NUM.	REMARKS	
IOL	JACK - (7) 2X4 SP#1	ELC	2000		
J02	JACK - (7) 2X4 SP#1	ELC	2000		

SET NO. NRMOO

VERSION OI


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DATE: 6/29/I5

NVR, Inc.


Architectural Services

Architectur

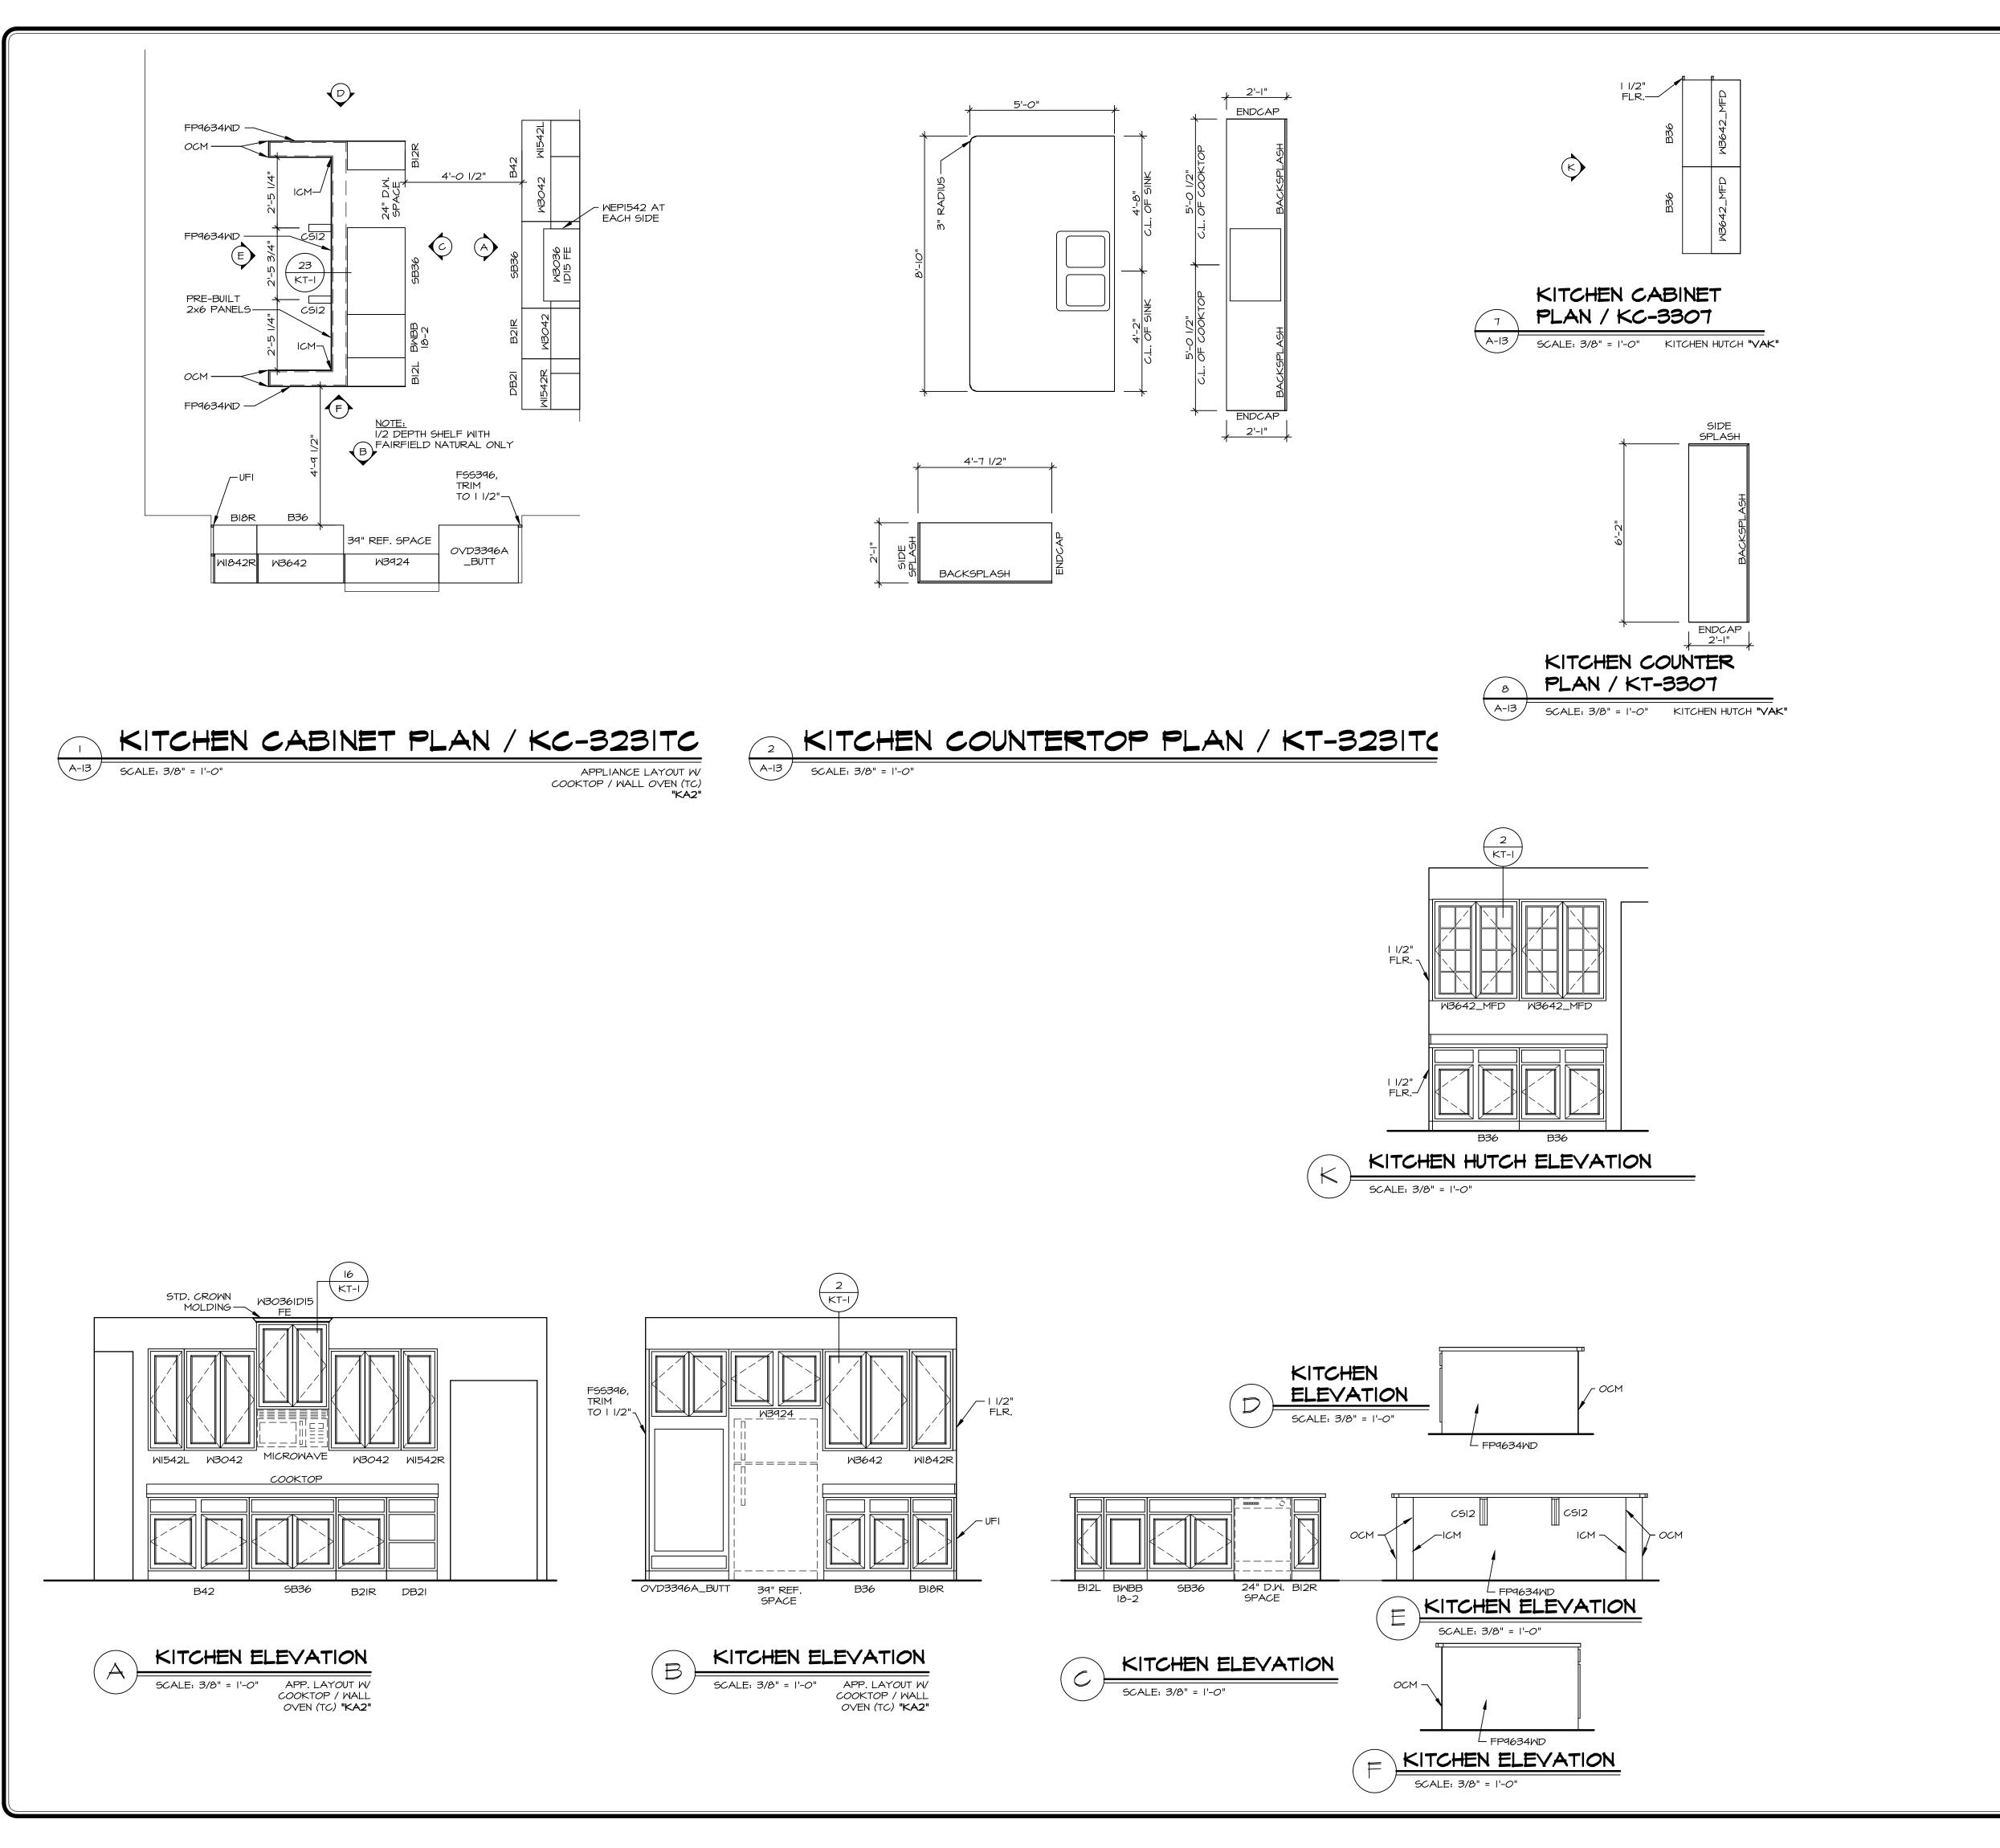

— UF6 RIPPED TO 3 1/2" LAUNDRY CABINET PLAN KC-3281

SCALE: 3/8" = 1'-0"

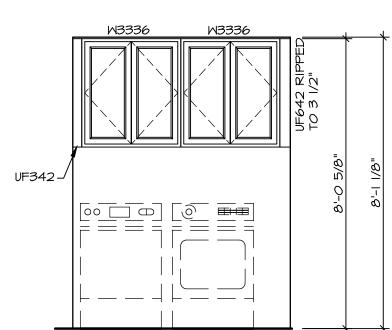

LAUNDRY CABINET ELEVATION

SCALE: 3/8" = 1'-0"

I. CABINET LAYOUT (5) ARE BASED ON FINISHED DIMENSIONS TO DRYWALL.

ON CABINET SYLE.


AND PLUMB W/ ADJOINING BASE CABINETS.


5. SET PRE-FINISHED SCRIBE MOLDING AT
CABINET BULKHEADS AND AT ENDS (WHERE
CABINETS MEET DRYWALL.) PRE-FINISHED SCRIBE MOLDING SHALL BE USED TO PAD OUT CABINET SIDES AT STILE FOR RETURN PIECES OF THE FACE-MOUNTED CABINET


DRAWER FRONTS AND DOORS GET (I) KNOB/ PULL. NO HARDWARE ON FALSE DRAWER FRONTS.


2. IF KITCHEN PLANS/ELEVATIONS CALL-OUT STANDARD MOLDING, REFER TO STANDARD DETAIL (II/KT-I) FOR REPLACEMENT BASED 3. ALL (UF#) FILLERS ARE TO BE "TRIM TO FIT" UNLESS OTHERWISE NOTED.
4. CABINET MUST BE SET, SHIMMED, LEVELED CROWN MOLDING.


6. HARDWARE INSTALL NOTE: KNOBS GO ON DOORS AND DRAWERS FOR ALL AREAS. ALL

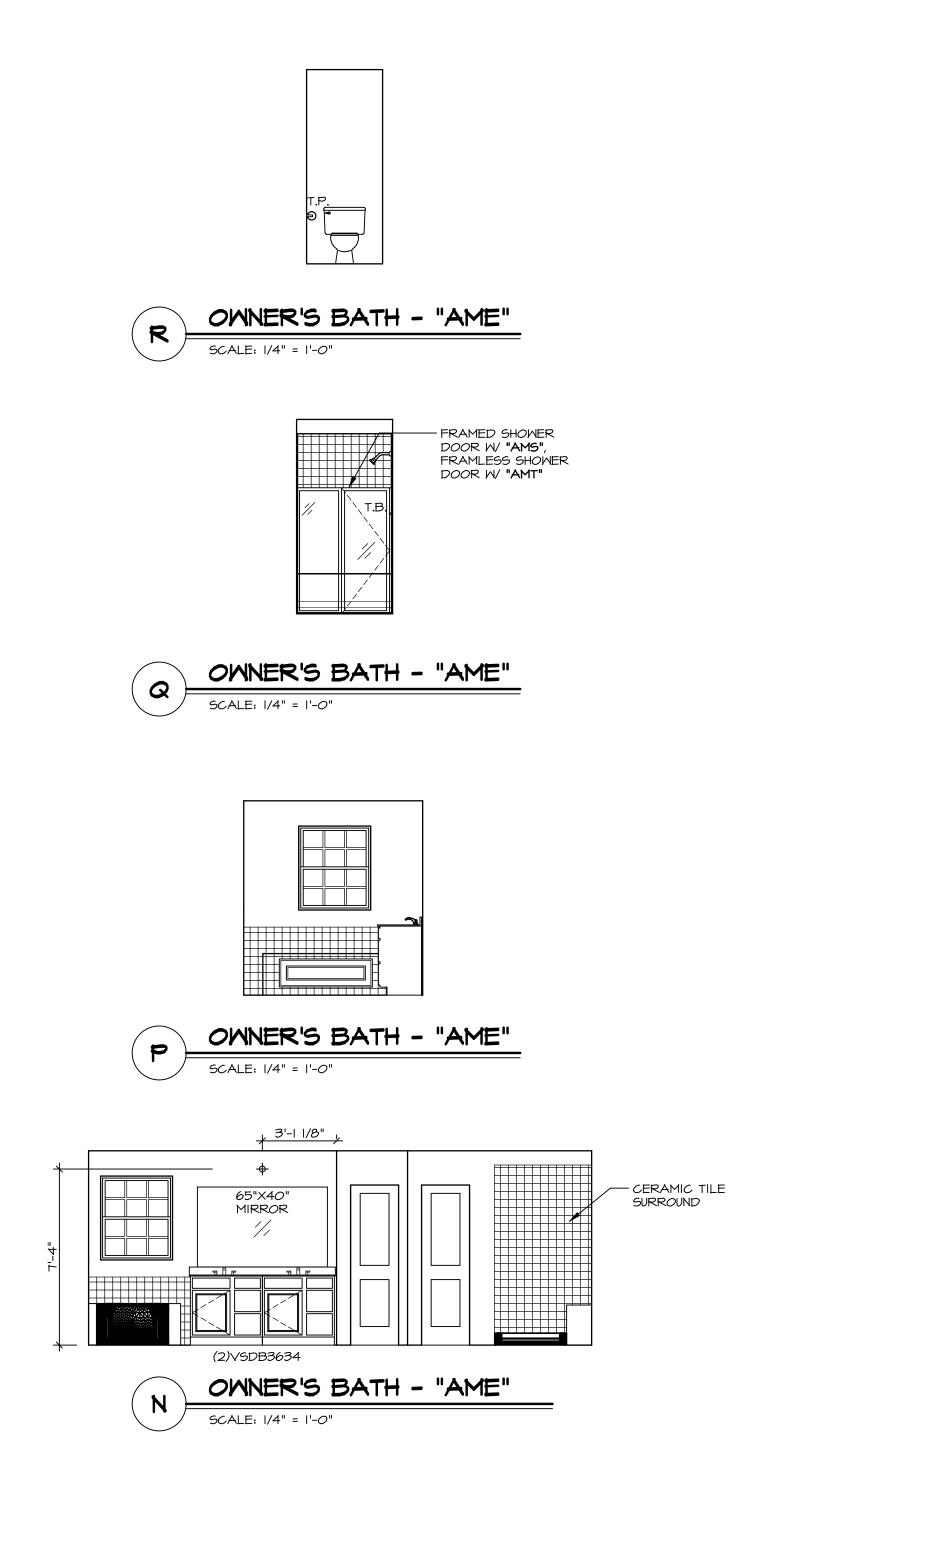

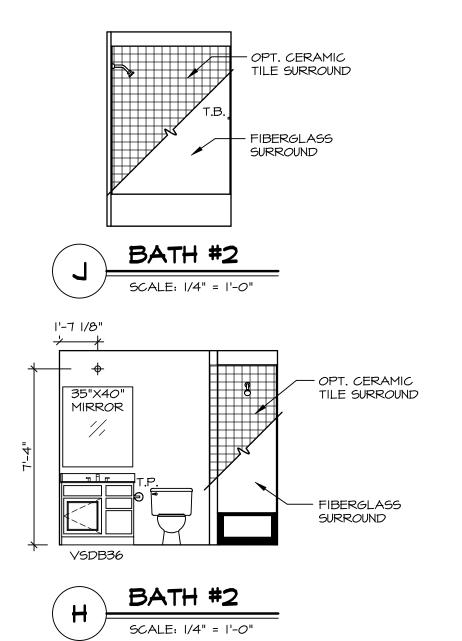

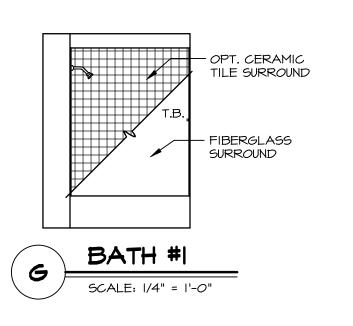

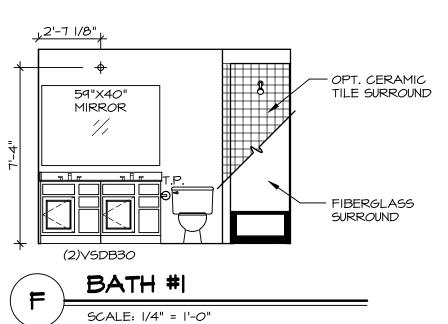


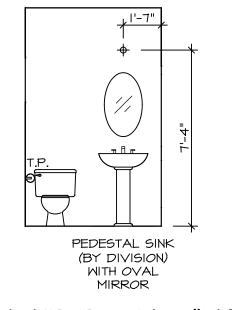




NOTES:

- I. TEMPERED GLASS SHOWER
 ENCLOSURE WITH SWING DOOR OR
 OPTIONAL SLIDING DOOR BY DIVISION
- 2. TUB ACCESS PANELS PROVIDED AS NEEDED, ALL MATERIALS BY DIVISION
- 3. REFER TO SHEET (IT-2) FOR TUB AND
- SHOWER DETAILS. 4. ALL VSDB24-42 DRAWERS TO BE SET ON
- RIGHT HAND. 5. BATH ELEVATIONS ARE SHOWN PER PLAN.

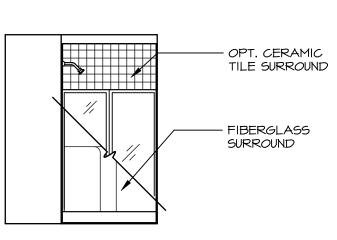



SCALE: 1/4" = 1'-0"

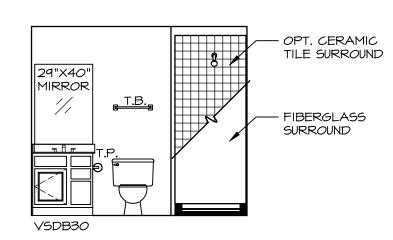



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NORMANDY
DRAWING TITLE
BATH ELEVATIONS

